



April 24, 2024

To Whom It May Concern:

The City of Dover will receive sealed proposals on May 22, 2024, at 2:00 PM local time for the purpose of contracting for **GARRISON OAK STEEL PROJECT, RFP NUMBER 24-0037EL.** The proposal must be submitted with three (3) paper copies and one (1) electronic copy on either a CD/DVD or flash drive in a sealed envelope to: City of Dover Procurement Office, 710 William Street, Dover, DE 19904. All vendors must complete the request for proposal (RFP) notice and send it via email to <u>doverwhse@dover.de.us</u> or by fax to (302) 736-7178 if they intend to submit a proposal. Any vendor not returning the form may not receive published addenda.

Your submission is not revocable for ninety (90) days following the response deadline indicated above.

LATE SUBMISSIONS:

A proposal received after the closing date and time for receipt of the proposals is late and shall not be considered. It is the responsibility of the submitter to ensure that the proposal is received prior to the closing date and time.

QUESTIONS:

If you have questions concerning this Request for Proposal, they must be made in writing and emailed to me at <u>doverwhse@dover.de.us</u>. All questions must be submitted no later than May **8, 2024.** All questions will be compiled and answered in the form of an addendum and will be emailed to all prospective proposers who return the attached RFP notice and will be posted on the City of Dover web site, <u>https://www.cityofdover.com/bid-procurement</u>. All changes or corrections to this Request for Proposal will be handled by addenda issued by the Purchasing Office. The receipt of all addenda must be acknowledged in the proposal submission.

The City of Dover reserves the right to request corrections, clarifications, and/or additional information pertaining to the proposer's response.

Proposals will be opened publicly at the time and place designated in this letter. All proposals will be opened in the presence of the Procurement Manager or his/her designee. All other information contained in the proposals shall be considered confidential to avoid disclosure of contents prejudicial to competing offerors during the process of negotiation. The main purpose of the RFP opening is to reveal the name(s) of the proposer(s), not to serve as a forum for determining the award.

The contract shall be awarded within 90 days of the closing date to the offeror whose proposal is determined in writing to be most advantageous to the City. All prices must be held firm for a

minimum of 90 days from the date of the opening. The proposals and summaries shall not be open for public inspection until after receipt of a fully executed contract.

Public employees and elected officials must discharge their duties impartially so as to assure competitive access to governmental procurement by responsible contractors. Moreover, they should conduct themselves in such a manner as to foster public confidence in the integrity of City procurement. Dover Code Article II Section 30 (Appendix A of this policy), establishes standards of ethical conduct among public officials and employees. <u>Vendors participating in the City procurement will be disqualified from the procurement if the employee, official or vendor is found to be in violation of the City's ethical standards and a referral of the matter will be presented to the <u>Ethics Commission</u>.</u>

Please reference the City of Dover Purchasing Policy if you have any questions at: <u>https://www.cityofdover.com/media/Purchasing/Policy/Purchasing%20Policy%20Final%2005-23-2022.pdf</u>.

The City of Dover reserves the right to waive technicalities, to reject any or all submissions, or any portion thereof, to advertise for new proposals, to proceed to do the work otherwise, or to abandon the work, if in the best interest of the City.

All vendors must completely fill out, sign, date, and return the attached "Consent for Disclosure Under the Freedom of Information Act (FOIA)" form with their submission. Failure to return the completed form will be deemed consent to the disclosure of all information included in the submission after the receipt of a signed contract or issuance of a purchase order. Any and all proprietary information contained within the bid must be isolated and clearly marked. The cover must indicate that the bid contains such information.

Minority, women, veteran, service-disabled veteran, and individuals with disabilities owned vendor preference shall be three percent (3%) of the value of the award. <u>The vendor must</u> <u>identify qualification and claim to the preference on the submitted proposal documents.</u> The vendor must provide authoritative proof of minority ownership such as identification in the certification directory maintained by the State of Delaware Office of Supplier Diversity to qualify for this preference. This preference is to be considered as a stand-alone and cannot be added to any other preference that may be allowed. This preference shall not apply to subcontractors.

Local vendor preference shall be considered for materials, equipment, construction contracts, and utility contracts. Local vendor preference shall be three percent (3%) of the annual value of the award. The term local vendor is defined as a gradually increasing range with preference assigned as follows:

Rule 1: Vendor located within the city limits of the City of Dover.

Rule 2: Vendor located within Kent County, Delaware (applicable only if no vendor qualifies under rule 1)

Rule 3: Vendor located within the State of Delaware (applicable only if no vendor qualifies under rules 1 & 2)

In the event that no vendor qualifies under rules 1, 2, or 3, no local vendor preference will be awarded. <u>The vendor must identify qualification and claim to the preference on the</u> <u>submitted proposal documents.</u> This preference is to be considered as stand-alone and cannot be added to any other preference that may be allowed.

A performance bond shall be required from the successful proposer for a construction contract. Such a bond shall be for the full amount of the contract. If the contractor fails to provide such a bond or a binder within fifteen days of the award of the contract, the award of the contract or the contract shall be void. The bond shall be released by the City of Dover upon successful completion of the contract and upon a detailed inspection of the contracted work.

In the event the contractor does not fulfill its obligations under the terms and conditions of this contract, the City of Dover may contract for an equivalent product on the open market. Any difference in cost between the contract prices herein and the price of open market product shall be the responsibility of the contractor. Under no circumstances shall monies be due the contractor in the event open market products can be obtained below contract cost. Any monies charged to the contractor may be deducted from an open invoice.

Neither the contractor nor the City of Dover shall be held liable for non-performance under the terms and conditions of this contract due but not limited to, government restriction, strike, flood, fire, or unforeseen catastrophe beyond either party's control. Each party shall notify the other in writing of any situation that may prevent performance under the terms and conditions of this contract.

Vendors must provide references to the City of Dover upon request. Vendor references may be checked to verify the proposer's ability to perform the contract requirements, the quality of work, and the ability to meet obligations.

ENVELOPES MUST BE MARKED "GARRISON OAK STEEL PROJECT, RFP NUMBER 24-0037EL." No faxed or emailed proposals will be accepted.

The City of Dover shall have the right to reject any or all proposals if deemed to be in the best interest of the City, such as but not limited to local vendor preference and minority vendor preference while awarding.

Sincerely,

Barry Wolfgang Contract and Procurement Manager City of Dover (302) 736-7795 www.cityofdover.com





Pover

REQUEST FOR PROPOSAL NOTICE

RFP Number: 24-0037EL

RFP Opening: <u>May 22, 2024 at 2:00 P.M.</u>

Description: Garrison Oak Steel Project

If you are interested in the Request for Proposal described above, you can download it in Adobe PDF format from our web site <u>http://www.cityofdover.com/bid-procurement</u>. Any amendments or other additional information related to this solicitation will be posted with the original document on the web site.

If you do not have internet access and want to receive this Request for Proposal, all subsequent amendments, or additional information on the RFP package, please provide the requested information to:

The City of Dover Purchasing Office 710 William Street Dover, DE 19904 Fax: (302) 736-7178, attention Procurement Manager E-mail: doverwhse@dover.de.us

Please complete the following and return this form to the City of Dover Purchasing Office.

Company:	 Vendor Response /Request
Address	 No submission at this time, please retain on vendor list
	 Please send complete RFP package
Contact:	 I will download the RFP package
Phone	 l intend to submit
Email	 I do not intend to submit



CONSENT FOR DISCLOSURE UNDER THE FREEDOM OF INFORMATION ACT (FOIA)

REQUESTS FOR PROPOSAL AND INVITATIONS TO BID

From time to time, the City of Dover receives requests under the Freedom of Information Act (FOIA) for information submitted in response to Requests for Proposals and Invitations to Bid. This information shall be provided to those who request it under FOIA; however, in accordance with 29 **Del. C.** §10002(1)(2), trade secrets and commercial or financial information obtained from a person which is of a privileged or confidential nature are not deemed public records.

Please indicate your preference regarding the disclosure, under FOIA, of the information that you are submitting by checking the appropriate box and providing the information below. Please note that prior to issue of a purchase order or full execution of a contract, only the names of vendor(s) and bid tabulations will be released for Invitations to Bid, and only the names of vendor(s) and information deemed necessary for City Council to make an informed decision on award approval will be released for Requests for Proposals.

I consent to the disclosure of all information included in this submission.

This submission includes trade secrets and commercial or financial information which is of a privileged or confidential nature that is exempt from disclosure under 29 **Del. C.** §10002(l)(2). In accordance with 29 **Del. C.** §6923(j)(4) and §6924(j)(3), I have isolated and identified in writing the confidential portions of the submitted proposal/bid and attached a statement that explains and supports my claim that the proposal/bid items identified as confidential contain trade secrets or other proprietary data and I am prepared to defend against disclosure. I understand that any items not so identified are subject to disclosure.

Name:	
Signature:	Date:
Title/Position:	
Company Name:	
Email Address:	Telephone:
Mailing Address:	
RFP/Bid No.	
For additional information, please contact:	City of Dover - City Clerk's Office P.O. Box 475 Dover, DE 19903 <u>cityclerk@dover.de.us</u> Phone (302) 736-7008; FAX: (302) 736-5068

Please note that this form is a public record and will be provided to those who request information regarding Requests for Proposals and Invitations to Bid under FOIA.

P.O.Box475~Dover, Delaware 19903-0475 Community Excellence Through Quality Service **CITY OF DOVER, DELAWARE**

REQUEST FOR PROPOSALS

FOR

GARRISON OAK STEEL

RFP 24-0037EL



April 2024

Issued By:

City of Dover Purchasing Office 710 William Street Dover, Delaware 19904 (302) 736-7795

Prepared By:

City of Dover Electric Department 860 Buttner Place Dover, DE 19904 (302) 736-7070

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APPENDIX

Appendix A

SECTION RFP

REQUEST FOR PROPOSALS

Sealed proposals will be received on behalf of the City of Dover Electric Department, (hereinafter called the "CoD") at the City of Dover Procurement Office, 710 William Street, Dover, DE 19904 no later than 2:00 p.m. EST on Wednesday, May 22, 2024. Proposals will then be publicly opened and read aloud immediately thereafter for the following:

GARRISON OAK STEEL Proposal No.: 24-0037EL Contract Duration: Until Completion of Commissioning

The City of Dover (CoD) Electric Department is soliciting written proposals from qualified firms to fabricate a steel structure for the Garrison Oak substation build. The primary objectives of the project are to:

- 1. Fabricate all steel materials referenced in attached documents. Bill of Material for steel can be found in the drawing A0500, Line ASE- Items A-H, K, P & R.
- 2. All materials are required to adhere to the Build America, Buy America (BABA) Act. https://www.energy.gov/management/build-america-buy-america

All requirements are described in the proposal documents entitled, GARRISON OAK STEEL, Request for Proposal, RFP No.: 24-0037EL.

The right is reserved, as the interests of the City of Dover may appear, to reject any and all proposals, to waive any information in proposals received, and to accept or reject any item(s) of any proposal.

City of Dover, Delaware

By Barry Wolfgang Contract and Procurement Manager City of Dover

END OF SECTION

SECTION IFP

INVITATION FOR PROPOSALS

RFP NUMBER: 24-0037EL

Sealed Proposals, three (3) paper copies and one (1) electronic copy, will be received by the City of Dover Procurement Office, 710 William Street, Dover, DE no later than **2:00 P.M.** on **Wednesday, May 22, 2024**, for the **GARRISON OAK STEEL project**, at which time the proposals will be opened.

I. NAME OF SOLICITING GOVERNMENT

City of Dover, Delaware City Hall – The Plaza P.O. Box 475 Dover, Delaware 19903-0475

II. PURPOSE OF REQUEST

- A. The City of Dover Electric Department is in the process of upgrading the electrical network and constructing a new electrical substation located at the corner of Garrison Oak and White Oak Roads. The steel needs to be fabricated for the structural aspect of supporting electric cables and other electrical materials such as transformer stands, and circuit breakers. Aubrey Silvey Engineering has provided specifications for steel materials.
- B. Delivery of the steel materials within this project will be at the earliest possible convenience, with a tentative goal of September 1, 2024.
- C. The City of Dover invites written proposals from qualified, Delaware licensed firms, which are interested in providing services, as outlined below.
- D. All materials are required to adhere to the Build America, Buy America (BABA) Act. https://www.energy.gov/management/build-america-buy-america

III. GENERAL CONDITIONS

A. <u>Current configuration is as follows:</u>

- 1. The Garrison Oak Substation is in the process of being constructed. The switchgear is expected to be delivered to the construction site approximately August 2024. The City of Dover Substation Technicians will erect and install the steel into the substation.
- 2. Technicians will be required to attend a safety briefing before entering the electrical substation. The training will be documented and provided by COD personnel.
- 3. Site visit prior to submitting proposal is preferred, but not mandatory. Please contact 302.674-7568 for coordination. Must provide at least 48 hours' notice.

B. Project Management and Administration

- 1. Project Management: The Proposer will monitor the progress of the project described below. Management responsibilities will include project scheduling and coordination, client contact, and supervision of the daily activities involved in the project.
- 2. Project Meetings: The Proposer will attend meetings with the City as it requires.
- 3. Project Support: The Proposer will provide the typing, filing, binding and copying of the various documents required for this project. The Proposer will provide a minimum of three (3) copies and one (1) electronic copy of the various documents required for this project to the City.

IV. SCOPE OF WORK

- A. The project includes the fabrication of steel materials specified in the attached documents.
- B. The CoD seeks a single Vendor who can meet or exceed the requirements of this RFP and who can supply the materials and provide technical assistance when needed.
- C. This RFP represents an effort undertaken by the CoD to provide a comprehensive specification with the goal of establishing a new electrical substation.
- D. Should the Vendor feel that it is appropriate to propose more than one solution; the CoD will entertain multiple responses to this RFP so long as they meet the specifications contained herein. The Vendor shall clearly indicate the major advantages and disadvantages of each response. This RFP is not a contract offer, and no contract will exist unless and until a written contract is signed by the CoD and the successful proposer.
- E. Interested parties should submit a proposal in accordance with the requirements and directions contained in this RFP. Proposers are prohibited from contacting any CoD employee, officer or official concerning this RFP, except the Designated Contact Person listed in this document. A proposer's failure to comply with this requirement may result in disqualification.

V. QUALIFICATIONS

- A. <u>Firm Identification</u>. The following questionnaire has been provided by the City of Dover. Please complete in typewritten form. Three (3) paper copies and one (1) electronic copy are to be submitted in the order outlined below. Illustrated brochure(s) and professional records may be attached and submitted to augment the data included in this questionnaire. Attach additional sheets as required or desired.
 - 1. Firm Name
 - 2. Established Year, State

- 3. Home office business address and telephone number
- 4. Branch office business address and telephone numbers
- 5. Key personnel to be involved in the performance of services: Name, Title, Years of experience
- 6. Provide a list of Municipal State, and Federal references which can be contracted.
- 7. Proof of insurance, complying with the **Instructions to Proposers** Section, including the following documentation:
 - Certificate of Insurance
 - Declaration Page
 - Insurance policy documents
- 8. Provide a copy of your firm's Affirmative Action and Equal Opportunity practices.
- 9. Please indicate if you are aware of any personal or organizational conflicts of interests. Provide an explanation of your firm's (or any sub-consultants that your firm is using in provision of these services) involvement in ongoing or pending litigation, claims, suits against the City of Dover, if any.
- 10. Provide and additional information which you feel may be pertinent to the provision of these services, but not specifically required elsewhere in the RFP.
- 11. The selected bidder is required to provide a City of Dover business license or prove they can obtain within thirty (30) calendar days.
- B. <u>Statement of Understanding.</u> State your understanding of the scope of services presented in the RFP and your role in accomplishing the scope of services.

VI. COMPENSATION

A. The proposal should clearly state the fees to be charged for the proposed work and should be provided on the attached Proposal Form. Contractor is responsible for paying all permit fees and any and all costs associated with actions required to be taken if this work requires a permit. Contractor is responsible for disposal costs for any material removed from the city as related to the project.

VII. SELECTION CRITERIA

A. In order to ascertain which proposal best meets the needs of the City, proposals will be independently evaluated, according to the following criteria, by two (2) or more qualified individuals of the City's staff:

	Factor	Point Range
A	Experience: The Proposer shall provide examples of relevant experience in successfully completing work like that identified in this project.	0 to 40
В	Cost: Overall all in equipment, labor and associated costs related to the design, shipment, installation, commissioning and training as related to the complete system.	0 to 30
С	References: References will be provided with current contact information for at least 3 other entities where projects were completed within the last 6 years.	0 to 10
D	Ability to deliver finished materials on or before September 1, 2024.	0 to 20
	Maximum Points	100

END OF SECTION

SECTION IP

INSTRUCTIONS TO PROPOSERS

I. PROPOSAL SUBMISSION

A. All proposals should be delivered to:

Barry Wolfgang Contract and Procurement Manager City of Dover Purchasing Office 710 William Street Dover, Delaware 19904

- B. Questions regarding scope of services or proposal process:
 - 1. To ensure fair consideration for all proposers, communication to or with any department or departmental staff during the submission process, will be prohibited except as provided in the third paragraph below. Any communication between the proposer and the City will be initiated by the appropriate staff member in order to obtain information or clarification needed to develop a proper, accurate evaluation of the proposal. Such communications initiated by a proposer may be grounds for disqualifying the offending proposer from consideration for award of the proposal and/or any future proposal.
 - 2. Any questions relative to interpretation of the scope of services or the proposal process, shall be addressed as indicated below, in ample time before the period set for the receipt and opening of proposals.
 - 3. Questions or comments should be directed in writing to:

Barry Wolfgang Contract and Procurement Manager City of Dover Central Services Department 710 William Street Dover, Delaware 19904 E-mail address: doverwhse@dover.de.us

- C. In order to be acceptable, three (3) paper copies and one (1) electronic copy of the proposal must be submitted in a sealed envelope on the outside of which shall be plainly marked "Sealed Proposal: GARRISON OAK STEEL, RFP Opening April 24 1, 2024, 2:00 P.M. Proposal No.: 24-0037EL", together with the name, address, and license number, if applicable, of the company submitting the proposal. Proposals will be received until 2:00 P.M. or hand delivered no later than 2:00 P.M. on May 22, 2023, at which time they will be publicly opened in the City of Dover Central Services Department, 710 William Street, Dover, Delaware 19904.
- D. Proposers are fully responsible for the timely delivery of proposals. Late proposals will not be accepted and will be returned to the proposer unopened. Telegraph, telephone, facsimile machine, and electronic mail proposals will not be accepted under any circumstances.
- E. In the event that personal interviews are deemed necessary, and your business is included among those selected for interview, you will be contacted in order to schedule a mutually

agreeable date and time for the interview.

F. It is anticipated that a final decision on the business to be selected will be made within thirty (30) days or upon approval by City Council, whichever occurs earlier. All proposers will subsequently be contacted and advised of the Department's decision.

II. TERMS AND CONDITIONS

- A. The City reserves the right to reject any or all proposals, with or without cause, to waive technicalities, or to accept the proposal, which in its judgment best serves the interests of the City. The City further reserves the right to award the contract to the next most qualified proposer if the successful proposer does not execute a contract within thirty (30) days after being notified of the award of the proposal.
- B. The City reserves the right to request clarification of information submitted and to request additional information from one or more proposers. All costs associated with the presentation of the proposal and any supplemental information shall be borne solely by the proposer and shall not be passed on to the City under any circumstances.
- C. Any proposal may be withdrawn until the date and time stated above for the opening of the proposals. Any proposals not so withdrawn shall constitute an irrevocable offer to sell to the City the services indicated for a period of ninety (90) days, or until one or more of the proposals have been accepted by the Department, whichever occurs earlier.
- D. Any written agreement or contract resulting from the acceptance of a proposal shall be prepared on forms either supplied by or approved by the City, and shall contain, at a minimum, applicable provisions of this request for proposals. The City reserves the right to reject any agreement that does not conform to the request for proposals or any other City requirements for agreements and contracts. The following are representative of the provisions to be included within the contract documents:
 - Termination If through any cause, the firm selected shall fail to fulfill the obligations agreed to in a timely and efficient manner, the City shall have the right to terminate the contract by specifying the date of termination in a written notice to the firm at least thirty (30) days before the termination date. In this event, the firm shall be entitled to just and equitable compensation for the work satisfactorily completed.
 - 2. Assignment The proposer shall not assign any interest in the contract and shall not transfer any interest in the same without the prior written consent of the City.
 - 3. Non-discrimination The successful proposer must specify in the contract that the firm will not discriminate under the contract, against any person as provided in any federal, state, or local government laws and regulations.
 - 4. Certificate of Insurance The Contractor selected must present proof of insurance coverage of a nature and amount deemed adequate by the City and be willing to execute a hold harmless indemnification for the City.

- 5. Publication of Information No reports, information, or data given to or prepared by the firm under the contract shall be made available to any individual or organization by the firm without the prior written approval of the City. This provision shall only apply insofar as it does not conflict with the provisions of the Freedom of Information Act.
- E. The successful proposer shall be required to enter into a contract with the City of Dover which shall reflect the services requested in the Invitation for Proposals, without delay upon notice of award of contract.

III. INSURANCE REQUIREMENTS

- A. <u>Policies Required</u>. At all times during the term of this Project No. 24-0037EL, the Contractor shall keep in force and affect all insurance policies as described below:
 - <u>Worker's Compensation and Employers' Liability Insurance</u>. Statutory worker's compensation benefits and employers' liability insurance with a limit of liability no less than that required by Delaware law at the time of the application of this provision for each accident. This policy shall be endorsed to include a waiver of subrogation in favor of the City of Dover. The Contractor shall require subcontractors and others not protected under its insurance to obtain and maintain such insurance.
 - <u>Commercial General Liability Insurance.</u> Policy will be written to provide coverage for, but not limited to, the following: premises and operations, products and completed operations, personal injury, blanket contractual coverage, broad form property damage, independent contractor's coverage with Limits of liability not less than \$1,000,000 general aggregate, \$1,000,000 products/completed operations aggregate, \$1,000,000 personal injury, \$2,000,000 each occurrence.
 - 3. <u>Automobile Liability Insurance</u>. Business automobile policy covering all owned, hired and non-owned private passenger autos and commercial vehicles. Limits of liability not less than \$1,000,000 each occurrence, \$1,000,000 aggregate.
 - 4. <u>Qualification; Priority; Contractors' Coverage</u>. The insurer must be authorized to do business under the laws of the State of Delaware. Such insurance will be primary. All contractors and all of their subcontractors who perform work on behalf of Contractor shall be responsible for carrying, in full force and effect, worker's compensation and employer's liability, and automobile liability insurance coverage.
 - 5. <u>Certificate of Insurance; Other Requirements</u>. At the execution of this Agreement and prior to each insurance policy expiration date during the term of this Agreement, Contractor will furnish the City of Dover with a Certificate of Insurance with the CITY named as an additional insured. The Certificate shall reference this Agreement and worker's compensation and property insurance waivers of subrogation required by this Agreement. City of Dover shall be given thirty (30) calendar days advance notice of cancellation or nonrenewal of insurance during the term of this Agreement.
 - 6. <u>Limits</u>. The limits of liability set out in this Agreement may be increased by mutual consent of the parties, which consent will not be unreasonably withheld by either

party, in the event of any factors or occurrences, including substantial increases in the level of jury verdicts or judgments or the passage of state, federal or other governmental compensation plans, or laws which would materially increase the City of Dover's exposure to risk.

7. <u>Deductible/Self-insurance Retention Amounts</u>. Contractor shall be fully responsible for any deductible or self-insured retention amounts contained in its insurance program or for any deficiencies in the amounts of insurance maintained.

IV. BID PROCESS SCHEDULE

A. The City will use the following tentative timetable in the selection process:

Date	Event
Wednesday, April 24, and May 1, 2024	Publicly Advertise RFP #24-0037EL
Wednesday, May 8, 2024	Deadline for submitting questions
Tuesday, May 15, 2024	Addendum issued/answers to proposer's questions published
Friday, May 22, 2024	Proposal Deadline to submit final proposals (Proposal Opening). (3 original copies and 1 electronic copy by 2:00 pm)
Wednesday, May 29, 2024	City Completes Evaluation of Proposals
Monday, June 24, 2024	City Issues Notice of Award
Tuesday, June 25, 2024	Contract Execution

END OF SECTION

GARRISON OAK STEEL CITY OF DOVER, DELAWARE

PROPOSAL FORM

Date:_____

Proposal of ______(hereinafter called "PROPOSER"), organized and existing under the laws of the State of Delaware doing business as ______*. To the City of Dover (hereinafter called "OWNER").

In compliance with the Invitation to Proposers, PROPOSER hereby proposes to perform all WORK for the **GARRISON OAK STEEL** for the City of Dover, RFP No. **24-0037EL**, in strict accordance with the SCOPE OF WORK and DNREC's Source Category Permit (if applicable), within the time set forth therein, and at the prices stated below. The PROPOSER has examined and fully understands the scope of work.

The PROPOSER declares that the attached documents therein referred to have been carefully examined and are understood. It is proposed and agreed if the Proposal is accepted to contract with the City of Dover the required work in the manner set forth in the documents.

*Corporation, Partnership, or Individual as applicable.

PROPOSER acknowledges receipt of the following ADDENDUM (if applicable):

The PROPOSER declares that the only person, firm or corporation, or persons, firms or corporations, that has or have any interest in this proposal or in the Contract or Contracts proposed to be taken is or are the undersigned; that this proposal is made without any connection or collusion with any person, firm or corporation, making a proposal for the same work.

The proposer agrees that this proposal shall be good and may not be withdrawn for a period of ninety (<u>90</u>) calendar days after the scheduled closing time for receiving proposals.

Upon receipt of written notice of the acceptance of this proposal, proposer will execute the formal contract attached within ten (10) days and deliver.

The names and addresses of all members of a firm or the names, addresses, and titles of every officer of a corporation as the case may be, must be given here by the member if the firm or by the officer or agent of the corporation who signs the Proposal.

Respectfully submitted:

Signature

Company Name

Title

Date

Address

License Number (if applicable)

SEAL – (If BID is by a corporation)

Taxpayer ID Number

Telephone No.

If a Partnership, state names and addresses of Partners here:

GARRISON OAK STEEL RFP NO.:24-0037EL CITY OF DOVER, DELAWARE

PROPOSAL FORM

PROPOSAL ITEM	UNIT	СОЅТ
Services to be provided to complete the Scope of Work described in IFP Section IV.A-F , including permit costs	LS	
GRAND	TOTAL:	

CHECK THE APPROPRIATE BOXES:

REQUIRED CONTENT TO BE SUBMITTED WITH PROPOSAL	Yes	No
Firm Identification, as outlined per IFP, Section V.A		
Statement of Understanding, as outlined per IFP, Section V.B		
Proposer has attached proper information to satisfy the Selection Criteria, as outlined per IFP, Section VII.A		
Insurance Requirements, as outlined per IP, Section III.A		

The proposer agrees that this proposal shall be good and may not be withdrawn for a period of ninety (<u>90</u>) calendar days after the scheduled closing time for receiving proposals.

Respectfully submitted:

Signature

Firm Name

Title

Address

Date

License Number (if applicable) SEAL – (If BID is by a corporation)

Note:

Contractor shall supply documentation to answer all requirements in the statement of Qualification section, located in Section IFP.

Local Vendor Preference

Circle One: Rule 1 Rule 2 Rule 3 None

No

Minority Vendor Preference

Circle One: Yes

END OF SECTION

AGREEMENT FOR PROFESSIONAL SERVICES

THIS AGREEMENT is made as of the _____ day of _____ in the year 2024, between The City of Dover, a Delaware Municipal Corporation, whose address is 15 Loockerman Plaza, Dover, Delaware 19901 (hereinafter referred to as the CITY), and ______, whose address is, (hereinafter referred to as the CONTRACTOR).

NOW, THEREFORE, in consideration of the mutual benefits accruing to the parties to this Agreement, and for other good and valuable considerations, the parties agree as follows:

1. <u>SERVICES</u>

The CONTRACTOR shall perform the following services as identified in the: **REQUEST FOR PROPOSAL FOR GARRISON OAK STEEL, RFP NO.: 24-0037EL AND THE SUBMITTED PROPOSAL FORM AND DETAILED PAYMENT SCHEDULE.** Nothing herein shall limit the CITY's right to obtain proposals or services from other professionals for similar projects at any time the CITY so chooses.

2. INDEMNIFICATION

The CONTRACTOR, and any agent or subcontractor, shall defend, indemnify and hold harmless the CITY and its officials, officers, board members, council members, commissioners, representatives, employees, agents, and contractors, against any and all liability, costs, damages, fines, taxes, special charges by others, penalties, payments (including payments made under any Workers' Compensation Laws or under any plan for employees' disability and death benefits), and expenses (including reasonable attorney fees of the CITY and all other costs and expenses of litigation). Claims arising in any way, including any act, omission, failure, negligence or willful misconduct, in connection with the work, construction, maintenance, repair, presence, use, or operation by the CONTRACTOR, or the CONTRACTOR's officers, directors, employees, agents, and sub-contractors, shall be responsible for Claims. Such Claims include, but are not limited to, the following:

- a. Intellectual property infringement, libel and slander, trespass, unauthorized use of television or radio broadcast programs and other program material, and infringement of patents;
- b. Cost of work performed by the CITY that was necessitated by the CONTRACTOR's failure, or the failure of the CONTRACTOR's officers, directors, employees, agents, or subcontractors, to perform work, or maintain CITY facilities in accordance with the requirements and specifications of this Agreement, or from any other work authorized under this Agreement;
- c. Damage to property, injury to or death of any person arising out of the performance or nonperformance of any work or obligation undertaken by the CONTRACTOR, or CONTRACTOR's officers, directors, employees, agents, and sub-contractors, pursuant to this Agreement;

3. PROCEDURE FOR INDEMNIFICATION

- a. The CITY shall give notice promptly to the CONTRACTOR of any claim or threatened claim, specifying the factual basis for such claim and the amount of the claim. If the claim relates to an action, suit or proceeding filed by a third party against the CITY, the notice shall be given to the CONTRACTOR by the CITY no later than ten (10) calendar days after written notice of the action, suit or proceeding was received by the CITY.
- b. Failure to timely give the required notice will not relieve the CONTRACTOR from its obligation to indemnify the CITY unless the CITY is materially prejudiced by such failure.
- c. The CITY will have the right at any time, by notice to the CONTRACTOR, to participate in or assume control of the defense of the claim with counsel of its choice, which counsel must be reasonably acceptable to the CONTRACTOR. The CONTRACTOR agrees to cooperate fully with the CITY. If the CITY so assumes control of the defense of any third-party claim, the CONTRACTOR shall have the right to participate in the defense at its own expense. If the CONTRACTOR does not so assume control or otherwise participate in the defense of any third-party claim, it shall be bound by the results obtained by the CITY with respect to the claim.
- d. If the CITY assumes the defense of a third-party claim as described above, then in no event will the CITY admit any liability with respect to, or settle, compromise or discharge, any third-party claim without the CONTRACTOR's prior written consent, and the CONTRACTOR will agree to any settlement, compromise or discharge of any third-party claim which the CITY may recommend which releases the CITY completely from such claim.
- e. <u>Municipal Liability Limits.</u> No provision of this Agreement is intended, or shall be construed, to be a waiver for any purpose by either entity of any applicable State limits on municipal liability.
- f. <u>Disclaimer.</u> The CITY makes no express or implied warranties with regard to its structures, fixtures, materials, or other equipment, all of which are hereby disclaimed. The CITY makes no other express or implied warranties, except to the extent expressly set forth in this Agreement. The CITY expressly disclaims any implied warranties of merchantability or fitness for a particular purpose
- g. <u>Duty to Competent Supervision and Performance</u>. The CONTRACTOR shall ensure that its employees, servants, agents, and subcontractors have the necessary qualifications, skill, knowledge, training, and experience to protect themselves, their fellow employees, employees of the CITY, and the general public, from harm or injury while performing work permitted pursuant to this Agreement. In addition, the CONTRACTOR shall furnish its employees, servants, agents, and subcontractors with competent supervision and sufficient and adequate tools and equipment for their work to be performed in a safe manner.
- h. <u>Duty to Inform</u>. The CONTRACTOR further warrants that it understands the imminent dangers (INCLUDING SERIOUS BODILY INJURY OR DEATH FROM FALLING) inherent in the work necessary to perform the work expected under this agreement by the CONTRACTOR's employees, servants, agents, contractors or subcontractors, and accepts as its duty and sole responsibility to notify and inform the CONTRACTOR's employees, servants, agents, of such dangers, and to keep them informed regarding same.

4. INSURANCE

- a. <u>Policies Required</u>. At all times during the term of this Agreement, the CONTRACTOR shall keep in force and affect all insurance policies as described below:
- b. <u>Worker's Compensation and Employers' Liability Insurance</u>. Statutory worker's compensation benefits and employers' liability insurance with a limit of liability no less than that required by Delaware law at the time of the application of this provision for each accident. This policy shall be endorsed to include a waiver of subrogation in favor of the City of Dover. The CONTRACTOR shall require subcontractors and others not protected under its insurance to obtain and maintain such insurance.
- c. <u>Commercial General Liability Insurance.</u> Policy will be written to provide coverage for, but not limited to, the following: premises and operations, products and completed operations, personal injury, blanket contractual coverage, broad form property damage, independent contractor's coverage with limits of liability not less than \$1,000,000 general aggregate, \$1,000,000 products/completed operations aggregate, \$1,000,000 personal injury, \$2,000,000 each occurrence.
- d. <u>Automobile Liability Insurance</u>. Business automobile policy covering all owned, hired and non-owned private passenger autos and commercial vehicles. Limits of liability not less than \$1,000,000 each occurrence, \$1,000,000 aggregate.
- e. <u>Qualification; Priority; Contractors' Coverage</u>. The insurer must be authorized to do business under the laws of the State of Delaware. Such insurance will be primary. All contractors and all of their subcontractors who perform work on behalf of the CONTRACTOR shall be responsible for carrying, in full force and effect, worker's compensation and employer's liability, and automobile liability insurance coverage.
- f. <u>Certificate of Insurance; Other Requirements</u>. At the execution of this Agreement and prior to each insurance policy expiration date during the term of this Agreement, the CONTRACTOR will furnish the CITY with a Certificate of Insurance with the CITY named as an additional insured. The Certificate shall reference this Agreement and worker's compensation and property insurance waivers of subrogation required by this Agreement. The CITY shall be given thirty (30) calendar days advance notice of cancellation or nonrenewal of insurance during the term of this Agreement.
- g. <u>Limits</u>. The limits of liability set out in this Agreement may be increased by mutual consent of the parties, which consent will not be unreasonably withheld by either party, in the event of any factors or occurrences, including substantial increases in the level of jury verdicts or judgments or the passage of state, federal or other governmental compensation plans, or laws which would materially increase the CITY's exposure to risk.
- h. <u>Deductible/Self-insurance Retention Amounts</u>. The CONTRACTOR shall be fully responsible for any deductible or self-insured retention amounts contained in its insurance program or for any deficiencies in the amounts of insurance maintained.

5. <u>CODES, LAWS, AND REGULATIONS</u>

The CONTRACTOR will comply with all applicable codes, laws, regulations, standards, and ordinances in force during the term of this Agreement.

6. <u>PERMITS, LICENSES, AND FEES</u>

The CONTRACTOR will obtain and pay for all permits and licenses required by law that are associated with the CONTRACTOR's performance of the Scope of Services.

7. ACCESS TO RECORDS

The CONTRACTOR will maintain accounting records, in accordance with generally accepted accounting principles and practices, to substantiate all invoiced amounts. Said records will be available for examination by the CITY during the CONTRACTOR's normal business hours. Said records will be maintained for a period of three (3) years after the date of the invoice.

8. <u>CONTINGENT FEES PROHIBITED</u>

The CONTRACTOR warrants that he or she has not employed or retained any company or person, other than a bona fide employee working solely for the CONTRACTOR, to solicit or secure this Agreement and that he or she has not paid or agreed to pay any person, company, corporation, individual, or firm, other than a bona fide employee working solely for the CONTRACTOR any fee, commission, percentage, gift, or other consideration contingent upon or resulting from the award or making of this Agreement. In the event of a breach of this provision, the CITY shall have the right to terminate this Agreement without further liability and at its discretion, deduct from the contract price, or otherwise recover, the full amount of any such fee, commission, percentage, gift or consideration paid in breach of this Agreement.

9. <u>PAYMENT</u>

CITY shall compensate the CONTRACTOR for their services as set forth in Attachment A, Basis for Payment. All requests for payment shall be accompanied by supporting documentation which will include proof of the specific work being completed on the facility in accordance to the schedule and other CITY required supporting documentation. Any reimbursement for expenses shall include receipts or copies of the invoices. No other costs or services shall be billed to the CITY.

10. INDEPENDENT CONTRACTOR

The CONTRACTOR is an independent contractor and as such will be responsible for paying his own Federal income tax and self-employment tax, or any other taxes applicable to the compensation paid under this agreement.

11. ASSIGNMENT

Neither party shall have the power to assign any of the duties or rights or any claim arising out of or related to the Agreement, whether arising in tort, contract, or otherwise, without the written consent of the other party. These conditions and the entire Agreement are binding on the heirs, successors, and assigns of the parties hereto.

12. <u>NO THIRD PARTY BENEFICIARIES</u>

This Agreement gives no rights or benefits to anyone other than the CONTRACTOR and the CITY.

13. JURISDICTION

The laws of the State of Delaware shall govern the validity of this Agreement, its interpretation and performance, and any other claims related to it. In the event of any litigation arising under or construing this Agreement, venue shall lie only in Kent County, Delaware.

14. TERM AND TERMINATION

All or part of this Agreement may be terminated by the CITY for its convenience on fifteen (15) days written notice to the CONTRACTOR. In such event, the CONTRACTOR will be entitled to compensation for services competently performed up to the date of termination. In the event of termination not the fault of the CONTRACTOR, the CONTRACTOR shall be compensated for with Reimbursable Expenses then due and all Termination Expenses.

15. <u>CONTACT PERSON</u>

The primary contact person under this Agreement for the CONTRACTOR shall be Name: ______, Phone No.:______, Address:______. The primary contact person under this Agreement for the CITY shall be Shawn Burgett, Engineering Services and System Operations Superintendent, 302-674-7568, Electric Department.

16. <u>APPROVAL OF SERVICE PERSONNEL</u>

The CITY reserves the right to approve the contact person and the persons actually performing the services on behalf of the CONTRACTOR pursuant to this Agreement. If the CITY, in its sole discretion, is dissatisfied with the contact person or the person or persons actually performing the services on behalf of the CONTRACTOR pursuant to this Agreement, the CITY may require the CONTRACTOR assign a different person or persons be designated to be the contact person or to perform the services hereunder.

IN WITNESS WHEREOF, the parties hereto have executed this Agreement on the respective dates under each signature.

(CONTRACTOR)	CITY OF DOVER
Ву:	By: <u>Dave Hugg</u>
Title:	Title: <u>City Manager</u>
Signature:	Signature:
Date:	Date:

ATTACHMENT A

BASIS FOR PAYMENT

NOTICE OF AWARD

то: _____

PROJECT Description: Construction Improvements for the GARRISON OAK STEEL, RFP No.: 24-0037EL.

The OWNER has considered the BID submitted by you for the above described WORK in response to its Invitation for Proposals and Instructions for Proposers.

You	are	hereby	notified	that	your	base	BID	has	been	accepted	for	the	amount	of:
											(\$).

You are required by the Information for Bidders to execute the Agreement and certificates of insurance within ten (10) calendar days from the date of this Notice to you.

If you fail to execute said Agreement and to furnish said certificates of insurance within ten (10) days from the date of this Notice, said OWNER will be entitled to consider all your rights arising out of the OWNER'S acceptance of your BID as abandoned. The OWNER will be entitled to such other rights as may be granted by law.

You are required to return an acknowledged copy of this NOTICE OF AWARD to the OWNER.

Dated this _____ day of _____ 202__.

The City of Dover, Owner

ignature:
ignature:

Printed	:		

Title:_____

ACCEPTANCE OF NOTICE

Receipt of the above	NOTICE OF	AWARD is	hereby	acknowledged
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END OF SECTION

NOTICE TO PROCEED

то:	Date:
	Project: GARRISON OAK STEEL, RFP 24-0037EL
You are hereby notified to commence WORK in acc	ordance with the Agreement dated

______, 2024 on or before ______, 2024 and you are to complete the WORK within 120 days thereafter. Work progress updates are to be provided to COD on a weekly basis. The date of completion of all work is therefore anticipated by 1 Oct 2024.

The City of Dover, Owner

Signature: _____


Printed: _		
Title:		

ACCEPTANCE OF NOTICE

Receipt of the above NOTICE TO PROCEED is hereby acknowledged

by		
this the	day of	, 202_
Ву:	Title:	
Employer Identificat	tion Number:	


END OF SECTION

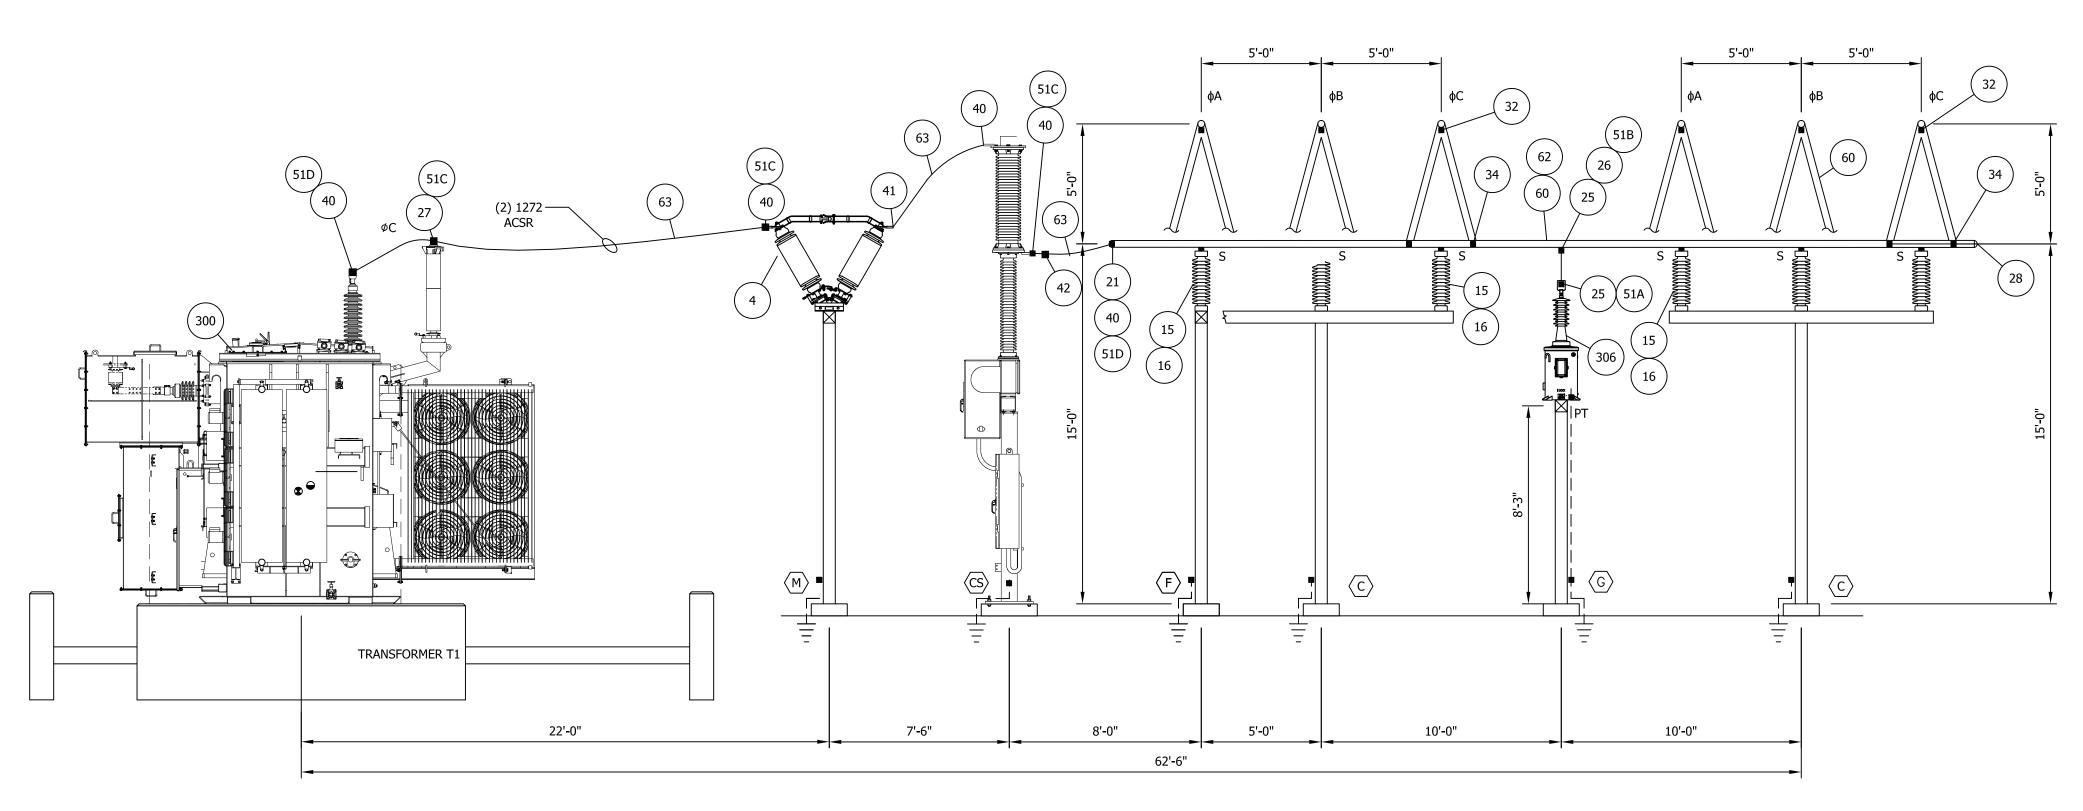

								CUSTOMER		CITY OF DC	VER
								SUBSTATION	69-12	2.47KV SUB	STATION
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		2	9/23/21	JLF	MAR	MAR	ISSUE FOR BID	PROJECT NUMBER 47019 SCALE		CHECKED APPROVED	DRAWING NUMBER
	ASSOCIATED SUBSTATION ENGINEERING, INC.	1	7/28/21	JLF	MAR	MAR	RE-ISSUED FOR APPROVAL	N.T.S	ILVEY ENTER	RPRISES, INC.	SOCIATED
		0	4/8/21	KDC	MAR	PHM	ISSUED FOR APPROVAL			VISION	UBSTATION
ENGINEERING SEAL		REV	DATE	DRN	СК	APP	DESCRIPTION			ure • Construct == epc 770-537-1144	www.aseng.com 770-537-0033


REFERENCE DRAWINGS

A0002	SUBSTATION INSTALLATION GUIDE
A0102	SUBSTATION PLAN PHASE 1
E0100	SUBSTATION SINGLE LINE DIAGRAM
	A0102

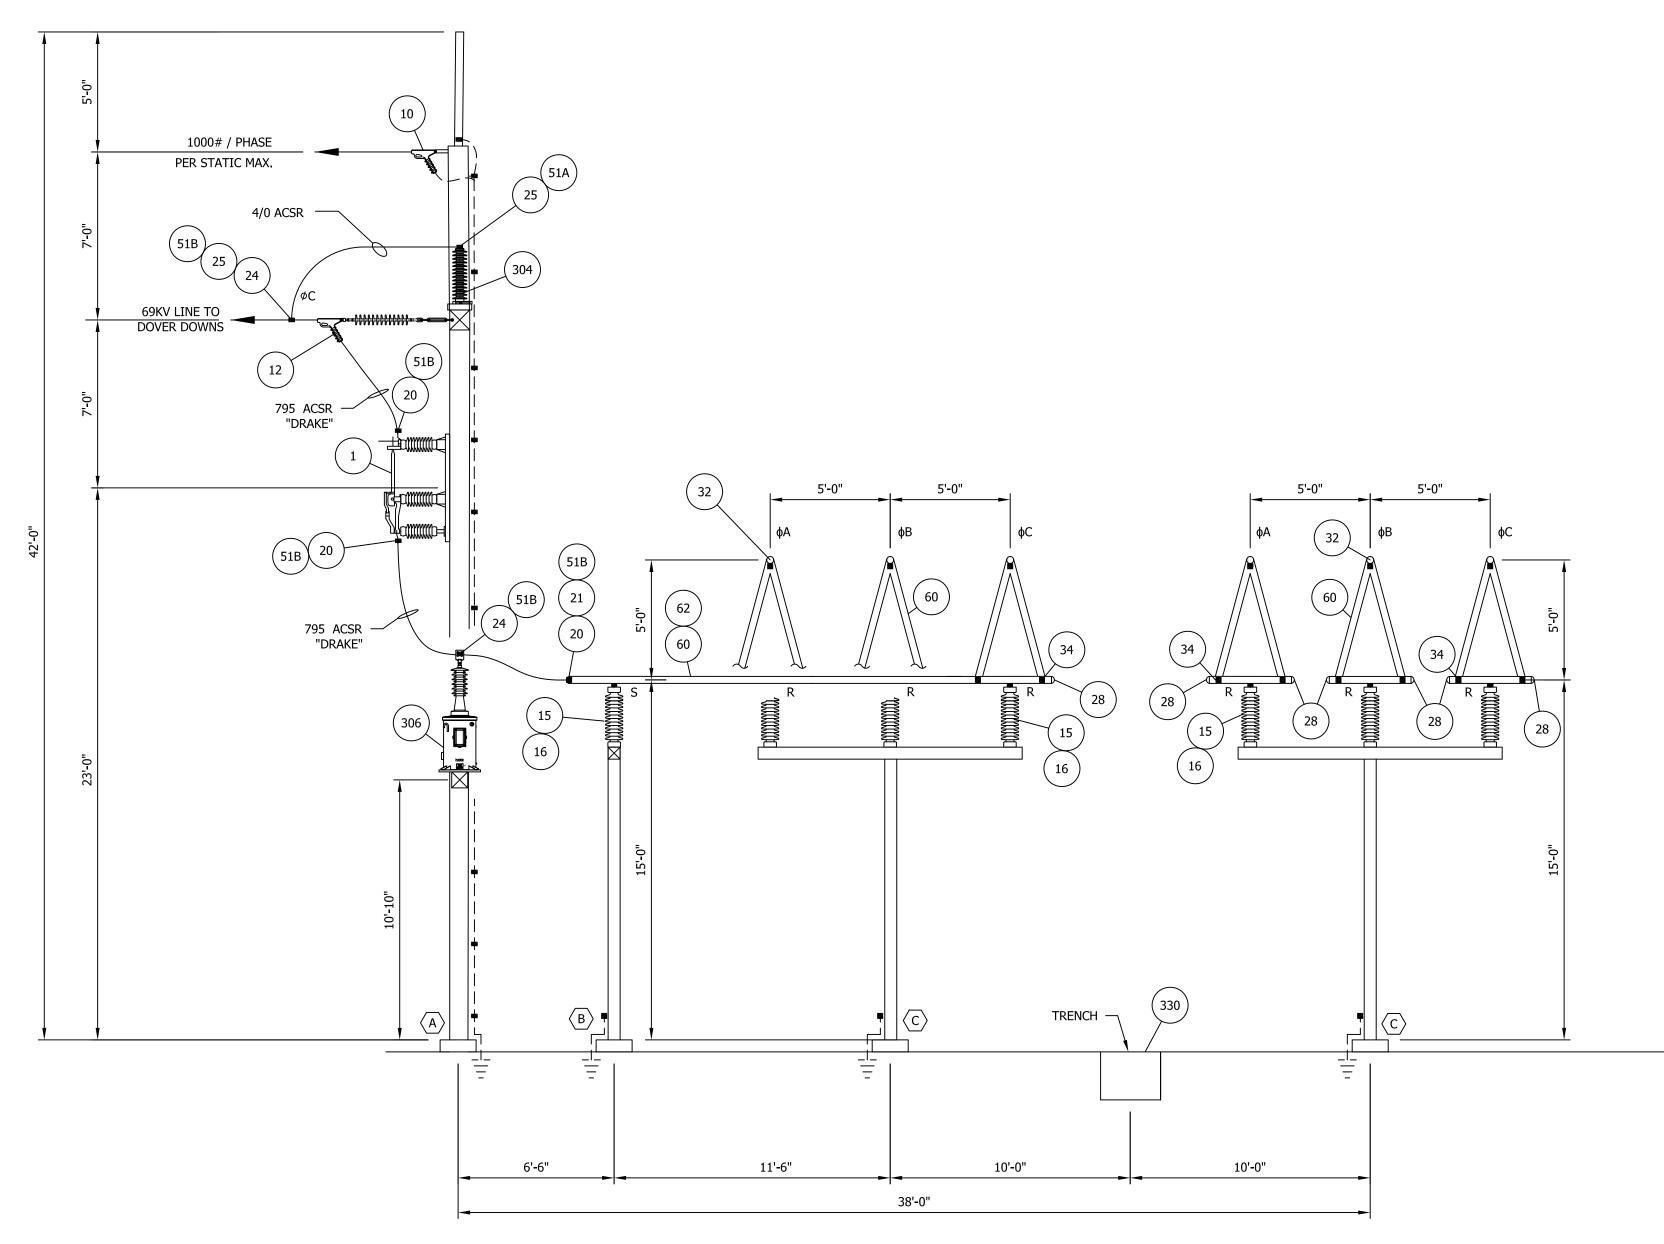

	THE INFORMATION ON THIS DRAWING IS PROPRIETARY		
	AND IS NOT TO BE USED, REPRODUCED OR COPIED WITHOUT THE WRITTEN CONSENT OF	3	09/14/2
	ASSOCIATED SUBSTATION ENGINEERING, INC.	2	9/23/2
	ASSOCIATED SUBSTATION ENGINEERING, INC.	1	7/28/2
		0	4/8/21
ENGINEERING SEAL		REV	DATE

REFERENCE DRAWINGS A0002 SUBSTATION INSTALLATION GUIDE A0102 SUBSTATION PLAN PHASE 1 E0100 SUBSTATION SINGLE LINE DIAGRAM

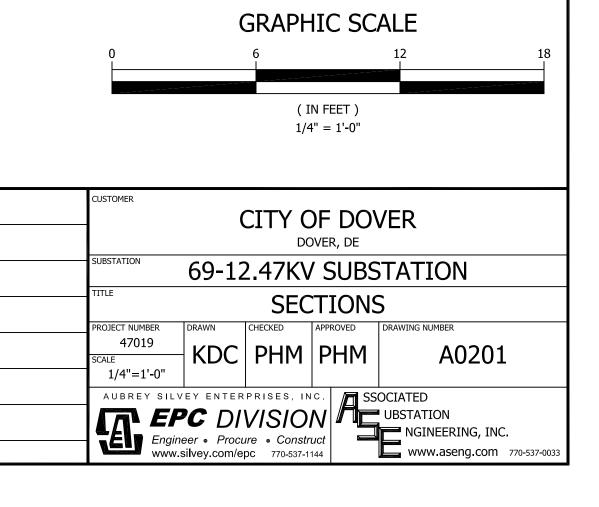

09/14/23 JLF MAR MAR ISSUE FOR CONSTRUCTION

7/28/21 JLF MAR MAR RE-ISSUED FOR APPROVAL


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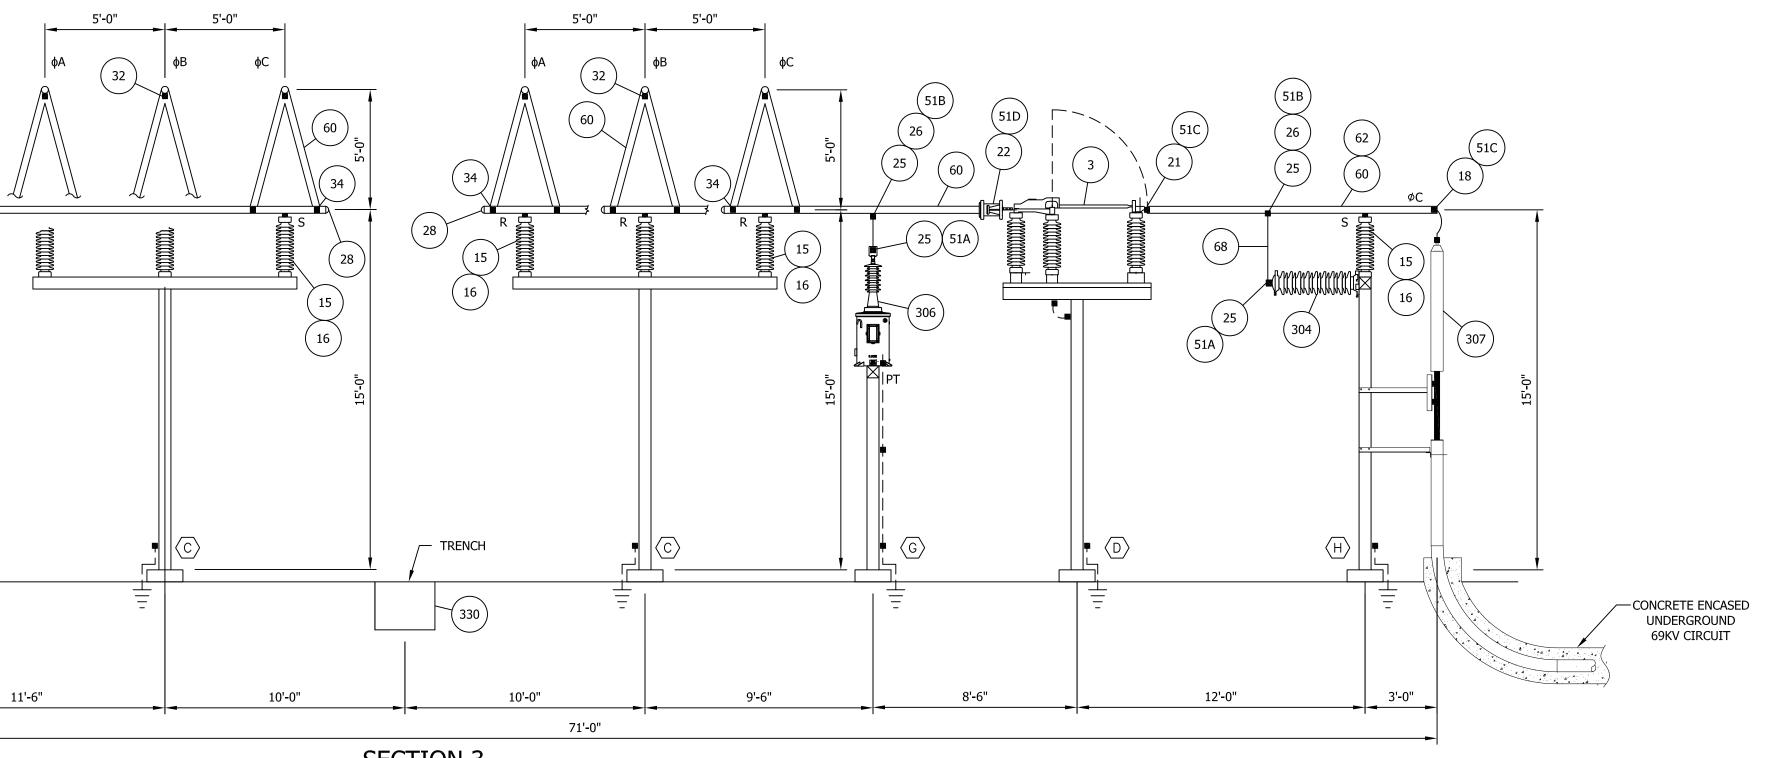
DESCRIPTION

9/23/21 JLF MAR MAR ISSUE FOR BID

DATE DRN CK APP

4/8/21



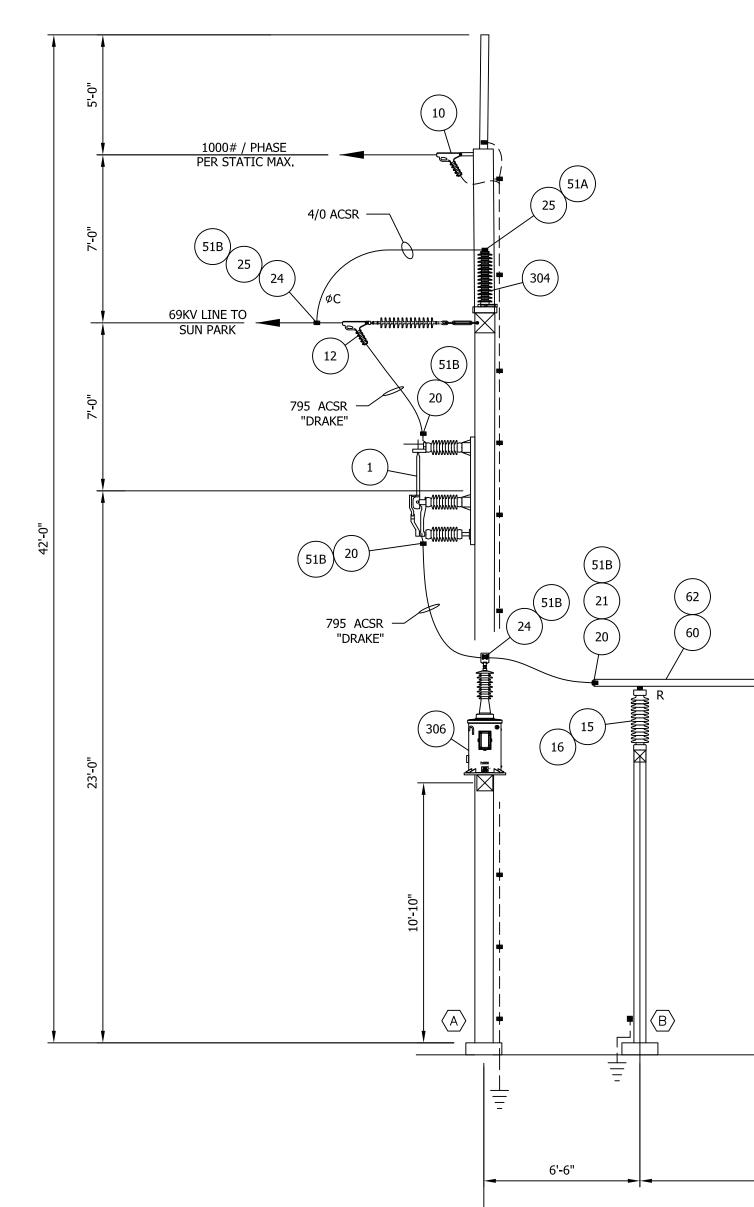

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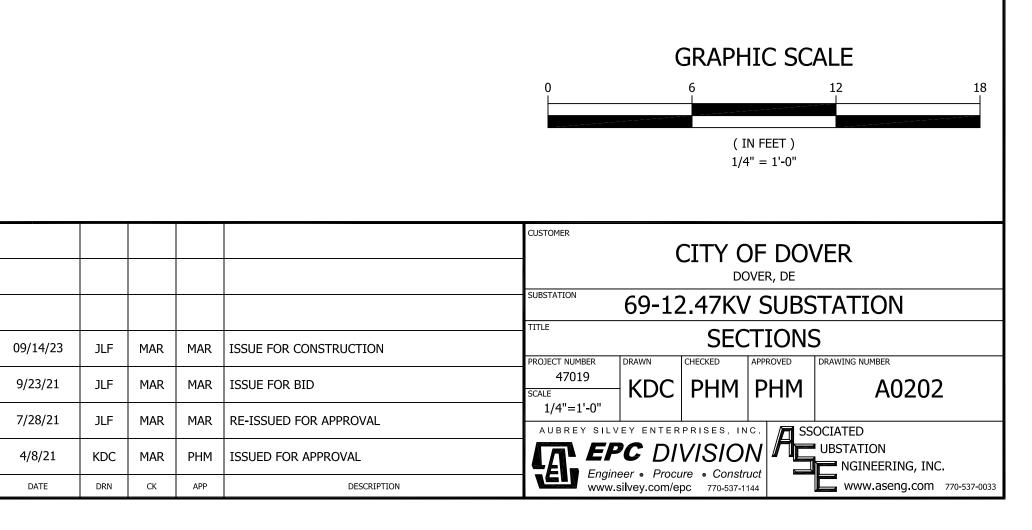
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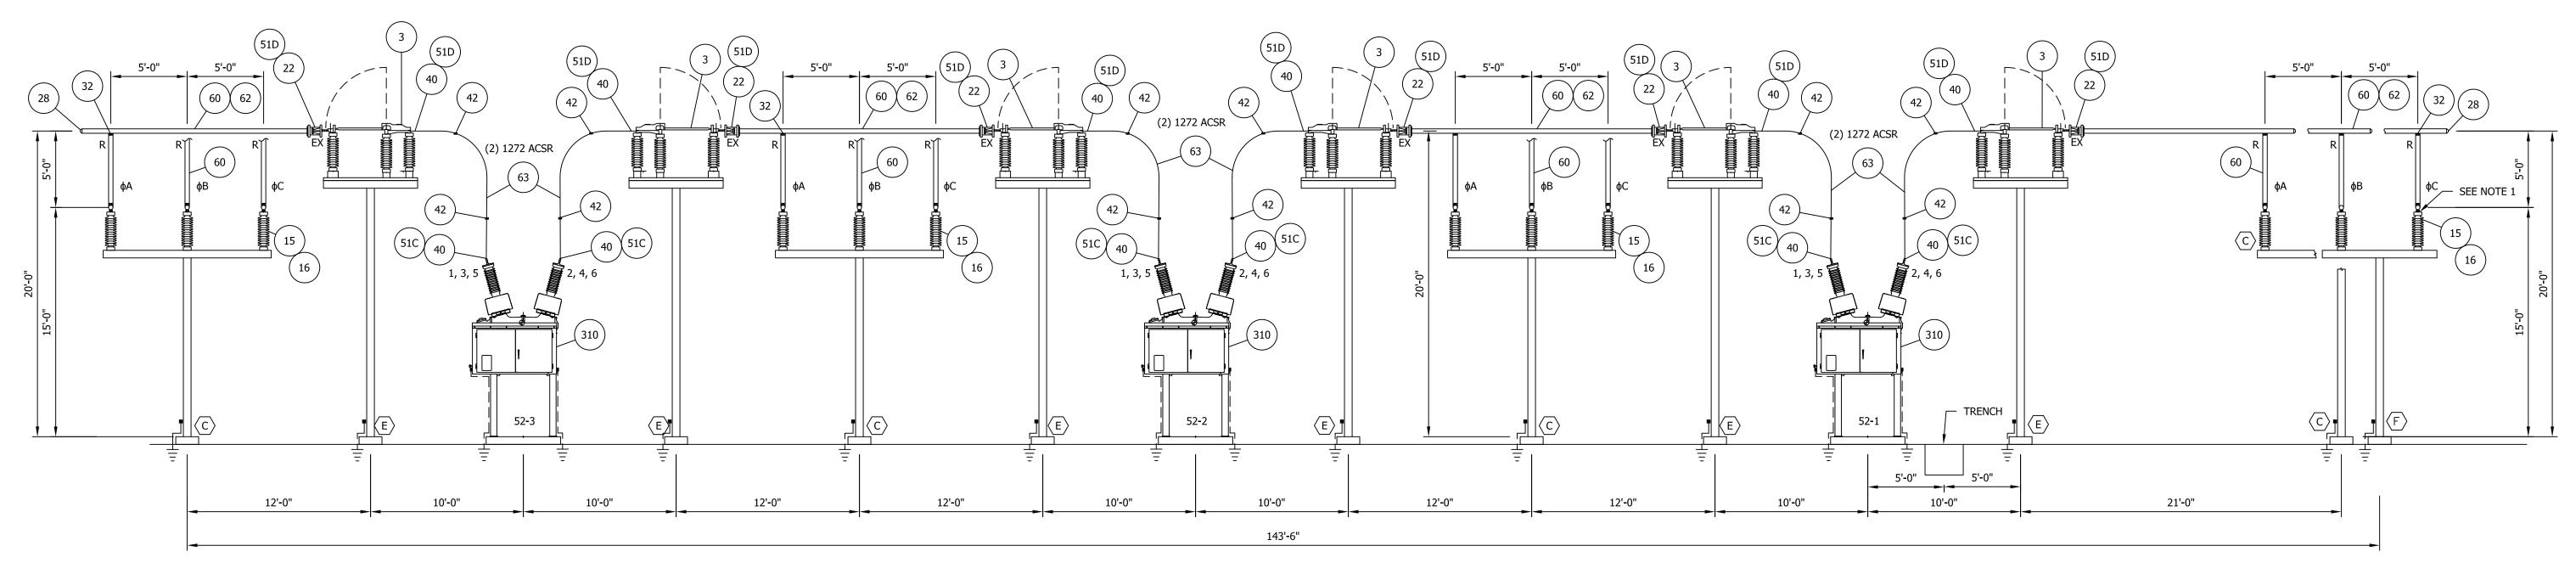
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DATE DRN CK APP


JLF MAR MAR ISSUE FOR BID


REF	FERENCE DRAWINGS
A0002	SUBSTATION INSTALLATION GUIDE
A0102	SUBSTATION PLAN PHASE 1
E0100	SUBSTATION SINGLE LINE DIAGRAM







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	ASSOCIATED SUBSTATION ENGINEEDING INC	2
	ASSOCIATED SUBSTATION ENGINEERING, INC.	1
		0
ENGINEERING SEAL		REV

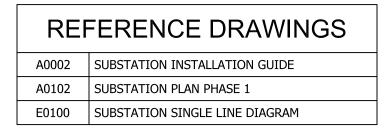

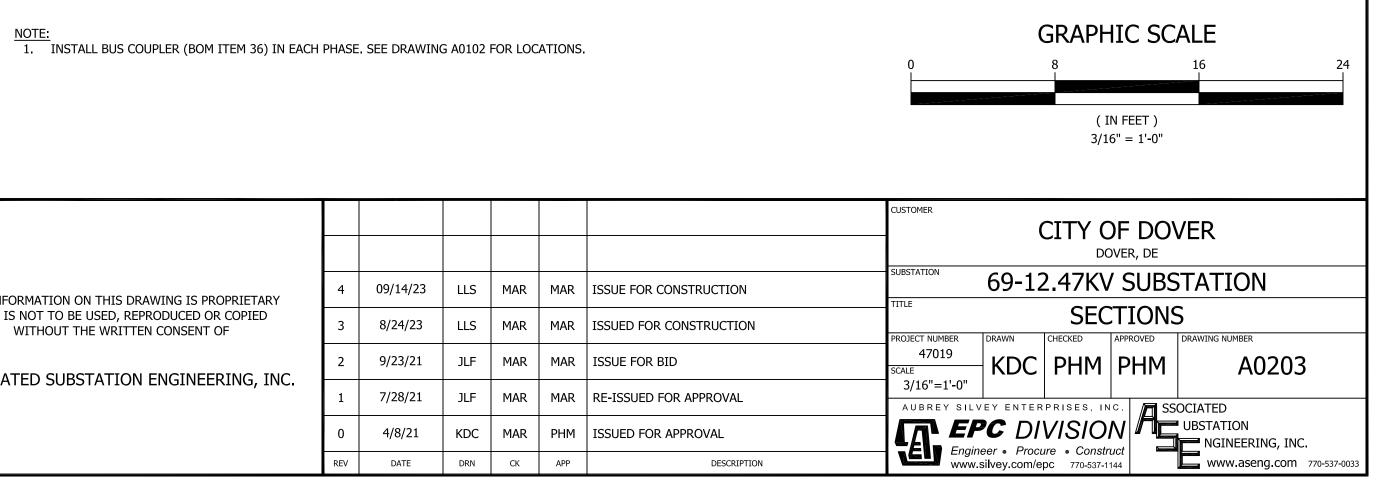


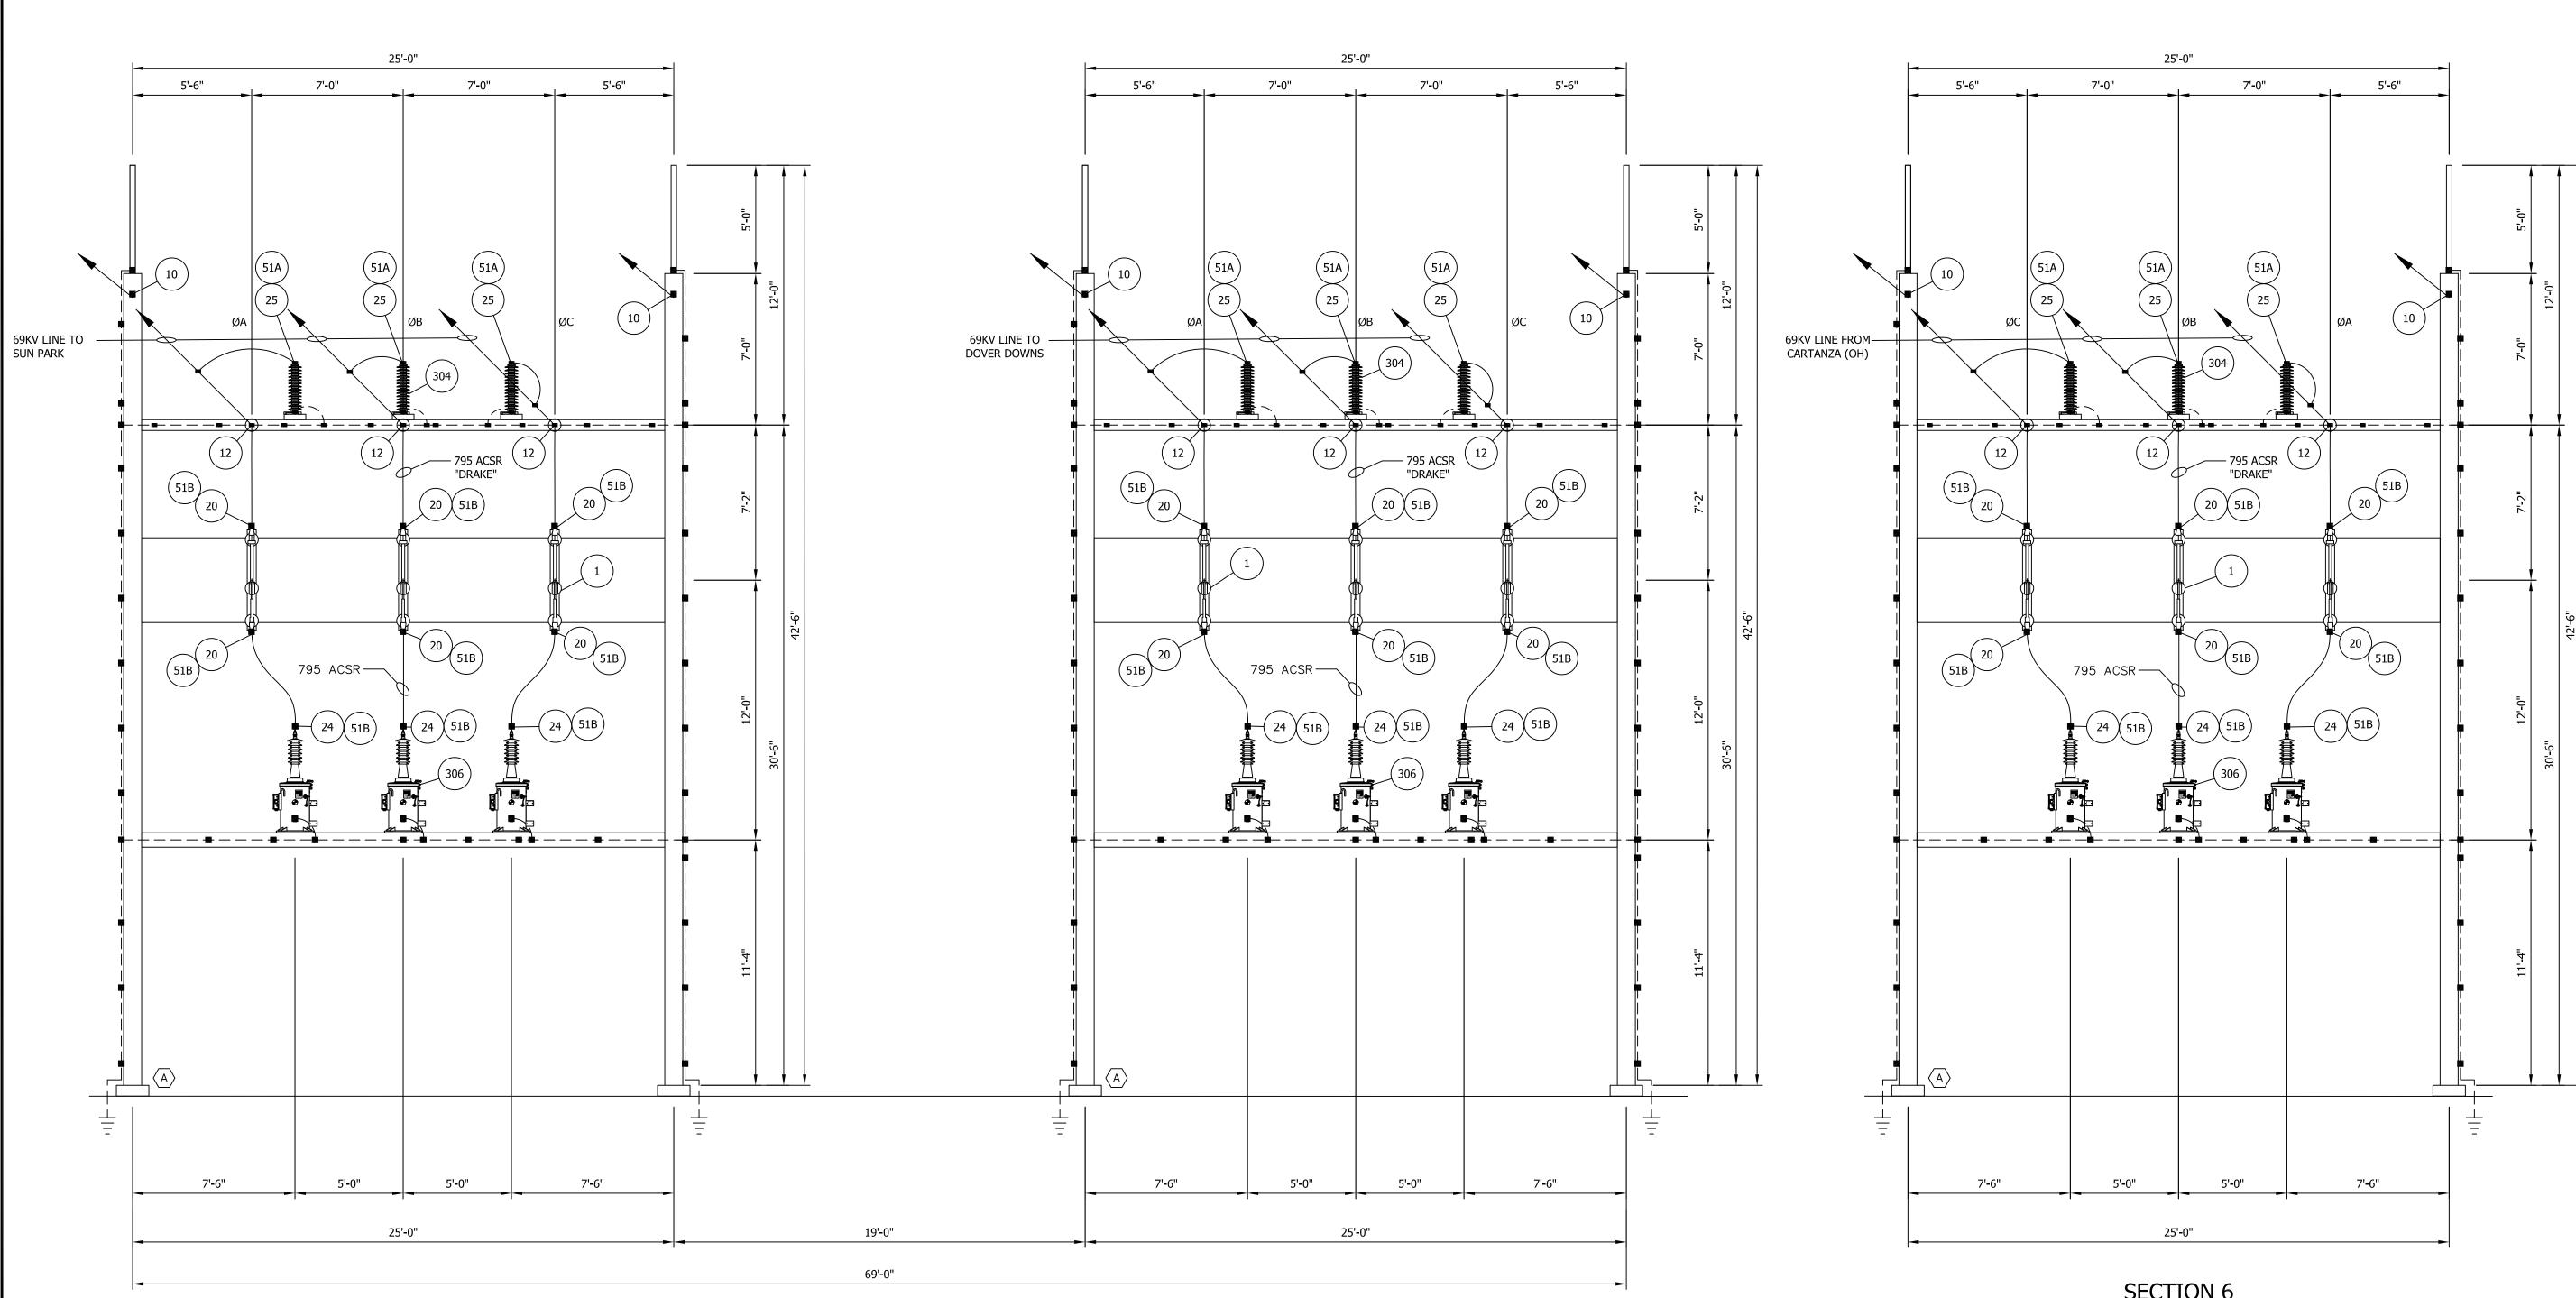




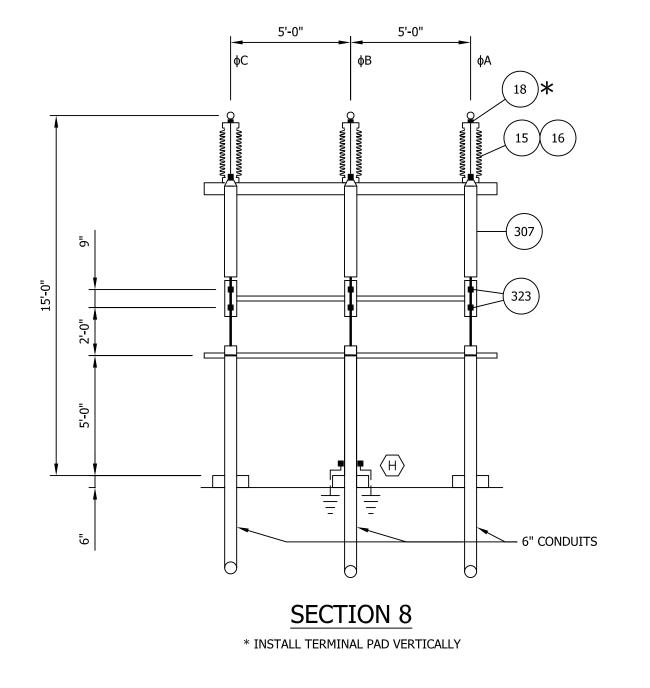

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SECTION 6

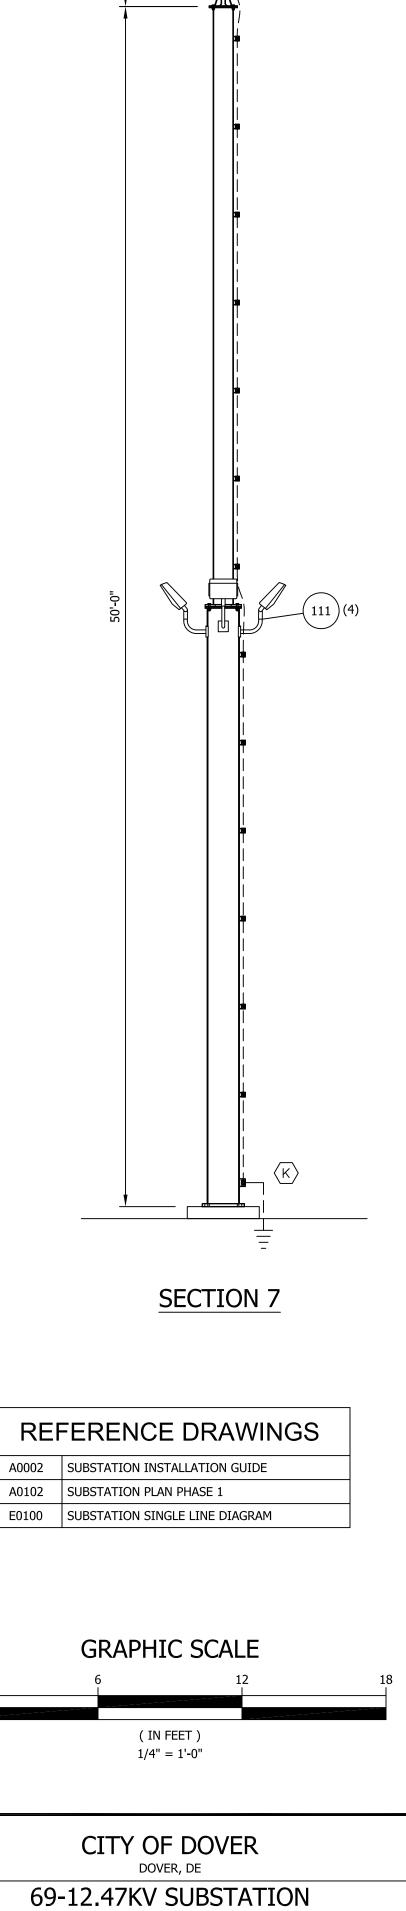

ASE-ITEM #	QTY. SPARE	DESCRIPTION	MFG OR EQUAL MFG PA	ART ASE-ITEN #	QTY.	SPARE	DESCRIPTION	MFG OR EQUAL	MFG PART	ASE-ITEN #	/I QT	Y. SPARE	DESCRIPTION	MFG OR EQUAL	MFG PART
							D) GALVANIZED STEEL BASES								
	——————————————————————————————————————	OT DIPPED GALVANIZED (ASTM-123-ZINC) STEEL					E) MANUAL TYPE "SWING HANDLE" OPERATING MECHANISMS			20	27		TERMINAL, ALUM. COMPRESSION TYPE, 795 MCM ACSR "DRAKE" TO 4 HOLE PAD	SEFCOR	AL-1108-4B
	LOT	TRUCTURES COMPLETE					F) PROVISIONS FOR PADLOCKING IN OPEN OR CLOSED								
	V	/ITH ERECTION BOLTS, PER THE FOLLOWING:					-031101			21	18		TERMINAL, ALUM. WELD TYPE, 3" SPS ALUM. TO 4 HOLE PAD	SEFCOR	WFTC-62-4B
		9KV, "H" FRAME, SINGLE BAY DEAD END STRUCTURE, ULLOFF BEAM FOR 30'-6" CONDUCTOR HEIGHT AND		3	13		69 KV, 350 KV BIL, 3 PST, GROUP OPERATED VERTICAL BREAK SW.	USCO	AVR-07220				EXPANSION TERMINAL, ALUM. WELD TYPE, 3" SPS ALUM.		
^	P	ROVISIONS FOR MOUNTING LIGHTNING ARRESTERS, 9KV GOAB SWITCH, , 7'-0" PHASE SPACING, 2000 KIP MAX	,				ON 5'-0" PHASE SPACING, RATED 2000 AMPS. CONTINUOUS, 100kA			22	39		TO 4 HOLE PAD	SEFCOR	WFXTC-62-4B
~	Т	ENSION, 37'-6" STATIC WIRE HEIGHT, 1000 KIP MAX. ENSION, METERING BEAM FOR MOUNTING METERING					MOMENTARY, HORIZONTALLY MOUNTED COMPLETE WITH:						TEE, ALUM. COMPRESSION TYPE, 795 MCM ACSR		
	U	NITS	CHAPMAN'S				A) ALUMINUM LIVE PARTS			24	18		"DRAKE" TO 4 HOLE 3" PAD	SEFCOR	ATCF-1108-4A
	6	9 KV, BUS SUPPORT STRUCTURE 15'-0" BUS HEIGHT, 5'-0"	n				B) NEMA TR-216 GRAY STATION POST INSULATORS						TERMINAL, ALUM. COMPRESSION TYPE, 4/0 ACSR		
В		HASE SPACING	CHAPMAN'S				C) STANDARD ARCING HORNS			25	30		"PENGUIN" TO 4 HOLE 3" PAD	SEFCOR	AL-563-4A
							D) GALVANIZED STEEL BASES E) MANUAL TYPE "SWING HANDLE" OPERATING								
С		9 KV, 45 DEG BUS SUPPORT STRUCTURE 15'-0" BUS EIGHT, 5'-0" PHASE SPACING	CHAPMAN'S				MECHANISM			26	6		TEE, WELD TYPE 3" SPS ALUM. TO NEMA 4 HOLE 3" PAD	SEFCOR	WTF-6269-4A
							F) PROVISIONS FOR PADLOCKING IN OPEN OR CLOSED								
		9 KV, 3 PHASE SWITCH STAND, 15'-0' BUS HEIGHT, 5'-0" HASE SPACING INCOMING UNDERGROUND LINE					G) 12 AT 20'-0" BUS HEIGHT			27	3		TEE, BOLTED TYPE, DUAL 1272 MCM ASCR TO 4 HOLE 3" PAD	SEFCOR	ASPC-41-6-4A
5		ISCONNECT WITH PROVISIONS FOR SWING HANDLE					H) 1 AT 15'-0" BUS HEIGHT								
D		P-MECH	CHAPMAN'S							28	30		END FITTING, DRIVE ON TYPE FOR 3" AL SPS ALUM.	SEFCOR	DP-62-AL
				4	1		69 KV, 350 KV BIL, 3 PST, GROUP OPERATED VEE SWITCH	USCO	AGCH5V-07220						
		9 KV, 3 PHASE SWITCH STAND, 20'-0' BUS HEIGHT, 5'-0"					ON 5'-0" PHASE SPACING, RATED 2000 AMPS. CONTINUOUS, 80kA			32	24		ANGLE VEE, ALUM. WELD TYPE, 3" SPS AL. RUN TO (2) 3" SPS AL TAP	SEFCOR	WFVT15-6262
Е		HASE SPACING WITH PROVISIONS FOR SWING HANDLE P-MECH	CHAPMAN'S				MOMENTARY, HORIZONTALLY MOUNTED COMPLETE								
										34	40		ANGLE TEE, ALUM. WELD TYPE, 3" SPS AL. RUN TO 3" SPS AL TAP	S SEFCOR	WFTT15-6262
							A) ALUMINUM LIVE PARTS B) NEMA TR-216 GRAY STATION POST INSULATORS			34	40				VVF1115-0202
F		9 KV,2 PHASE BUS SUPPORT STRUCTURE 15'-0" BUS EIGHT, 5'-0" PHASE SPACING	CHAPMAN'S				C) STANDARD ARCING HORNS								
							D) GALVANIZED STEEL BASES			36	3		COUPLER, WELD TYPE 3" SPS ALUM. TO 3" SPS ALUM.	SEFCOR	WSC-6262
G	1 6	9KV, THREE PHASE POTENTIAL TRANSFORMER STAND	CHAPMAN'S				E) MANUAL TYPE "SWING HANDLE" OPERATING MECHANISM			40	84		TERMINAL, ALUM. COMPRESSION TYPE, FOR (2) 1272MCM 45/7 STR. ACSR TO 4 HOLE PAD		AL2-1345-4B
							 PROVISIONS FOR PADLOCKING IN OPEN OR CLOSED POSITION 								
Н	1 6	9KV, THREE PHASE ARRESTER / TERMINATOR STAND	CHAPMAN'S							41	12		TERMINAL, ALUM. COMPRESSION TYPE, FOR (2) 1272MCM 45/7 STR. ACSR TO 4 HOLE PAD, 45 DEG.	/ SEFCOR	AL2-1345-4B-45
		GHTNING MAST (HEIGHT 54'-0")					DEADEND ASSEMBLY FOR STATIC WIRE EACH								
ĸ		GHTNING MAST (HEIGHT 54-0)	CHAPMAN'S	10	6		CONSISTING OF: 1 - ANCHOR SHACKLE (30K)	055000		42	78		CABLE SPACER, BOLTED TYPE FOR (2) 1272MCM ACSR 45/7 STR.	SEFCOR	ASPC-43-4
						B	1 - STRAIN CLAMP FOR 3/8" H.S.S.	SEFCOR SEFCOR	AH-1219-BNC FQD-65						
P	13 3	X4' SWITCH GROUND MAT	CHAPMAN'S							51		LOT	TERMINAL MOUNTING HARDWARE	THREADED FASTENERS	
	H	EADED ANCHOR BOLTS - ASTM 1554-36 BOLTS AND	THREADED	12	9		DEADEND ASSEMBLY FOR INCOMING CONDUCTOR EACH CONSISTING OF:					100	A) 1/2" X 2" S.S. BOLT, NUT, TWO (2) FW & TWO (2) LW		
R	LOT	STM A563 HARDWARE	FASTENERS			A	1 - ANCHOR SHACKLE (30K)	SEFCOR	AH-1219-BNC			180			
	24 1	DIA. X 24" WITH (2) HHN & (2) FW	2B8B			В	1 - SUSPENSION INSULATOR	OHIO BRASS	S025036S2010			320	B) 1/2" X 2-1/4" S.S. BOLT, NUT, TWO (2) FW & TWO (2) LW	·	
	184 1	DIA. X 30" WITH (2) HHN & (2) FW	2B8			C	1 - STRAIN CLAMP FOR 795 ACSR "DRAKE"	SEFCOR	AQD-120-SF			240	C) 1/2" X 2-1/2" S.S. BOLT, NUT, TWO (2) FW & TWO (2) LW	/	
	32 1	1/2" DIA. X 48" WITH (2) HHN & (2) FW	2B12	15	42		69 KV, 350 KV BIL, STANDARD STRENGTH, GRAY STATION POST	NEWELL	231006			380	D) 1/2" X 2-3/4" S.S. BOLT, NUT, TWO (2) FW & TWO (2) LW	/	
							NSULATOR, 5" DIA. BOLT CIRCLE MOUNTING, NEMA TR-216							THREADED	
							38 - FOR BUS INSULATORS			52				FASTENERS	
1	3 B	9 KV, 350 KV BIL, 3 PST, GROUP OPERATED VERTICAL REAK SW.	USCO AVR-07220				1 - FOR SPARE					260	A) 1/2" X 1-1/4" GALV. HEX HD BOLT, ONE FW & LW (INSULATORS)		
		N 7'-0" PHASE SPACING, RATED 2000 AMPS. ONTINUOUS, 100kA					BUS SUPPORT CLAMP, WELD TYPE, 3" SPS AL SCH 40, 5"		+			280	B) 5/8" X 2-1/4" GALV. HEX HD BOLT, NUT, ONE FW & LW (SWITCHES AND PTs)		
		OMENTARY, VERTICALLY MOUNTED COMPLETE WITH:		16	41		BC	SEFCOR	ASWH-62-5-SE			200	C) 5/8" X 3-1/4" GALV. HEX HD BOLT, NUT, ONE FW & LW		
) ALUMINUM LIVE PARTS				_						60	(ARRESTERS)		
	,						TERMINAL, ALUM. WELD TYPE, 3" SPS ALUM. TO 4 HOLE						D) 1/2" X 22" GALV. THREADED ROD, TWO (2) NUT, TWO (2		

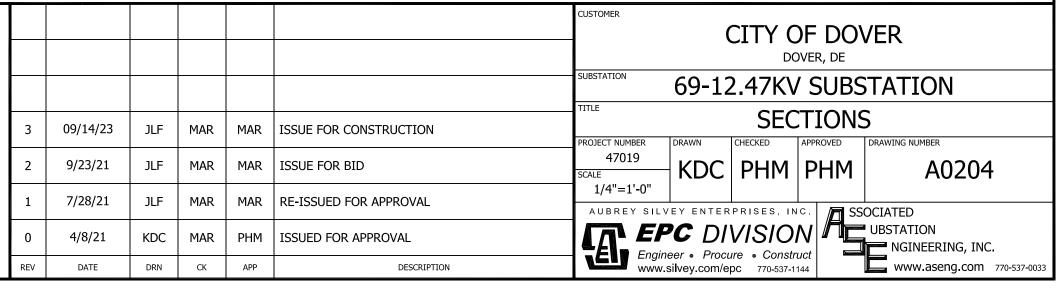CITY OF DOVER 69/12.47kV SUBSTATION DOVER, DE **BILL OF MATERIAL**


								CUSTOMER			F DOV	ER
								SUBSTATION	69-12	2.47KV	SUBS	ΓΑΤΙΟΝ
	THE INFORMATION ON THIS DRAWING IS PROPRIETARY AND IS NOT TO BE USED, REPRODUCED OR COPIED WITHOUT THE WRITTEN CONSENT OF							TITLE		UBSTA		
		2	09/14/23	TLG	MAR	MAR	ISSUE FOR CONSTRUCTION	PROJECT NUMBER 47019 SCALE			APPROVED C	PRAWING NUMBER
	ASSOCIATED SUBSTATION ENGINEERING, INC.	1	9/23/21	JLF	MAR	MAR	ISSUE FOR BID	N.T.S AUBREY SILVEY ENTERPRISES, INC				
		0	4/8/21	JLF	MAR	MAR	ISSUED FOR APPROVAL	1 () ()	PC DI	VISIOI	v / Æ⊑_	JBSTATION INGINEERING, INC.
ENGINEERING SEAL		REV	DATE	DRN	СК	APP	DESCRIPTION		gineer ● Proc /w.silvey.com/e	ure • Constru epc 770-537-114		www.aseng.com 770-537-0033


60 62				DESCRIPTION	EQUAL	MFG PART	#	QTY.	SPARE	DESCRIPTION	EQUAL	MFG PART
62	128	0 40		EET, 3" SPS SEAMLESS ALUMINUM TUBING, SCHEDULE 0, ALLOY 6063-T6, 40 FT. LENGTHS	WILLIAMS METALS					BELOW GRADE GROUNDING		
	110	0		EET, DAMPING CABLE FOR 3" SPS SCH 40 AL. BUS, 66.6MCM ACSR "PARTRIDGE"	METRO WIRE	PARTRIDGE	101	1100	0	FEET, 4/0 AWG, 7 STRAND, S.D. BARE COPPER (7 - 1500 FOOT REELS)	METRO WIRE	
63	950		F	EET, 1272 MCM ACSR CABLE, 45/7 STRANDING	METRO WIRE	BITTERN	102	4	1	3/4" x 8'-0" LONG, NON-SECTIONAL OR SECTIONAL GROUND RODS (PWC348)	CADWELD	PWC348 41
66	15	0	F	EET, 795 MCM ACSR CABLE, 26/7 STRANDING	METRO WIRE	DRAKE	104	4	1	COMPRESSION CONNECTOR 4/0 COPPER TO 3/4" GROUND ROD	BURNDY	YGL34C29 42
68	120		F	EET, 4/0 AWG. ACSR CABLE, 6/1 STRANDING, "PENGUIN"	METRO WIRE	PENGUIN	105	35	0	TEE COMPRESSION CONNECTOR 4/0 COPPER TO 4/0 COPPER	BURNDY	YGHC29C29 43
75	210	0	(/	EET, 4/0 AWG, STRAND COPPER, S.D. ABOVE GRADE STRUCTURE AND EQUIPMENT APs/GROUNDING)	METRO WIRE		106	204	4	CROSS COMPRESSION CONNECTOR 4/0 COPPER TO 4/0 COPPER	BURNDY	YGL29C29 44
76	55	0		EET, # 2 AWG, SOLID COPPER, TINNED, S.D.	METRO WIRE		111	20	A)	LED LIGHTS	AEL	ACP0LED-PK3-M VOLT-WFL-40K-T M-BZSDP-TL-NL
79		5	G	GROUND CLAMP, BRONZE BOLTED, PARALLEL RUN: 1/0 - /0 STR, TAP: #8 STR. To #1 STR.	SEFCOR	PDC-1107			B)	SHORTING CAPS BULL HORNS	AEL IRBY	5560-SC EQ-701
80	2	8	C	CONNECTOR, BRONZE COMPRESSION, 4/0 AWG. COPPER		YGHA28-2N	300	1		69 / 12.47KV POWER TRANSFORMER WITH LIGHTNING ARRESSTERS	GE PROLEC	4
81	4	5	G	GROUND CLAMP, BRONZE BOLTED, PARALLEL #6 STR. To /0 STR.		PL-50	304	12		69 KV, STATION CLASS LIGHTNING ARRESTER 48 KV MCOV) INCOMING LINES	OHIO BRASS	48
82	20	0		BROUND CLAMP, BRONZE BOLTED, 1/C, #4 - 300 CU TO LAT	SEFCOR	GTC-14	306	12		69KV, POTENTIAL TRANSFORMER, 350:1 AND 600:1 RATIO	TBD	49
83	6	0		GROUND CLAMP, BRONZE BOLTED, 2/C, #4 - 300 CU TO LAT	SEFCOR	GTC2-14	307	3		69KV, CABLE TERMINATORS	TBD	50
89		1		ERMINAL, BRONZE BOLTED, # 6 - 250 MCM, CU. TO 4 IOLE PAD	SEFCOR	FNCT-12-4A	310	6		69 KV, 2000A SF6 CIRCUIT BREAKER WITH EACH BUSHING HAVING 2 SETS OF 2000:5 MRCT, CLASS C800	SIEMENS	SPS2 72.5
90	2	4		ERMINAL, BRONZE BOLTED, # 6 - 250 MCM, CU. TO 2 IOLE PAD	SEFCOR	FNCT-12-2A	315	1		CIRCUIT SWITCHER WITH INTREGRAL DISCONNECT BLADE, RATED 1200AMPS	SOUTHERN STATES	CSV 72.5
				FENCE GROUNDING			320	4		POTENTIAL TRANSFORMER JUNCTION BOX	HOFFMAN	5.
91	4		P	GROUND CLAMP, FOR 4/0 STR. CU. TO 3" O.D. CORNER	SEFCOR	GU1-6012	321	11		YARD LIGHT JUNCTION BOX	HOFFMAN	54
92	50		P	BROUND CLAMP, FOR 4/0 STR. CU. TO 2 1/2" O.D. LINE	SEFCOR	GU1-5812	323	6		CABLE CLAMPS FOR INCOMING U/G CABLE	ТҮСО	55
93	4		C	BROUND CLAMP, FOR 4/0 STR. CU. AND FLEX BRAID TO 4"	SEFCOR	GU1-6312	330	LO	г	CABLE TRENCH SYSTEM	TBD	50
94	4		F	BROUND CLAMP, FOR FLEX BRAID TO 2" O.D. GATE RAME	SEFCOR	GBR-54	340		1	SCADA PANEL	TBD	5
95	4		F	LEXIBLE SHUNT, 24" LONG FOR GATE POST TO GATE RAME CONN. SPLIT BOLT, BRONZE FOR #6 SOLID COPPER	SEFCOR	XBG146-D-24	350		9	RELAY PANELS (30"W x 30" D x 90"H) REFERENCE DRAWINGS 39218B03-B04	TBD	

CITY OF DOVER 69/12.47kV SUBSTATION DOVER, DE **BILL OF MATERIAL**

									(F DO VER, DE	/ER
								SUBSTATION	69-12	2.47KV	SUBS	TATION
	THE INFORMATION ON THIS DRAWING IS PROPRIETARY AND IS NOT TO BE USED, REPRODUCED OR COPIED WITHOUT THE WRITTEN CONSENT OF							TITLE		JBSTA		
		2	09/14/23	TLG	MAR	MAR	ISSUE FOR CONSTRUCTION	PROJECT NUMBER 47019		CHECKED MAR		drawing number A0501
	ASSOCIATED SUBSTATION ENGINEERING, INC.	1	9/23/21	JLF	MAR	MAR	ISSUE FOR BID	N.T.S				A0301
		-		-				AUBREY SI				
ENGINEERING SEAL		0	4/8/21	JLF	MAR		ISSUED FOR APPROVAL		nineer • Proci	ure • Constru		NGINEERING, INC.
		REV	DATE	DRN	CK	APP	DESCRIPTION	WWV	w.silvey.com/e	pc 770-537-11	44	www.aseng.com 770-537-0033

ASE-ITEM #	QTY.	SPARE	DESCRIPTION	MFG OR EQUAL	MFG PART
360	LOT		CONDUIT	TBD	
370	LOT		CONTROL CABLE	TBD	
380	LOT		GALVANIZED CHAIN LINK FENCE, & STONE SURFACING	TBD	
410	1		SWITCHGEAR #1 BUILDING CONTAINING THE FOLLOWING:	TBD	
420	1		12.47KV SWITCHGEAR	SIEMIENS	
430	1		AC PANEL	TBD	
440	1		AUTOMATIC THROWOVER SWITCH, NEMA 1, 3 phase	твр	
450	1		DC PANEL	твр	
460	1		BATTERY CHARGER	TBD	
470	1		BATTERY SYSTEM	твр	
480	1		BATTERY RACK	твр	
490	1		BATTERY SPILL CONTAINMENT SYSTEM	TBD	
500	1		EYE WASH STATION	Bradley	S19-220
510	2		FIRE EXTINGUISHERS	Kidde	Grainger 4T889
520	1		WORK TABLE 30" X 48"	Grainger	3W252
530	2		SAFETY DISCONNECT	твр	
540	2		HVAC UNITS	TBD	
550	1		1 - EXHAUST FAN	TBD	
560	1		1 - INTAKE VENT	TBD	
	2		EMERGENCY EXIT LIGHT	TBD	

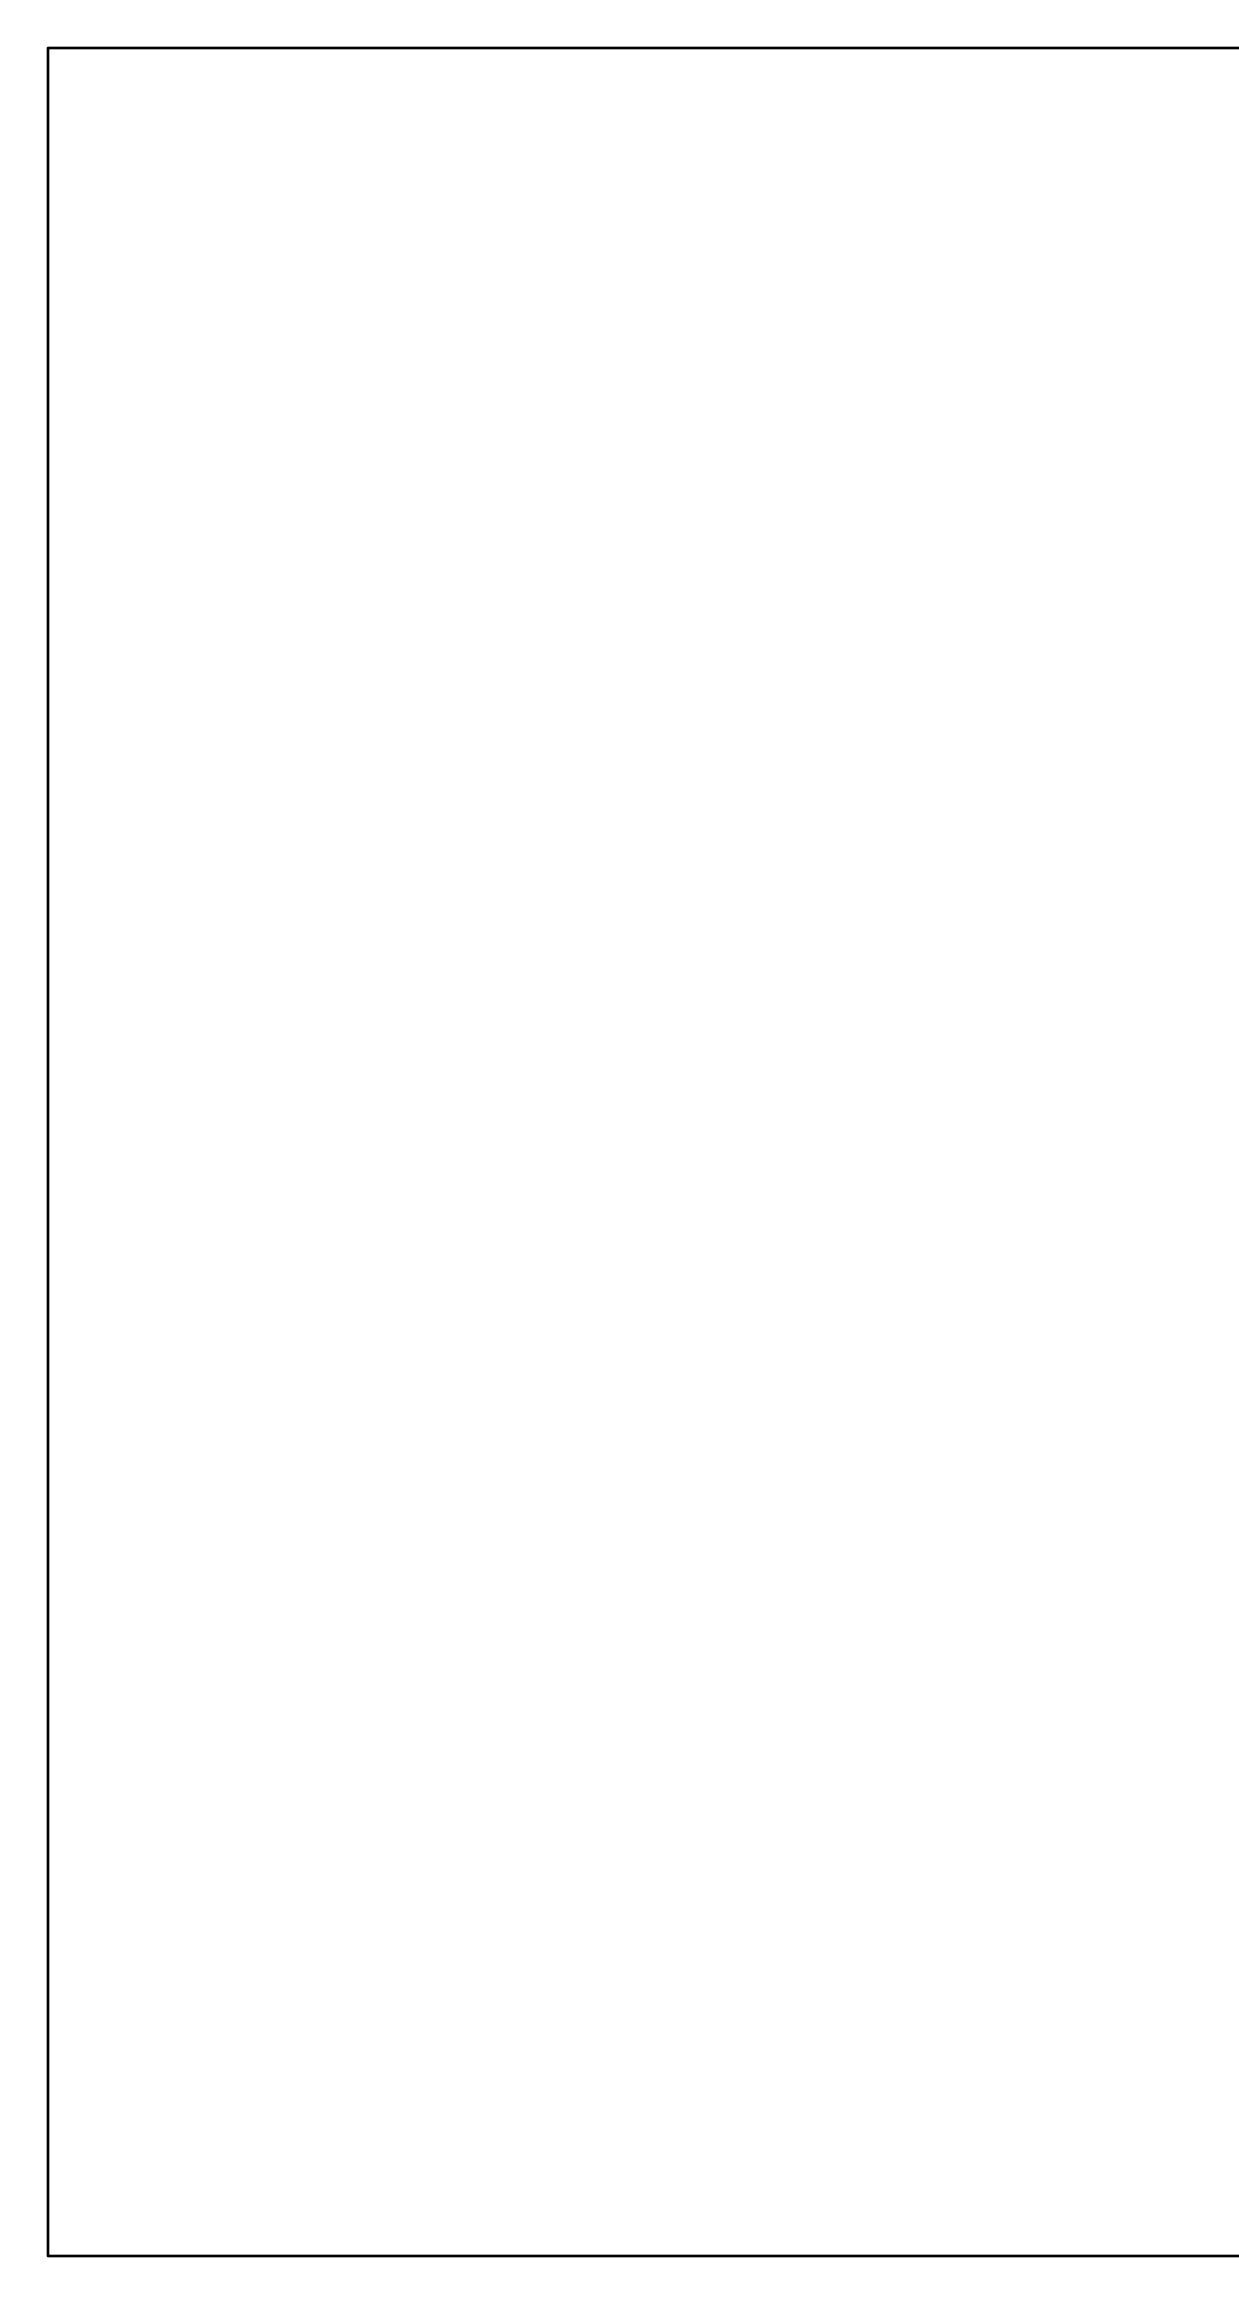

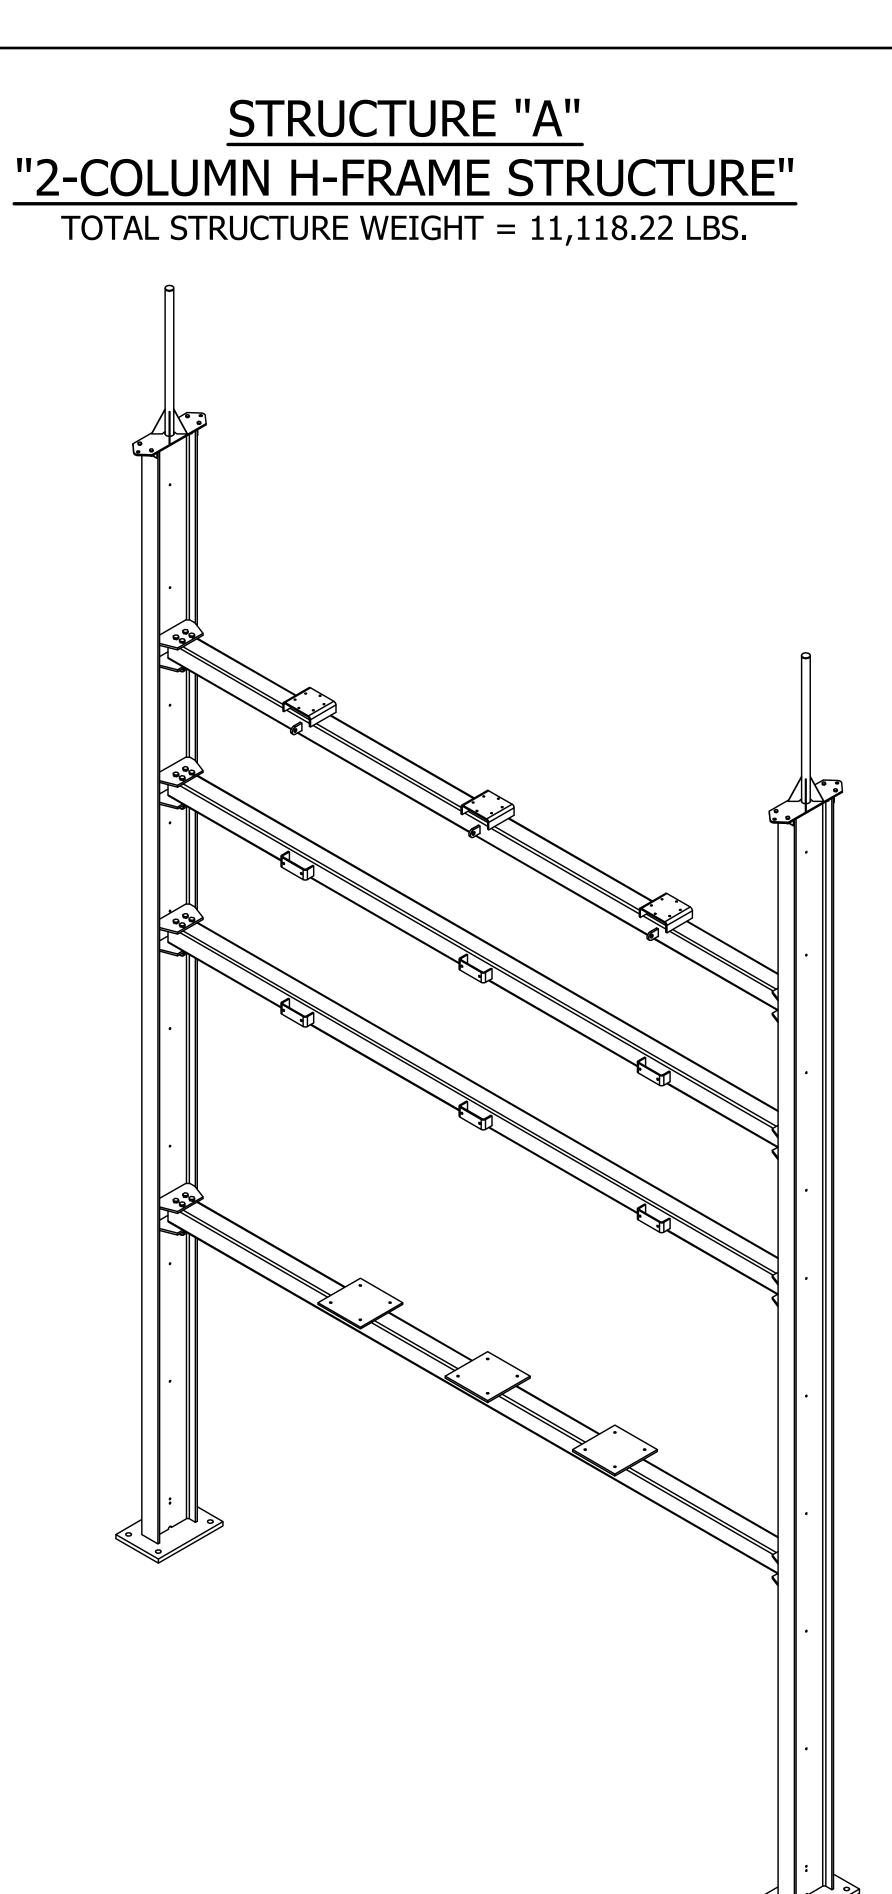


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			ANCHOR BOLTS
QTY	DIA	LENGTH	DECSRIPTION
8	1 1/2"	4'-0"	GALVANIZED ANCHOR BOLTS WITH 2 HHN AND 2 FW (F1554-GR55)

<u>MAKE STRUCTURE "A"</u> <u>"4" - TIMES</u>

						REFERENCE DRAWINGS
					DRAWING NUMBER	DESCRIPTION
					SA100	STRUCTURE "A" COVER SHEET
					SA200	STRUCTURE "A" ELEVATIONS
					SA300	STRUCTURE "A" ASSEMBLIES & DETAILS BOM
					SA301	STRUCTURE "A" ASSEMBLIES & DETAILS BOM
						CUSTOMER CITY OF DOVER DOVER, DELAWARE SUBSTATION 69-12.47 KV SUBSTATION TITLE STR. A - COVER SHEET PROJECT NUMBER 47019 SCALE JLF JKG MAR SA100
9/14/23	JRG	JKG	MAR	ISSUED FOR CONSTRU	CTION	NTS
9/23/21	KDC	JKG	MAR	ISSUE FOR BID		AUBREY SILVEY ENTERPRISES, INC. EPC DIVISION Engineer • Procure • Construct
DATE	DRN	СК	APP	DESCR	IPTION	www.silvey.com/epc 770-537-1144 www.aseng.com 770-537-0033

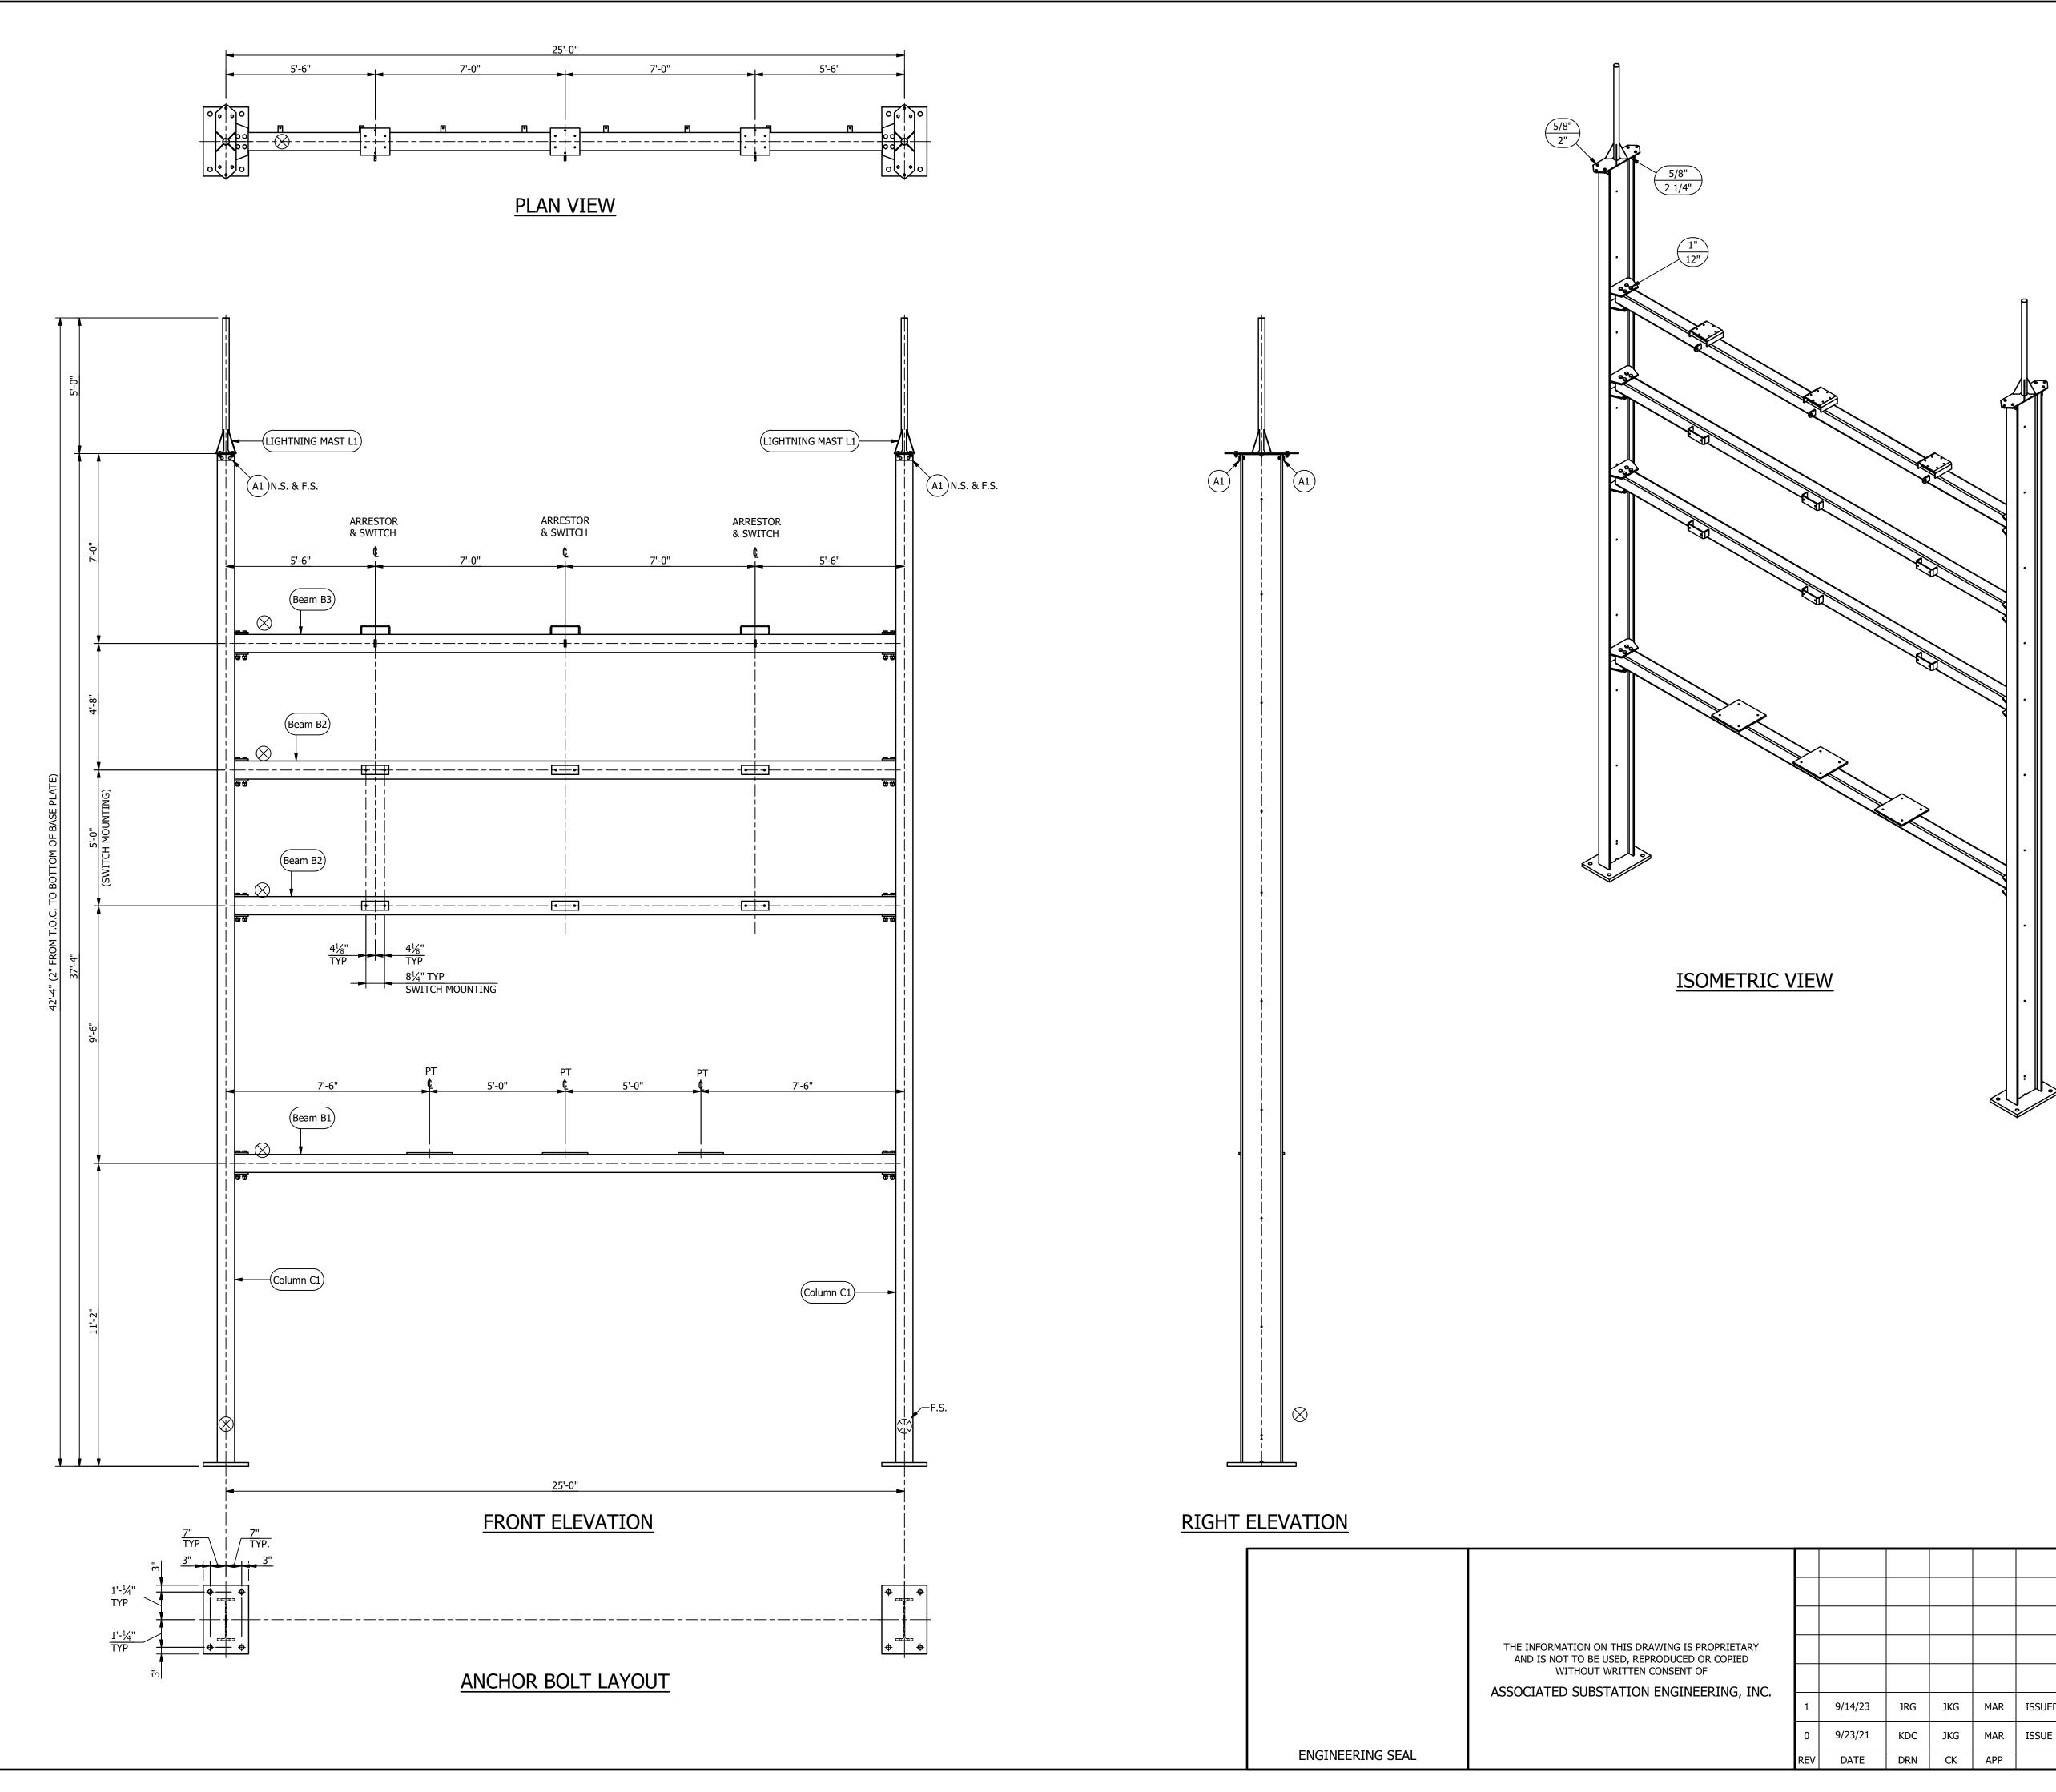

ASSEMBLY LIST

MARK	QTY
Beam B1	1
Beam B2	2
Beam B3	1
Column C1	2
LIGHTNING MAST L1	2

MATERIAL LIST								
MARK	QTY	DESCRIPTION						
A1	4	L3 X 3 X 3/8						

NOTES:

1. ALL ASTM A36 OR A992/A572 GRADE-50 STEEL UNLESS NOTED. ALL TUBING - ASTM A500 GRADE C. ALL STRUCTURAL PIPE - ASTM A53 GRADE-B.

2. ASTM A325 ERECTION BOLTS. USE THE SHORTEST BOLT THAT WILL ALLOW A F436 FLAT WASHER AND A A563 NUT.

- 3. ALL HOT DIP GALVANIZED AFTER FABRICATION (ASTM A123).
- 4. ALL HOLES <u>Ø11/16"</u> FOR <u>Ø5/8"</u> BOLTS UNLESS NOTED.
- 5. MINIMUM EDGE DISTANCE **<u>7</u>/8**" UNLESS NOTED.


6. PIECE MARK STAMPED INTO METAL WITH NOT LESS THAN 3/8" HIGH CHARACTERS BEFORE GALVANIZING.

7. ALL WELDING ELECTRODES SHALL BE E70XX.

8. \bigotimes Mark Indicates proper orientation of structural pieces.



						REFE	RENCE	E DRA	WINGS	5
					DRAWING NUMBER			DES	CRIPTION	
					SA100	STRUCTURE "A"	COVER SHI	EET		
					SA200	STRUCTURE "A"	ELEVATION	١S		
					SA300	STRUCTURE "A"	ASSEMBLIE	ES & DETAIL	S BOM	
					SA301	STRUCTURE "A"	ASSEMBLIE	ES & DETAIL	S BOM	
						TITLE	69-12	.47 KV	, delaware	
0/14/22	10.0	140			TION	47019 SCALE NTS	JLF	JKG	MAR	SA200
9/14/23	JRG	JKG	MAR	ISSUED FOR CONSTRUC	LITON	AUBREY SILVE	Y ENTERP	RISES, INC	5. 🛛 🗖 S	SOCIATED
9/23/21	KDC	JKG	MAR	ISSUE FOR BID			-	VISIOI re • Constru		UBSTATION
DATE	DRN	СК	APP	DESCR	IPTION	www.si	ilvey.com/ep			www.aseng.com 770-537-0033

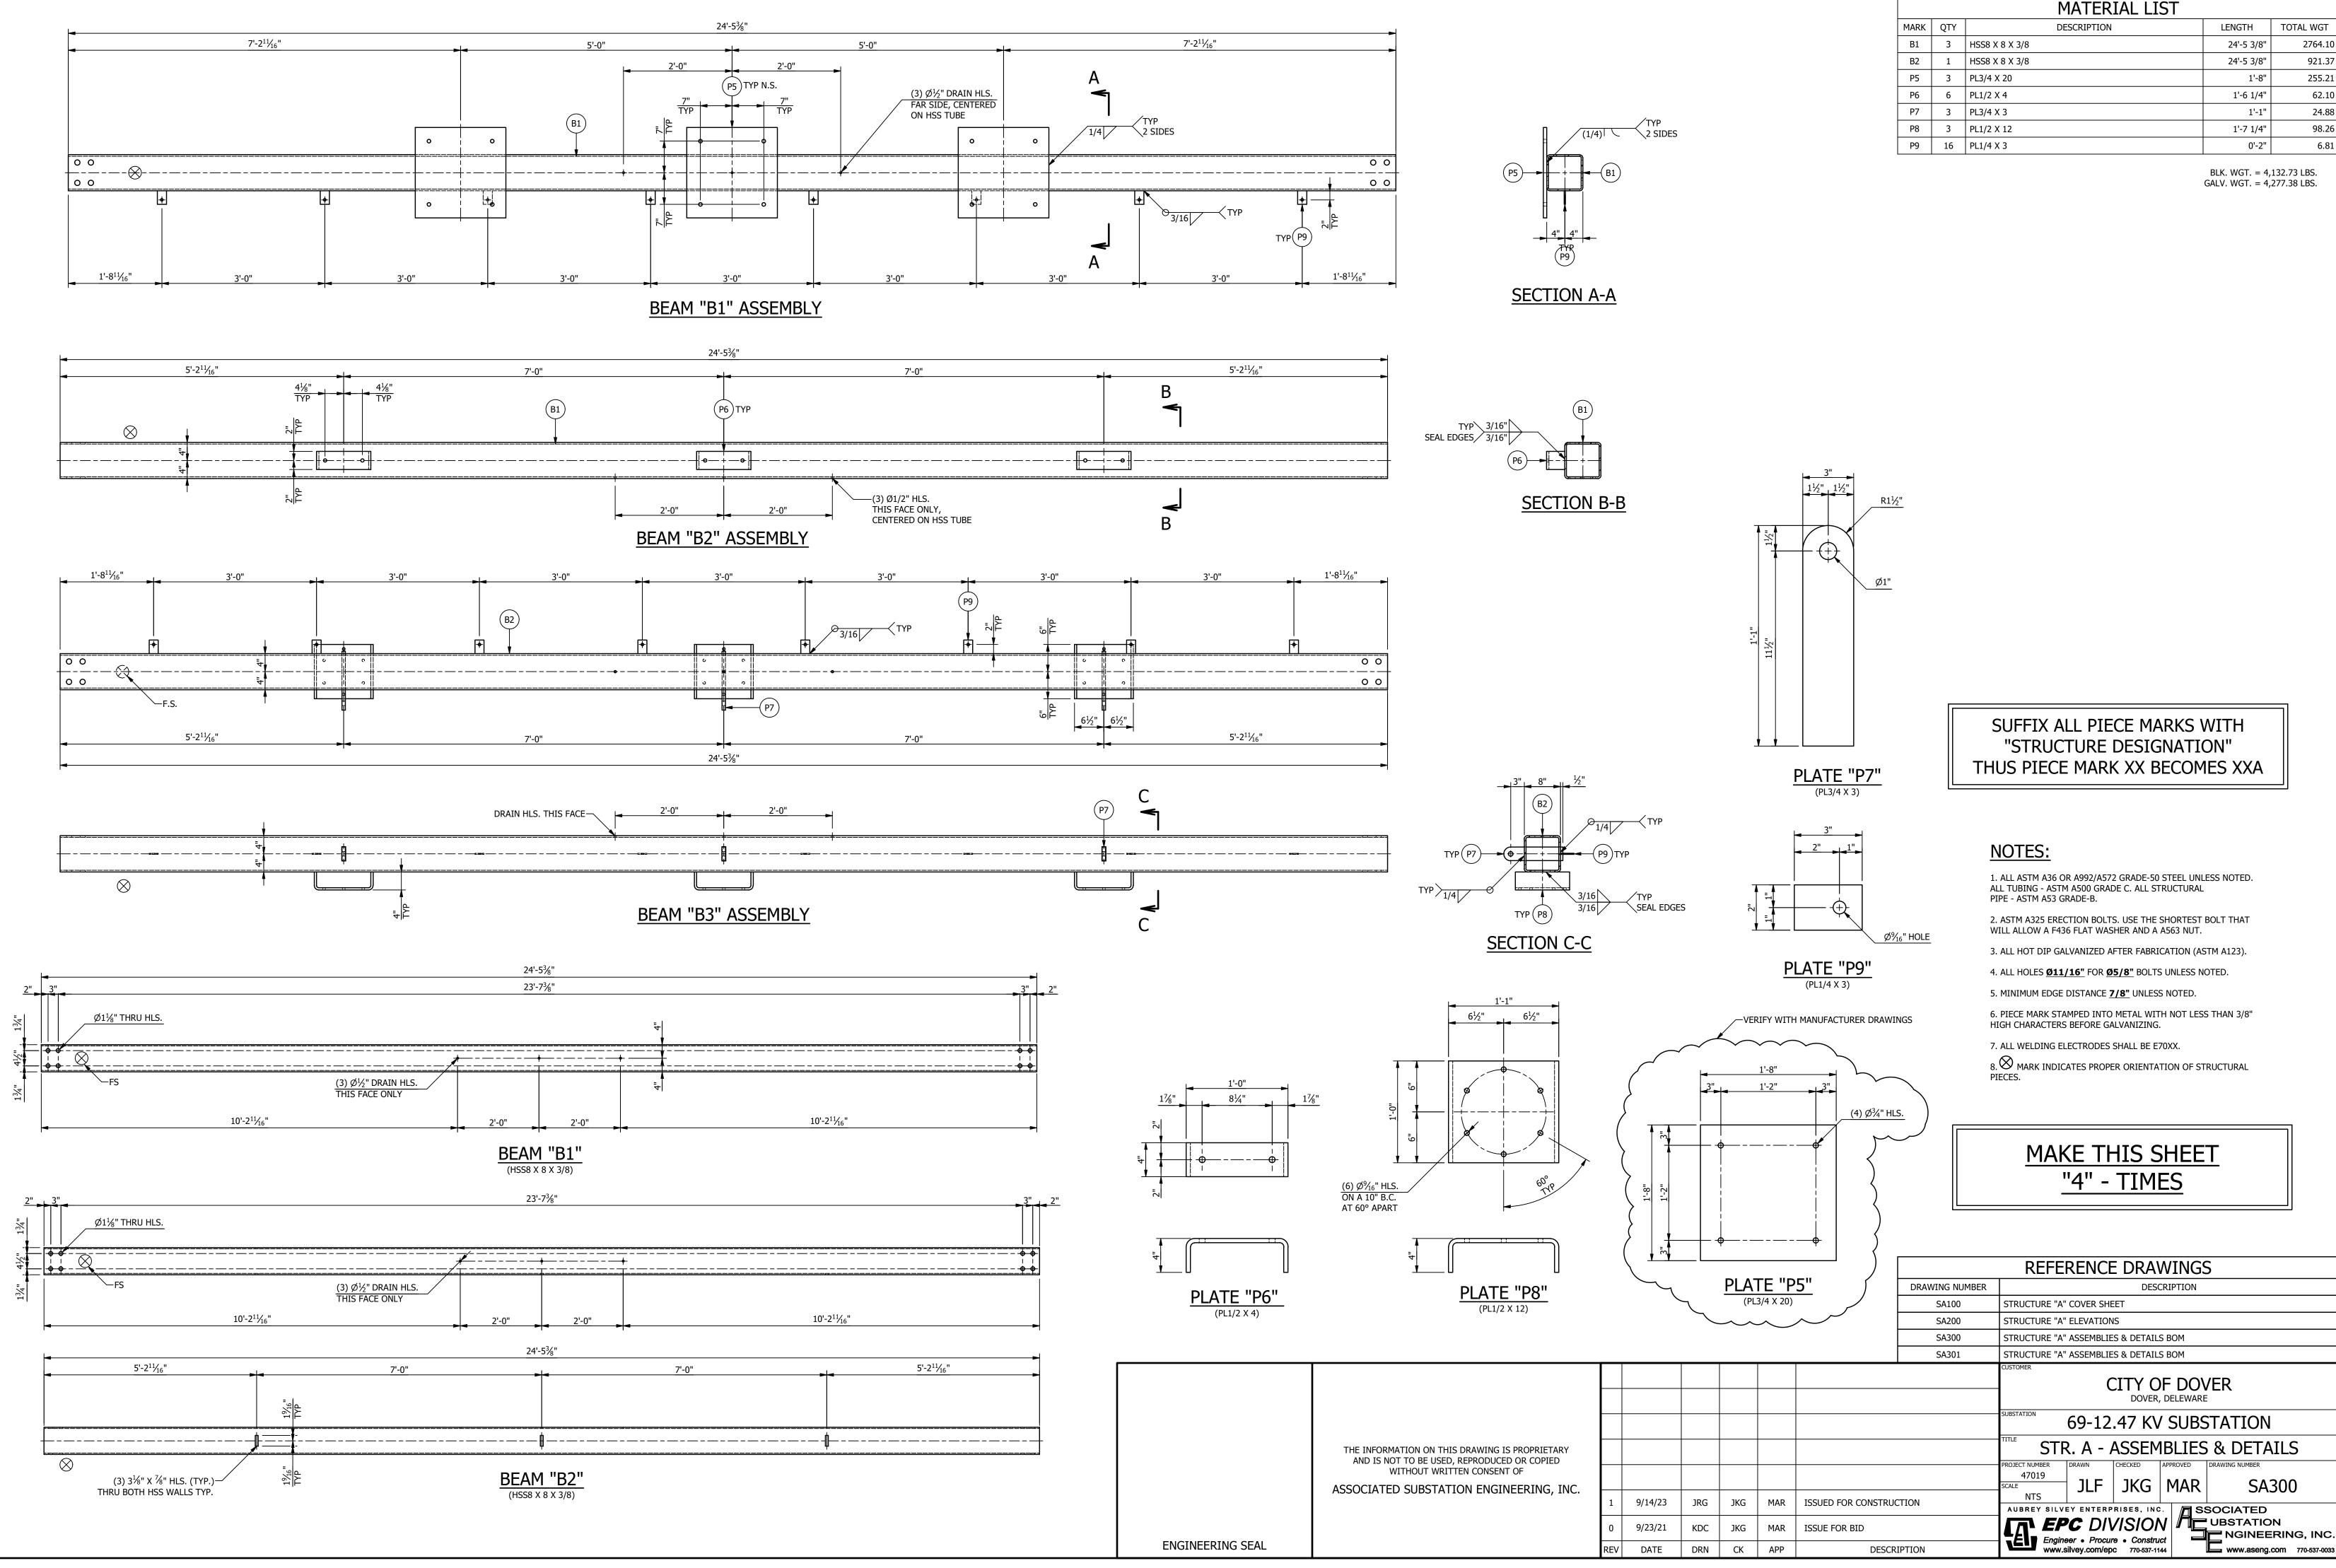


		MATERIAL LIST			
	MARK	QTY	DESCRIPTION	LENGTH	TOTAL WGT
	B1	3	HSS8 X 8 X 3/8	24'-5 3/8"	2764.10
	B2	1	HSS8 X 8 X 3/8	24'-5 3/8"	921.37
	P5	3	PL3/4 X 20	1'-8"	255.21
	P6	6	PL1/2 X 4	1'-6 1/4"	62.10
	P7	3	PL3/4 X 3	1'-1"	24.88
TYP 2 SIDES	P8	3	PL1/2 X 12	1'-7 1/4"	98.26
	Р9	16	PL1/4 X 3	0'-2"	6.81
				BLK. WGT. = 4,	











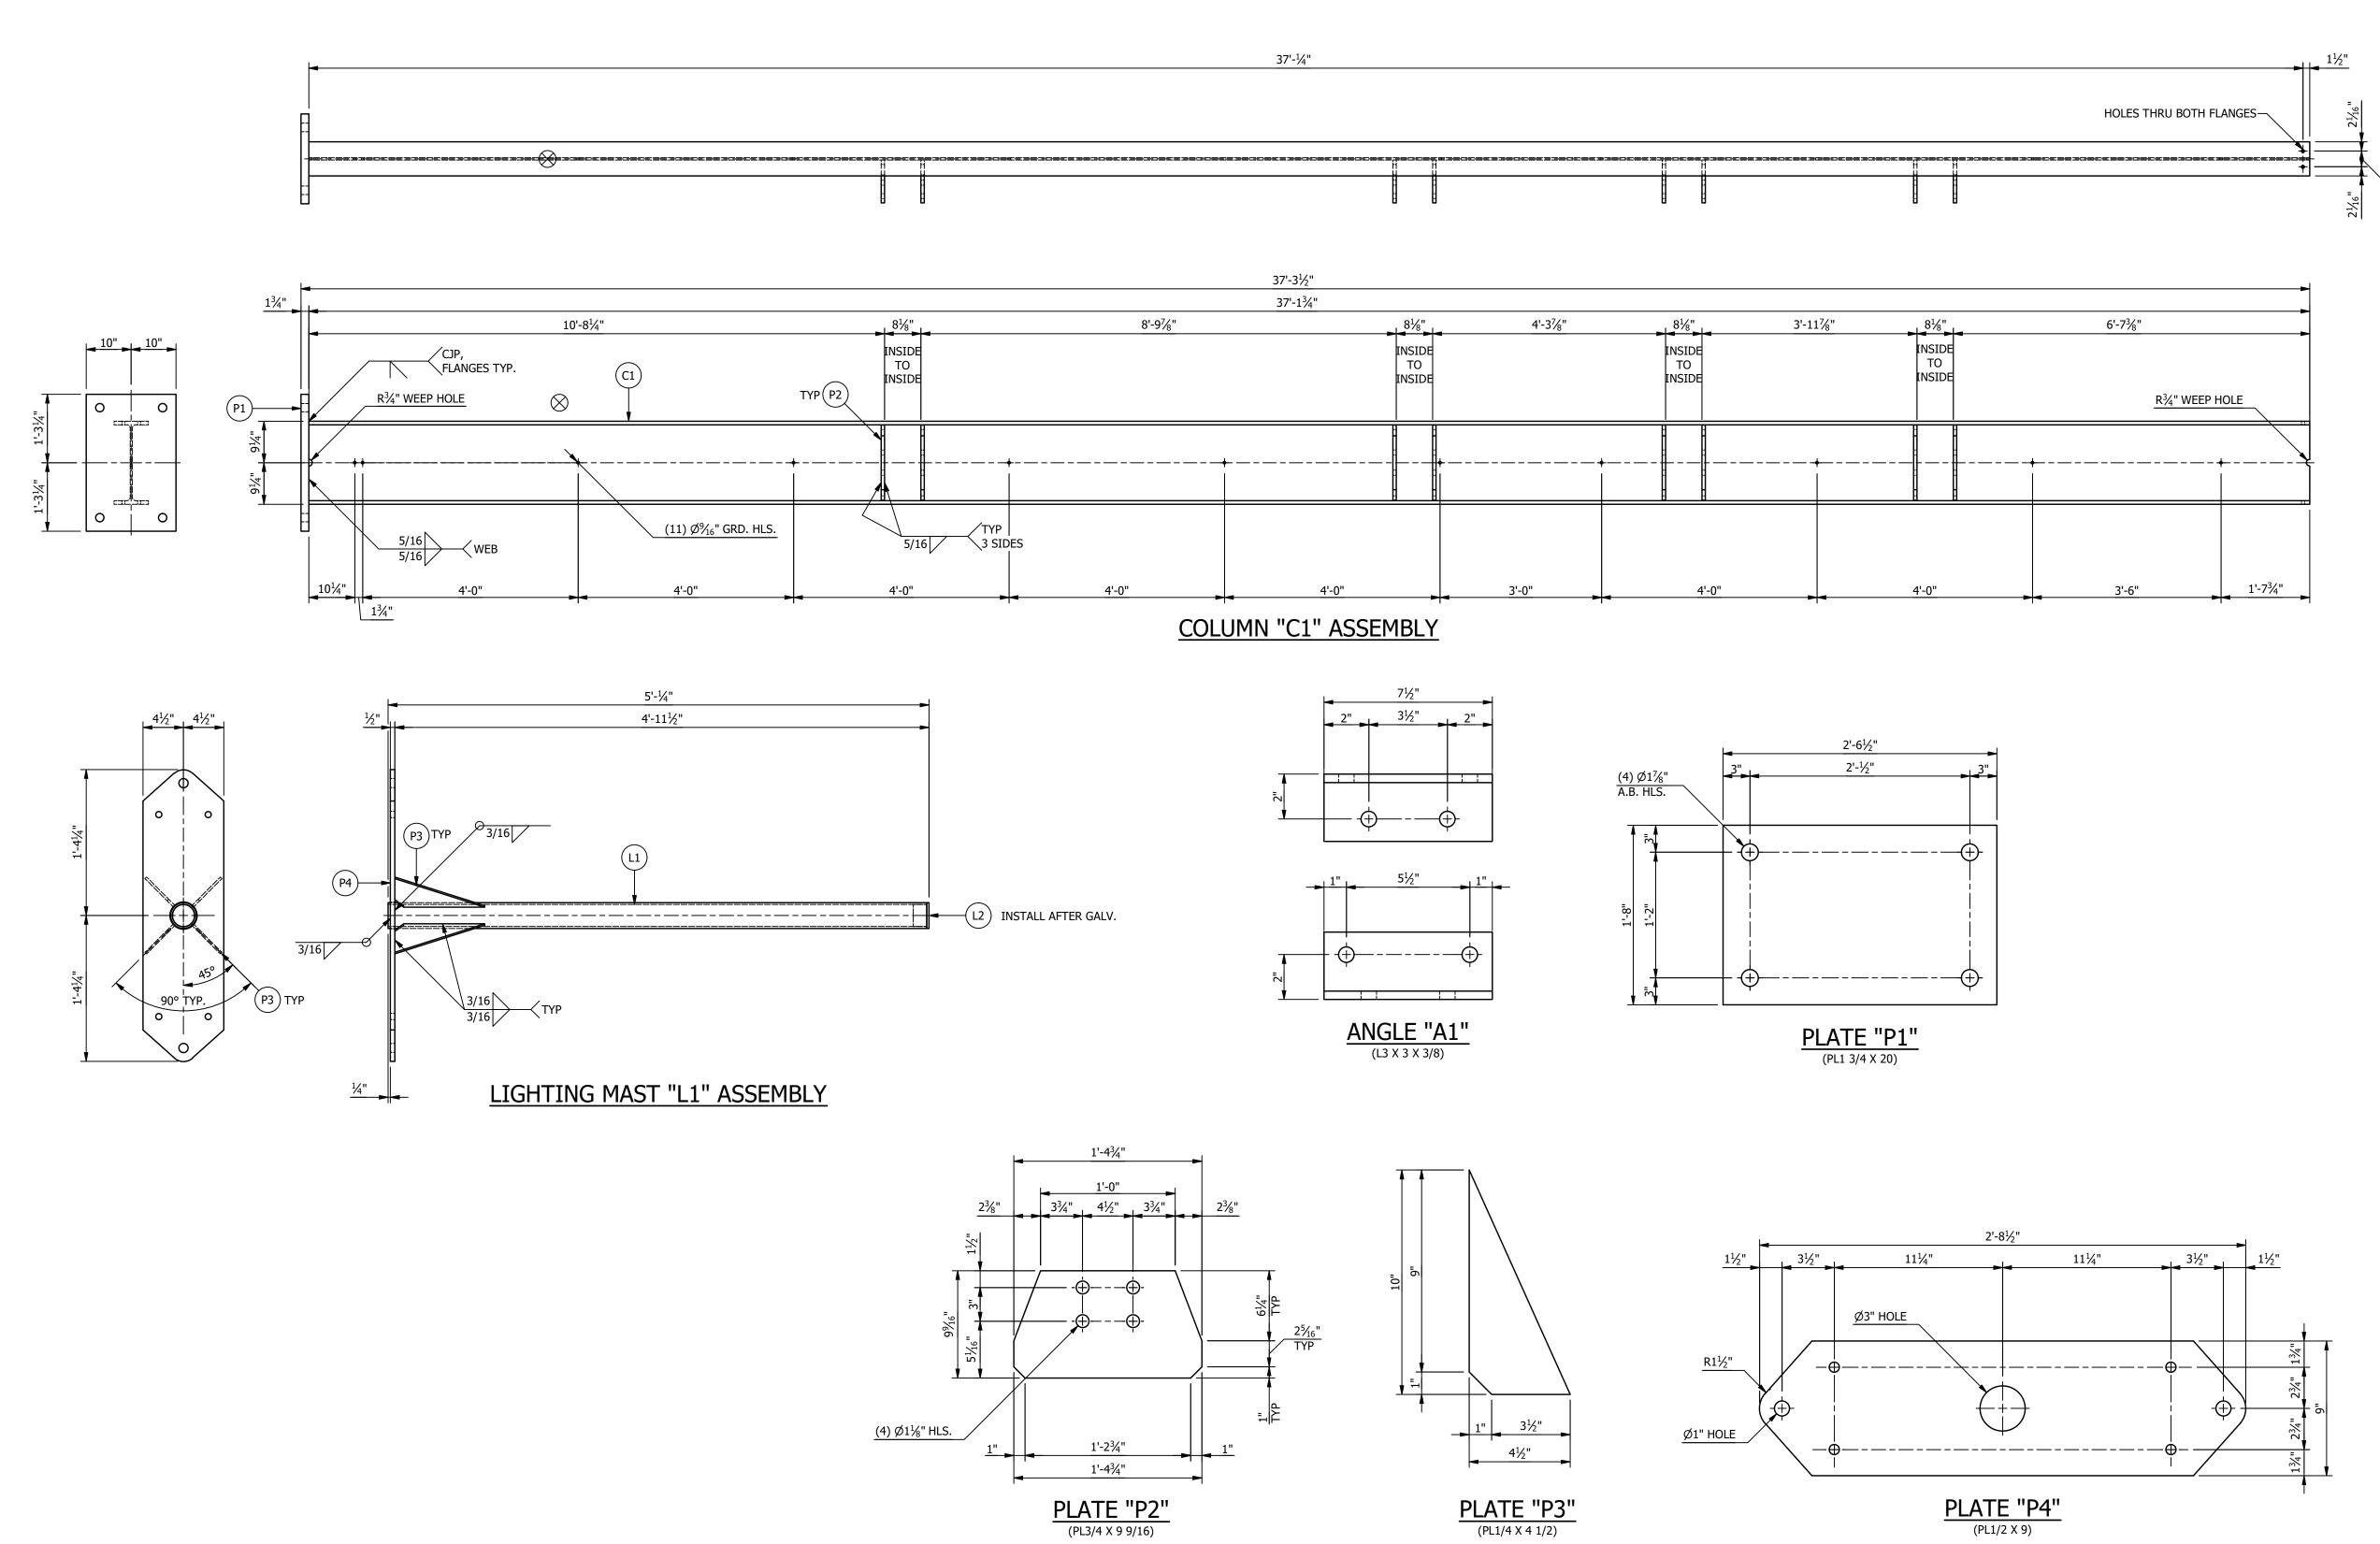

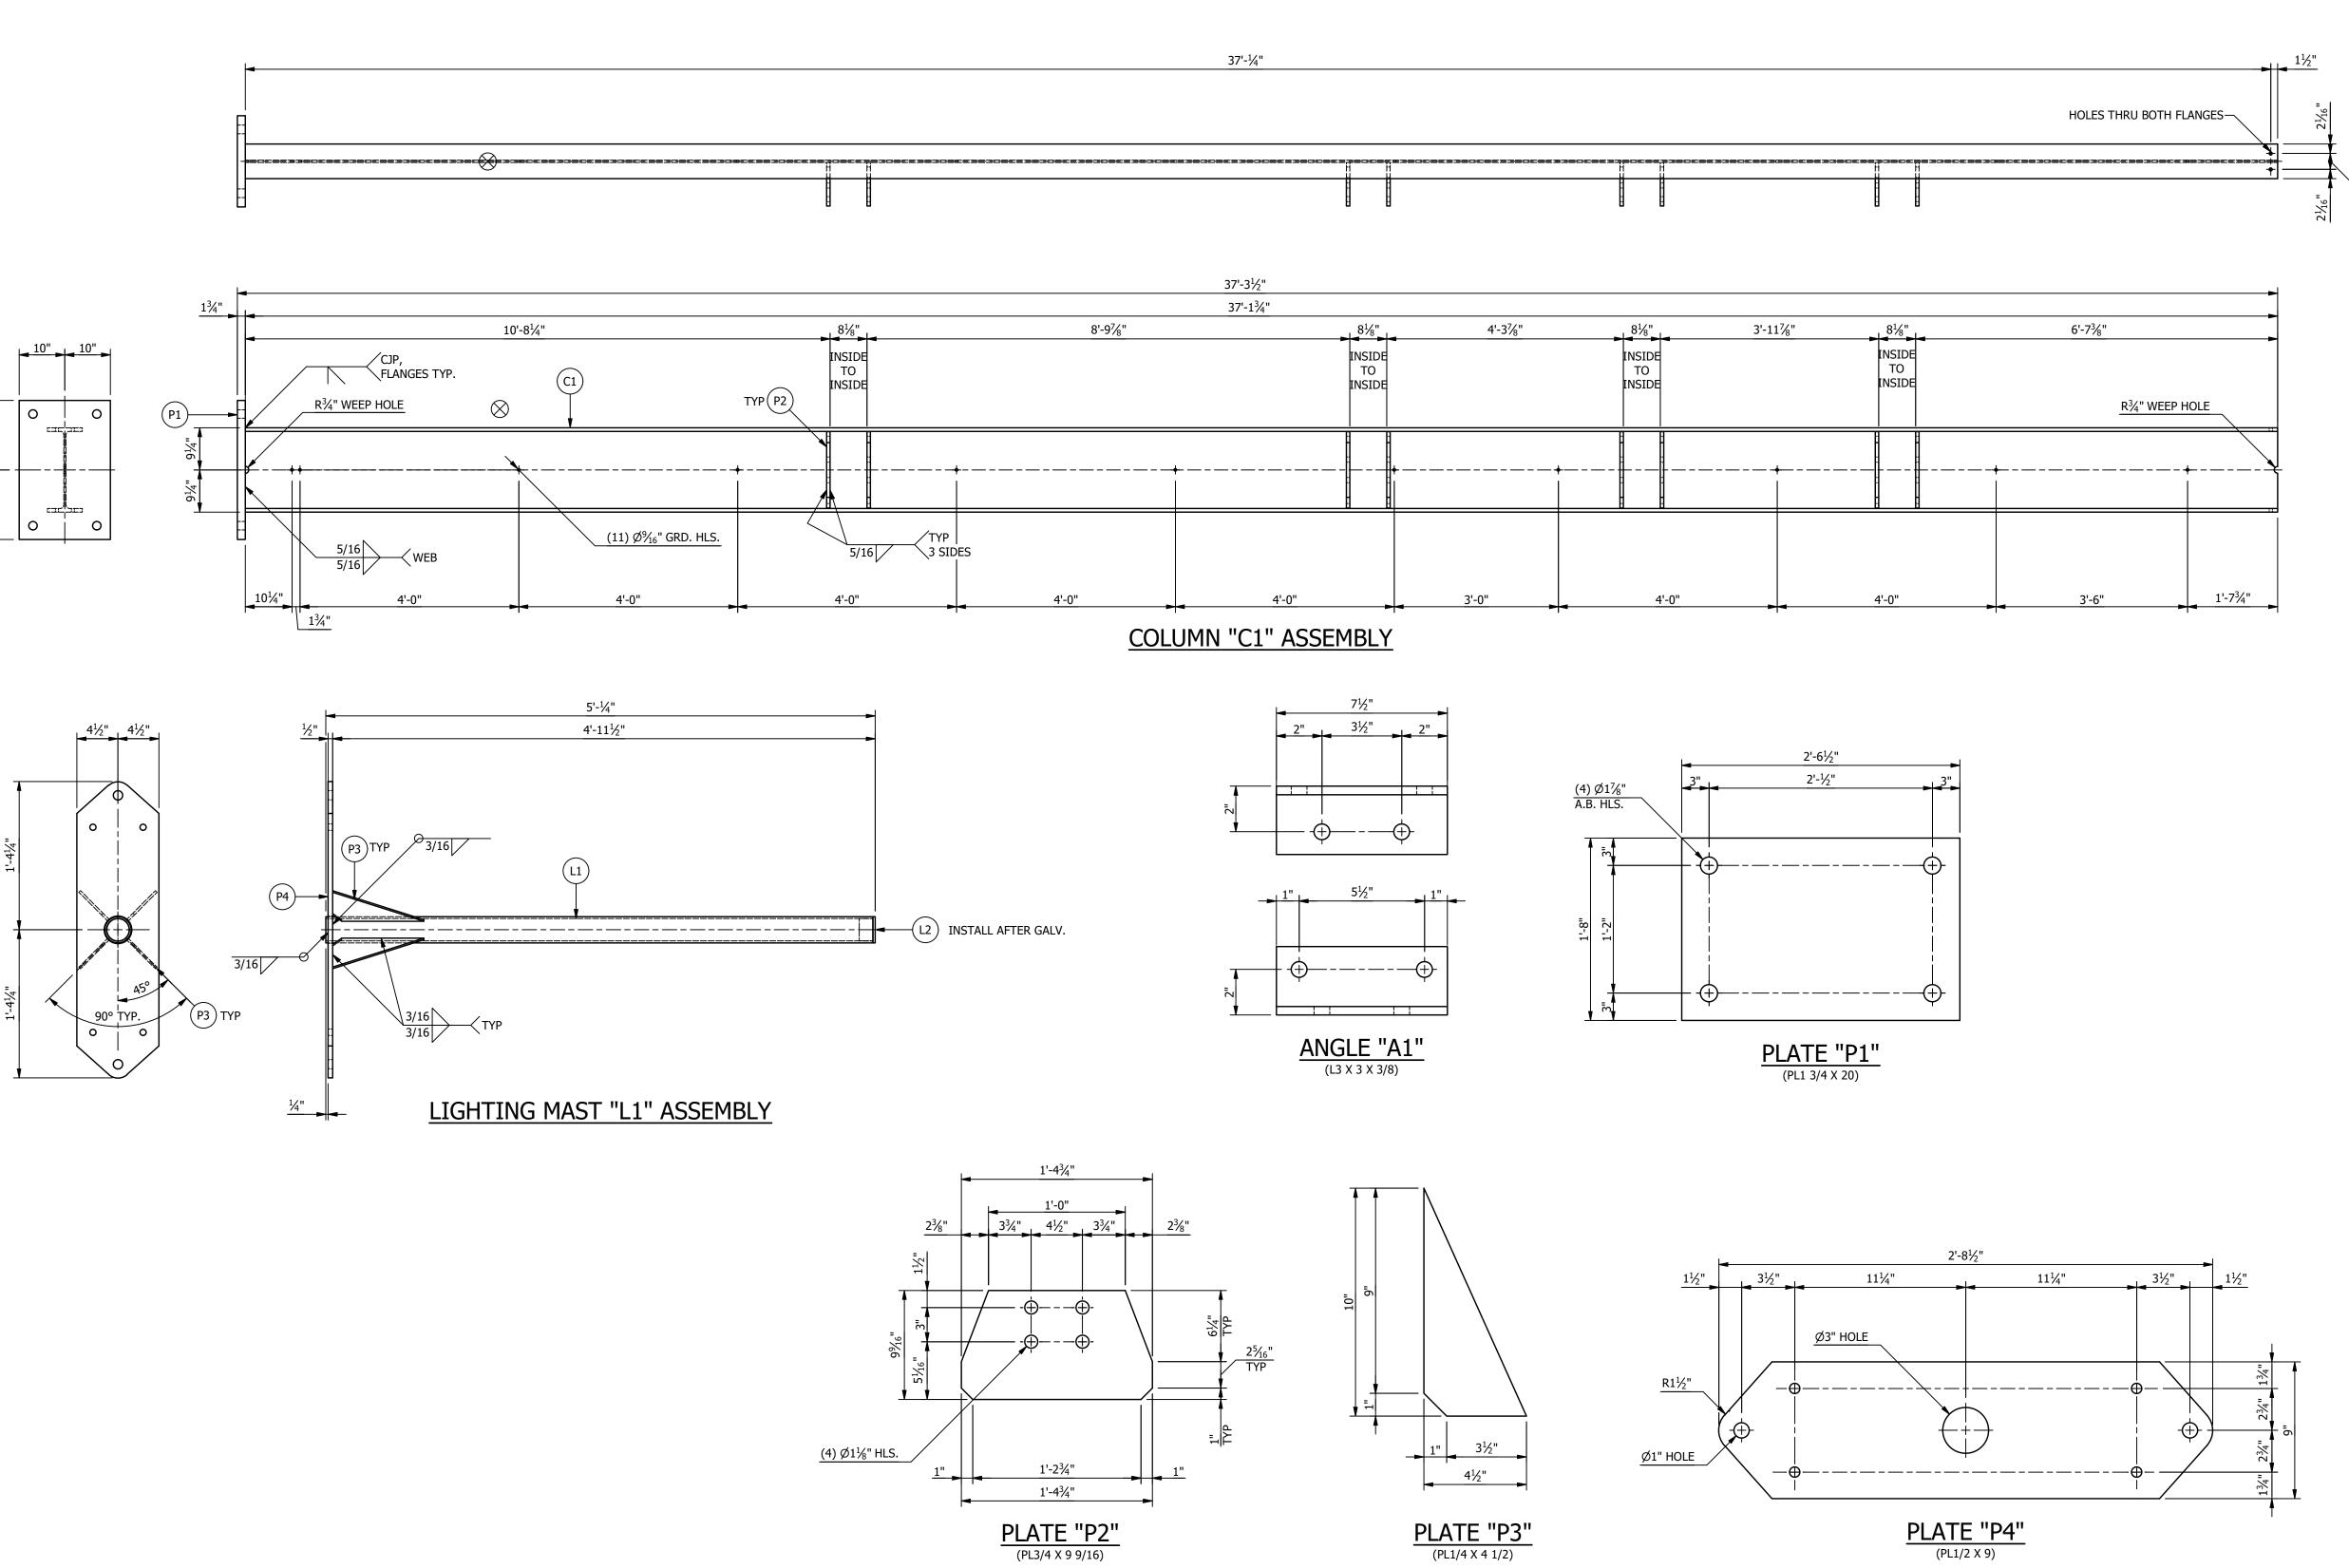

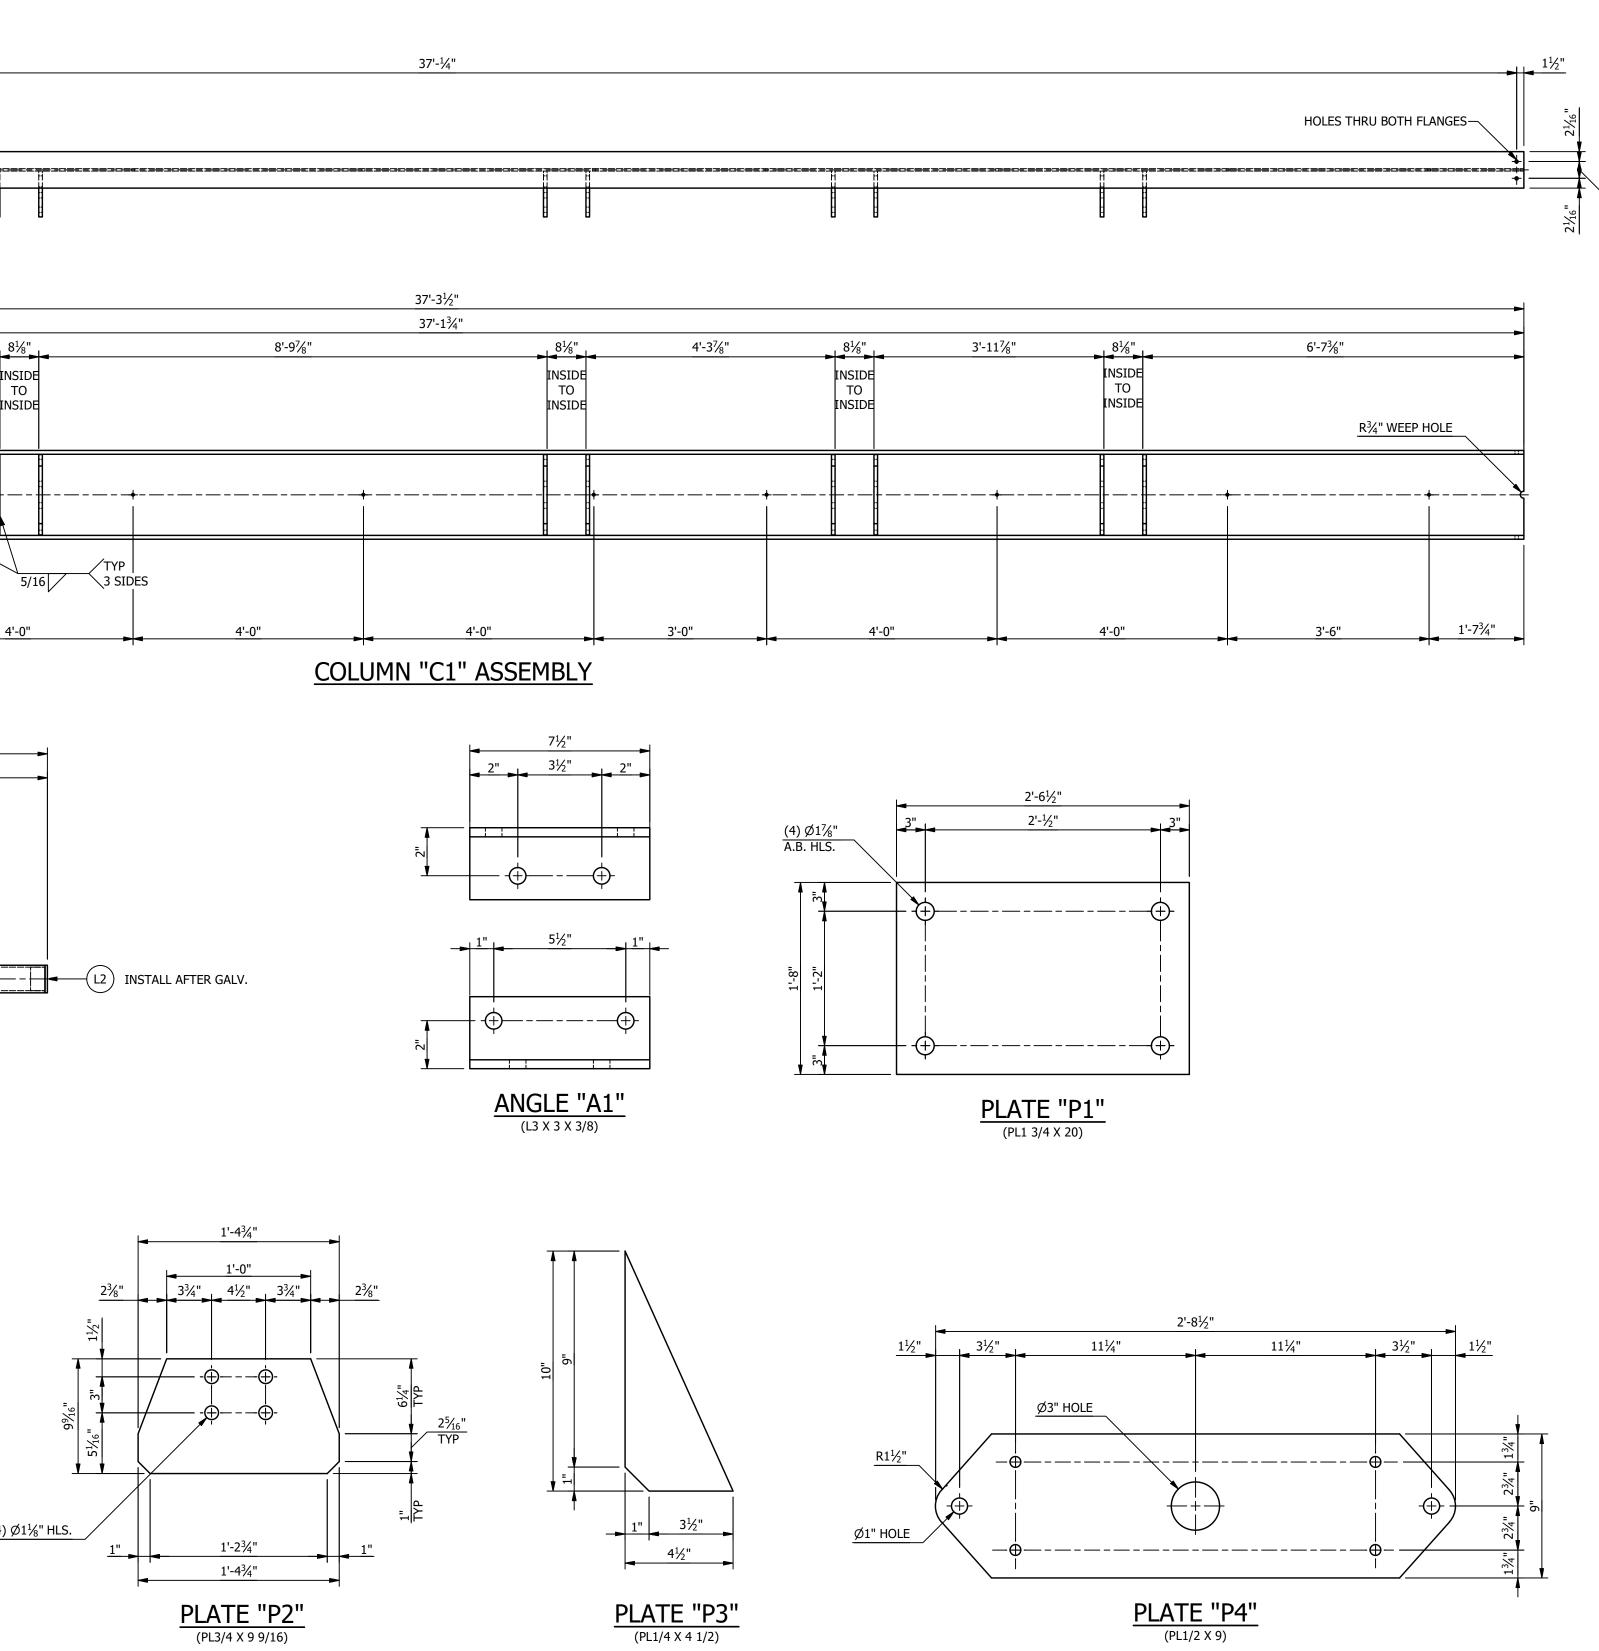

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	WITHOUT WRITTEN CONSENT OF	
	ASSOCIATED SUBSTATION ENGINEERING, INC.	
		1
		0
ENGINEERING SEAL		REV

		MATERIAL LIST					
	MARK	QTY	DESCRIPTION	LENGTH	TOTAL WGT		
	A1	4	L3 X 3 X 3/8	0'-7 1/2"	18.00		
	C1	2	W18 X 71	37'-1 3/4"	5274.71		
n 	L1	2	2 1/2" DIA SCH 40 PIPE STANDARD WEIGHT	5'-0"	57.90		
	L2	2	2" SCH 40 PIPE CAP (INSTALL AFTER GALV.)		.00		
2 <u>%6</u>	P1	2	PL1 3/4 X 20	2'-6 1/2"	605.41		
2,1	P2	16	PL3/4 X 9 9/16	1'-4 3/4"	545.03		
-†	P3	8	PL1/4 X 4 1/2	0'-10"	25.52		
31/2"	P4	2	PL1/2 X 9	2'-8 1/2"	82.94		
2¼6		-		BLK. WGT. = (5,609.51 LBS.		

BLK. WGT. = 6,609.51 LBS. GALV. WGT. = 6,840.84 LBS.

TOTAL STR. BLK. WGT. = 10,742.24 LBS. TOTAL STR. GALV. WGT. = 11,118.22 LBS.

	STRUCTURE BOLT ASSEMBLIES								
QTY	DIA	LENGTH	DESCRIPTION						
36	1"	12"	GALV A325 HHB W/ GALV F436 HARDENED FW & GALV A563-DH HHN						
10	5/8"	2 1/4"	GALV A325 HHB W/ GALV F436 HARDENED FW & GALV A563-DH HHN						
10	5/8"	2"	GALV A325 HHB W/ GALV F436 HARDENED FW & GALV A563-DH HHN						

SUFFIX ALL PIECE MARKS WITH "STRUCTURE DESIGNATION" THUS PIECE MARK XX BECOMES XXA

NOTES:

1. ALL ASTM A36 OR A992/A572 GRADE-50 STEEL UNLESS NOTED. ALL TUBING - ASTM A500 GRADE C. ALL STRUCTURAL PIPE - ASTM A53 GRADE-B.

2. ASTM A325 ERECTION BOLTS. USE THE SHORTEST BOLT THAT WILL ALLOW A F436 FLAT WASHER AND A A563 NUT.

3. ALL HOT DIP GALVANIZED AFTER FABRICATION (ASTM A123).

4. ALL HOLES **Ø11/16**" FOR **Ø5/8**" BOLTS UNLESS NOTED.


5. MINIMUM EDGE DISTANCE **7/8"** UNLESS NOTED.

6. PIECE MARK STAMPED INTO METAL WITH NOT LESS THAN 3/8" HIGH CHARACTERS BEFORE GALVANIZING.

7. ALL WELDING ELECTRODES SHALL BE E70XX.




					[
						REFERENCE DRAWINGS				
					DRAWING NUMBER	DESCRIPTION				
					SA100	STRUCTURE "A" COVER SHEET				
					SA200	STRUCTURE "A" ELEVATIONS				
					SA300	STRUCTURE "A" ASSEMBLIES & DETAILS BOM				
					SA301	STRUCTURE "A" ASSEMBLIES & DETAILS BOM				
						CUSTOMER CUSTOMER CUSTOMER CUSTOMER DOVER, DELEWARE SUBSTATION 69-12.47 KV SUBSTATION TITLE STR. A - ASSEMBLIES & DETAILS PROJECT NUMBER 47019 SCALE JLF JKG MAR SA301				
9/14/23	JRG	JKG	MAR	ISSUED FOR CONSTRUCTION		NTS AUBREY SILVEY ENTERPRISES, INC. SOCIATED				
9/23/21	KDC	JKG	MAR	ISSUE FOR BID		Engineer • Procure • Construct				
DATE	DRN	СК	APP	DESCR	IPTION	www.silvey.com/epc 770-537-1144 www.aseng.com 770-537-0033				

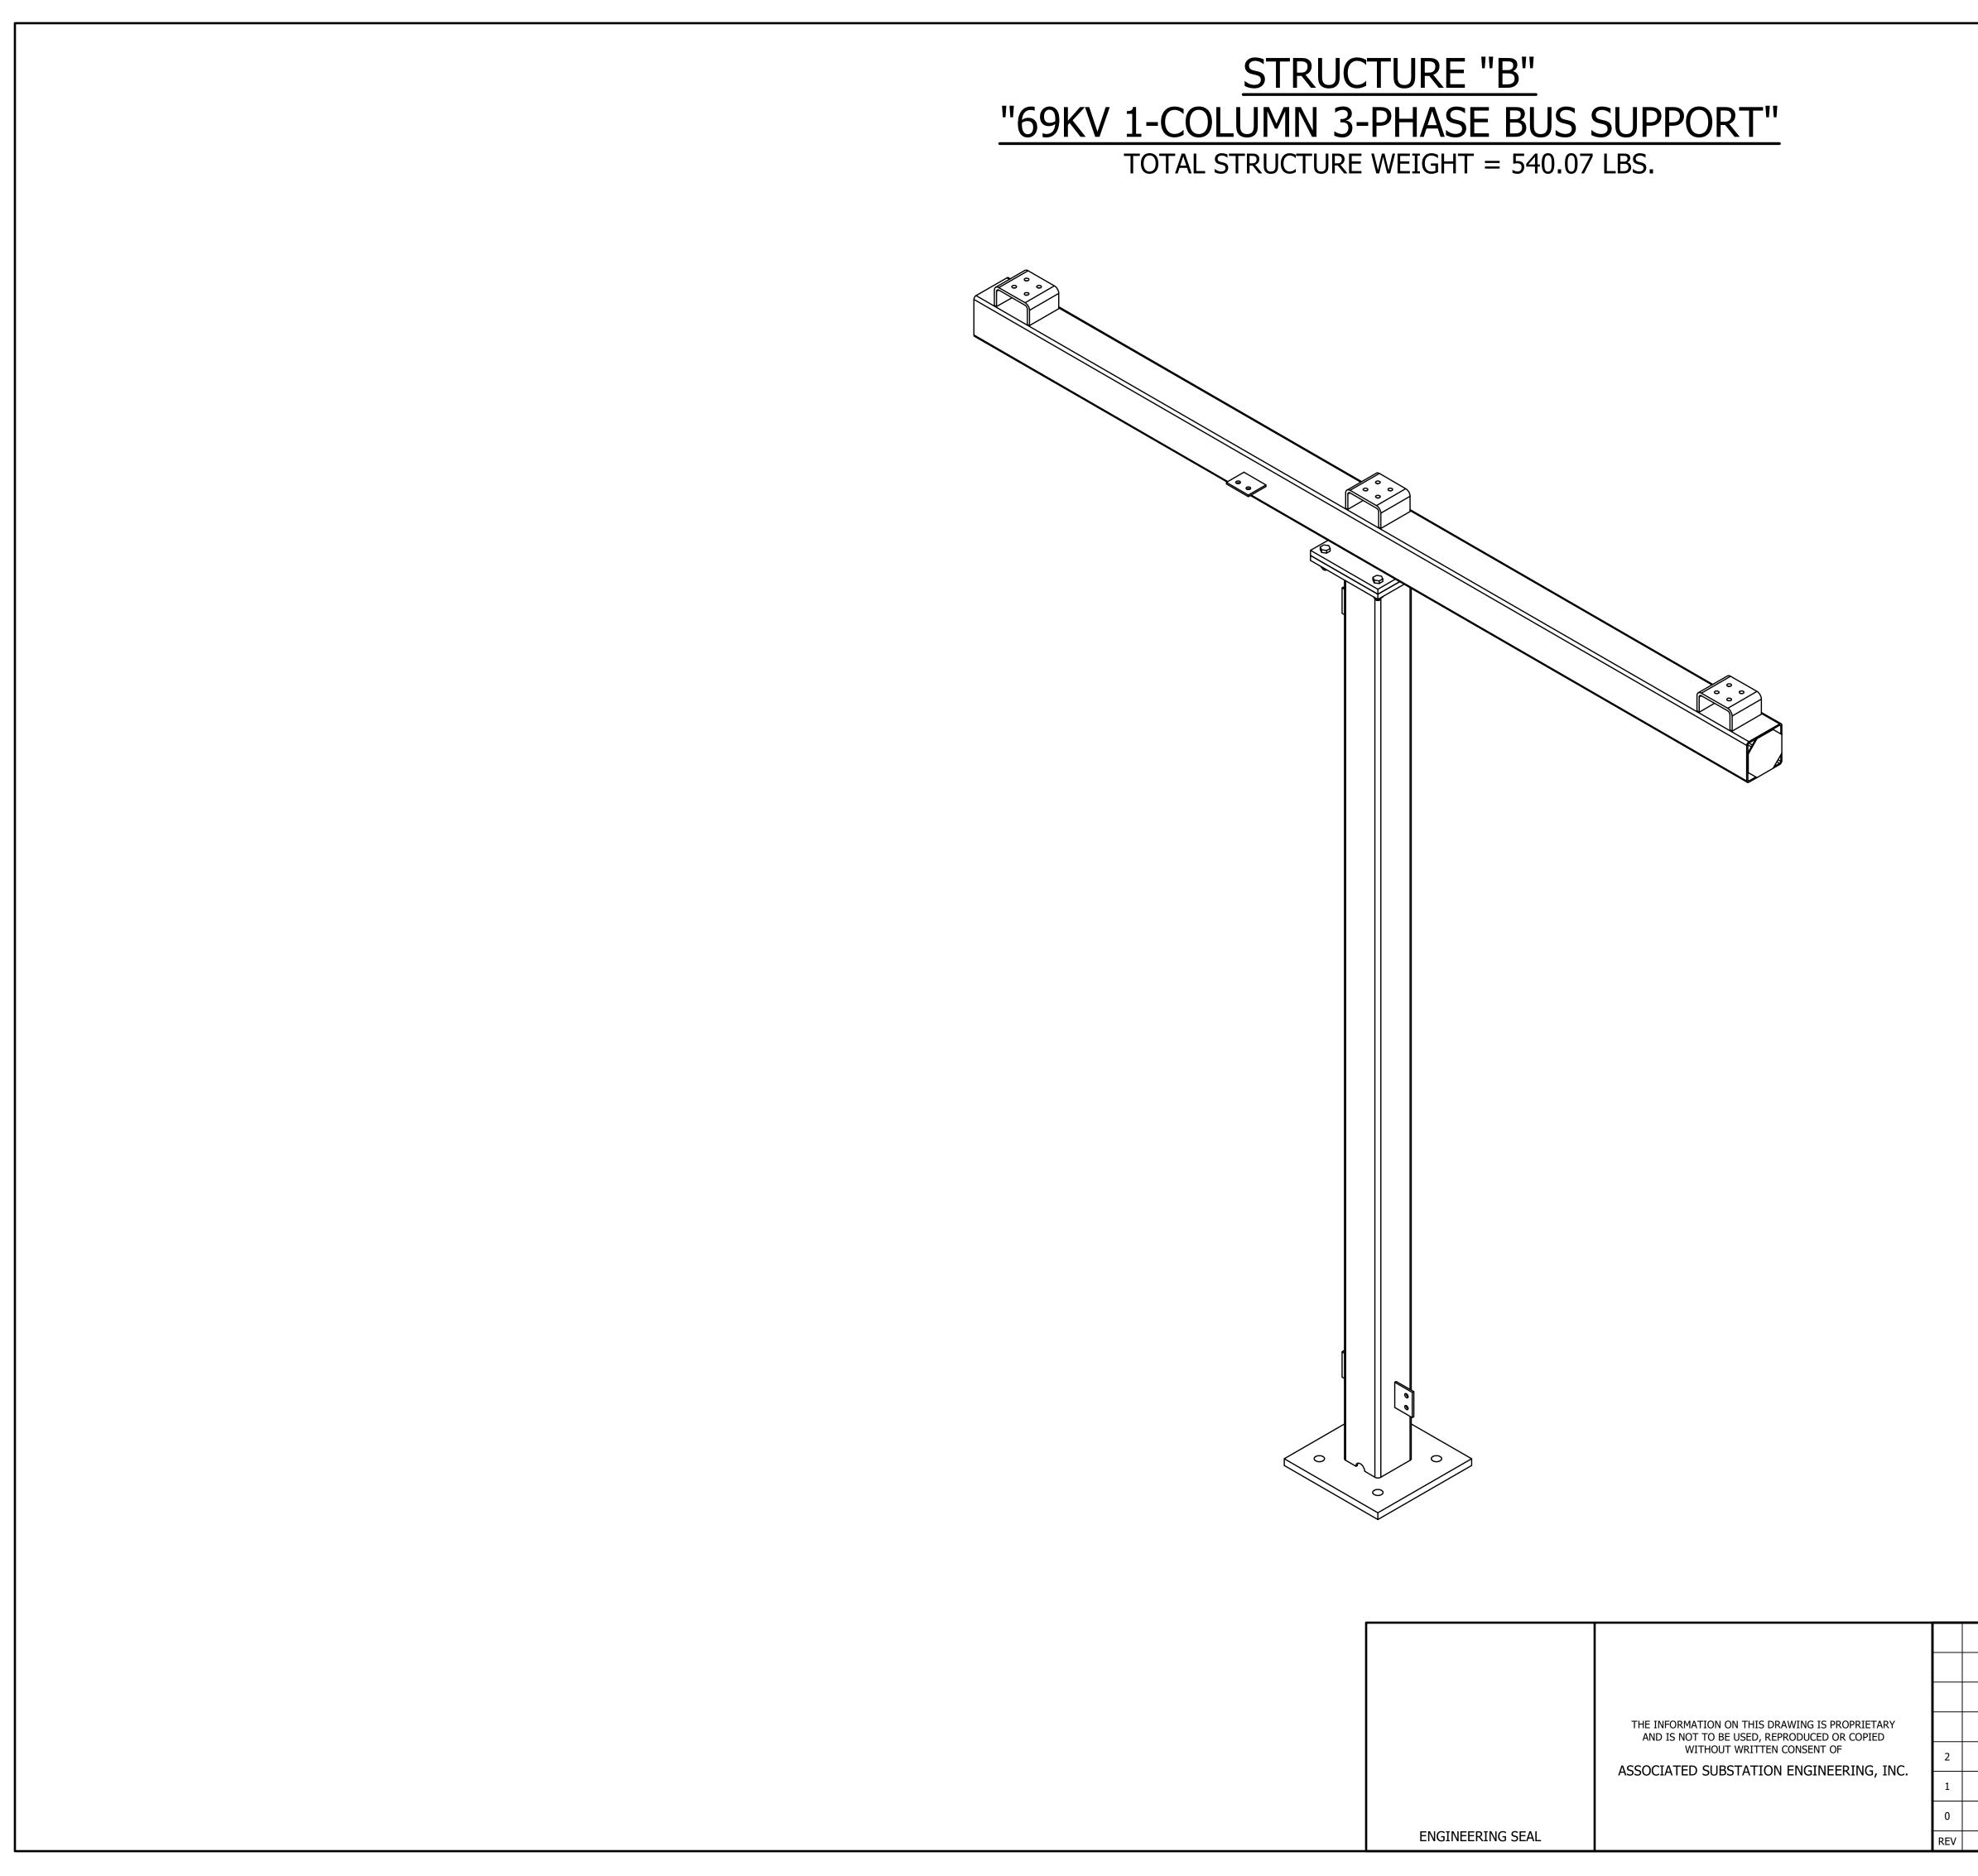


			ANCHOR BOLTS
QTY	DIA	LENGTH	DECSRIPTION
4	1"	2'-6"	GALV ANCHOR BOLTS WITH 2 HHN AND 2 FW (F1554 GRADE 55)

MAKE STRUCTURE "B" <u>"4" - TIMES</u>

						REFERENCE DRAWINGS
					DRAWING NUMBER	DESCRIPTION
					SB100	STRUCTURE "B" COVER SHEET
					SB200	STRUCTURE "B" ELEVATIONS
					SB300	STRUCTURE "B" ASSEMBLIES & DETAILS (BILL OF MATERIAL)
						CUSTOMER CITY OF DOVER DOVER, DELAWARE SUBSTATION 69-12.47KV SUBSTATION TITLE STD. P. COVED SHEET
						STR. B - COVER SHEET
9/14/23	JRG	JKG	MR	ISSUED FOR CONSTRUCTI	ON	PROJECT NUMBER 47019 SCALE JLF CVC MAR SB100
9/23/21	JLF	JKG	MR	ISSUE FOR BID		NTS AUBREY SILVEY ENTERPRISES, INC. AUBREY SILVEY ENTERPRISES, INC.
7/28/21	JLF	CVC	MR	ISSUED FOR APPROVAL		Engineer • Procure • Construct
DATE	DRN	СК	APP	DESCRIF	PTION	www.silvey.com/epc 770-537-1144 www.aseng.com 770-537-0033

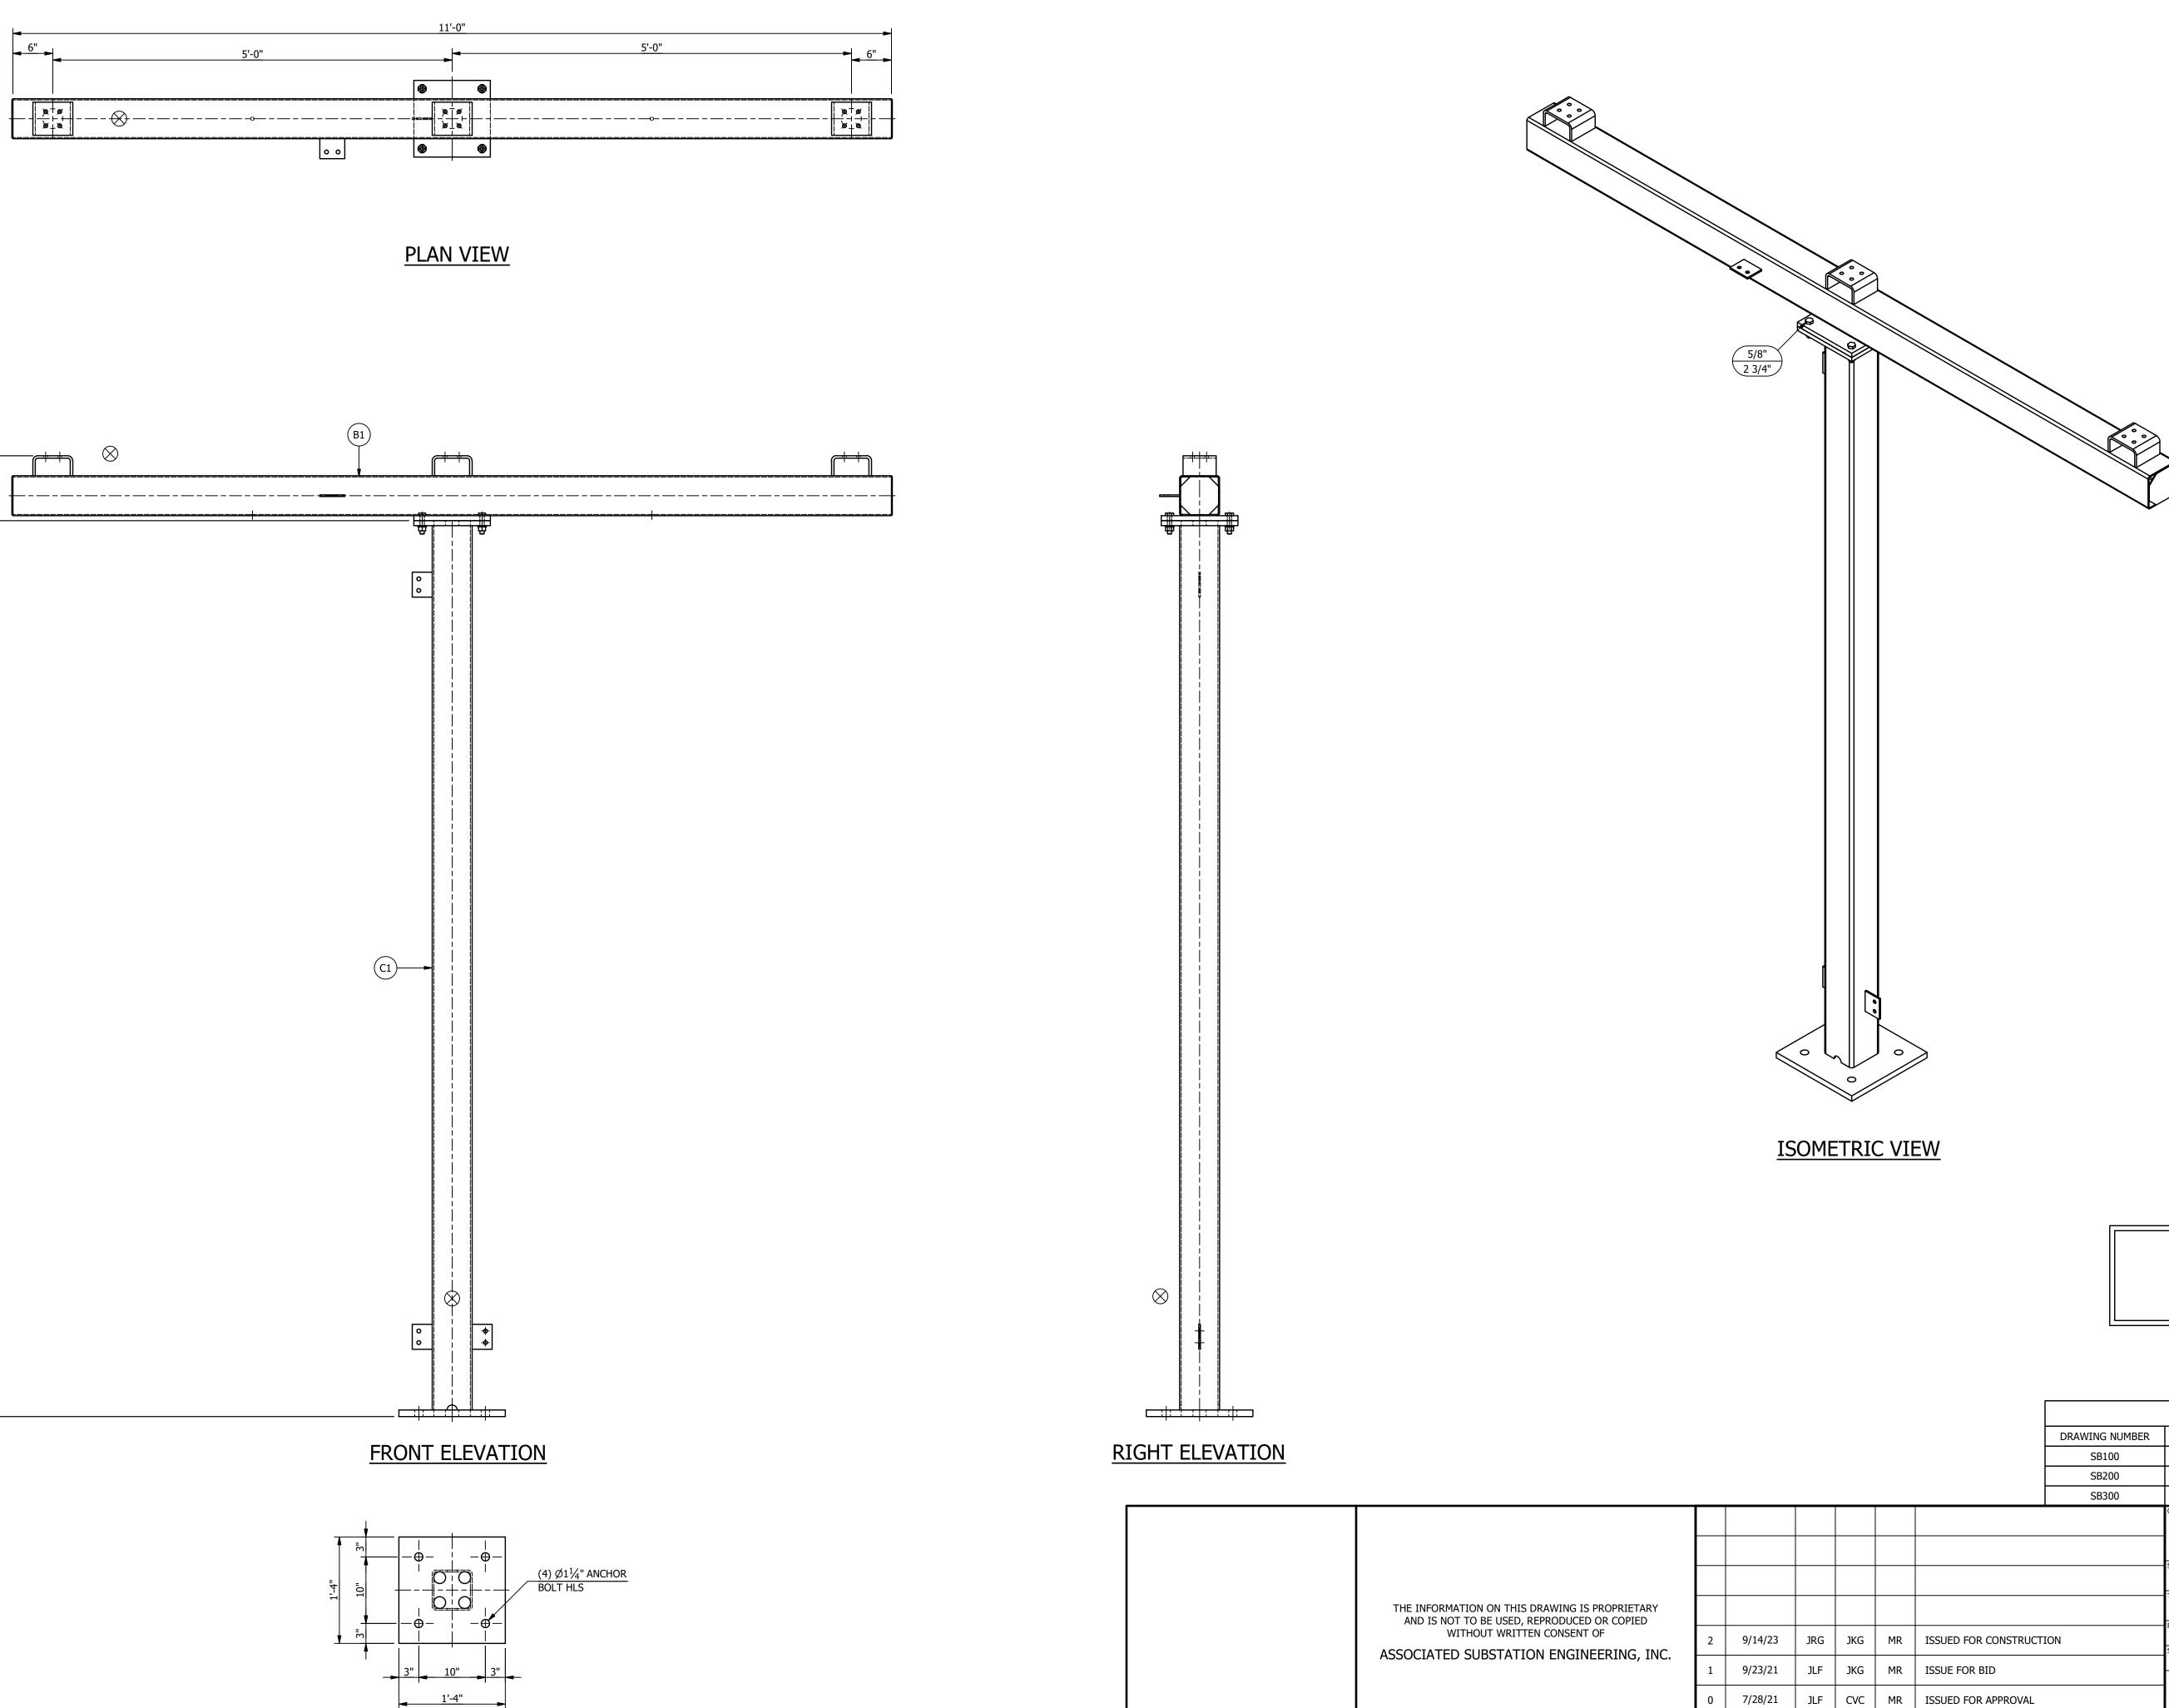

ENGINEERING SEAL

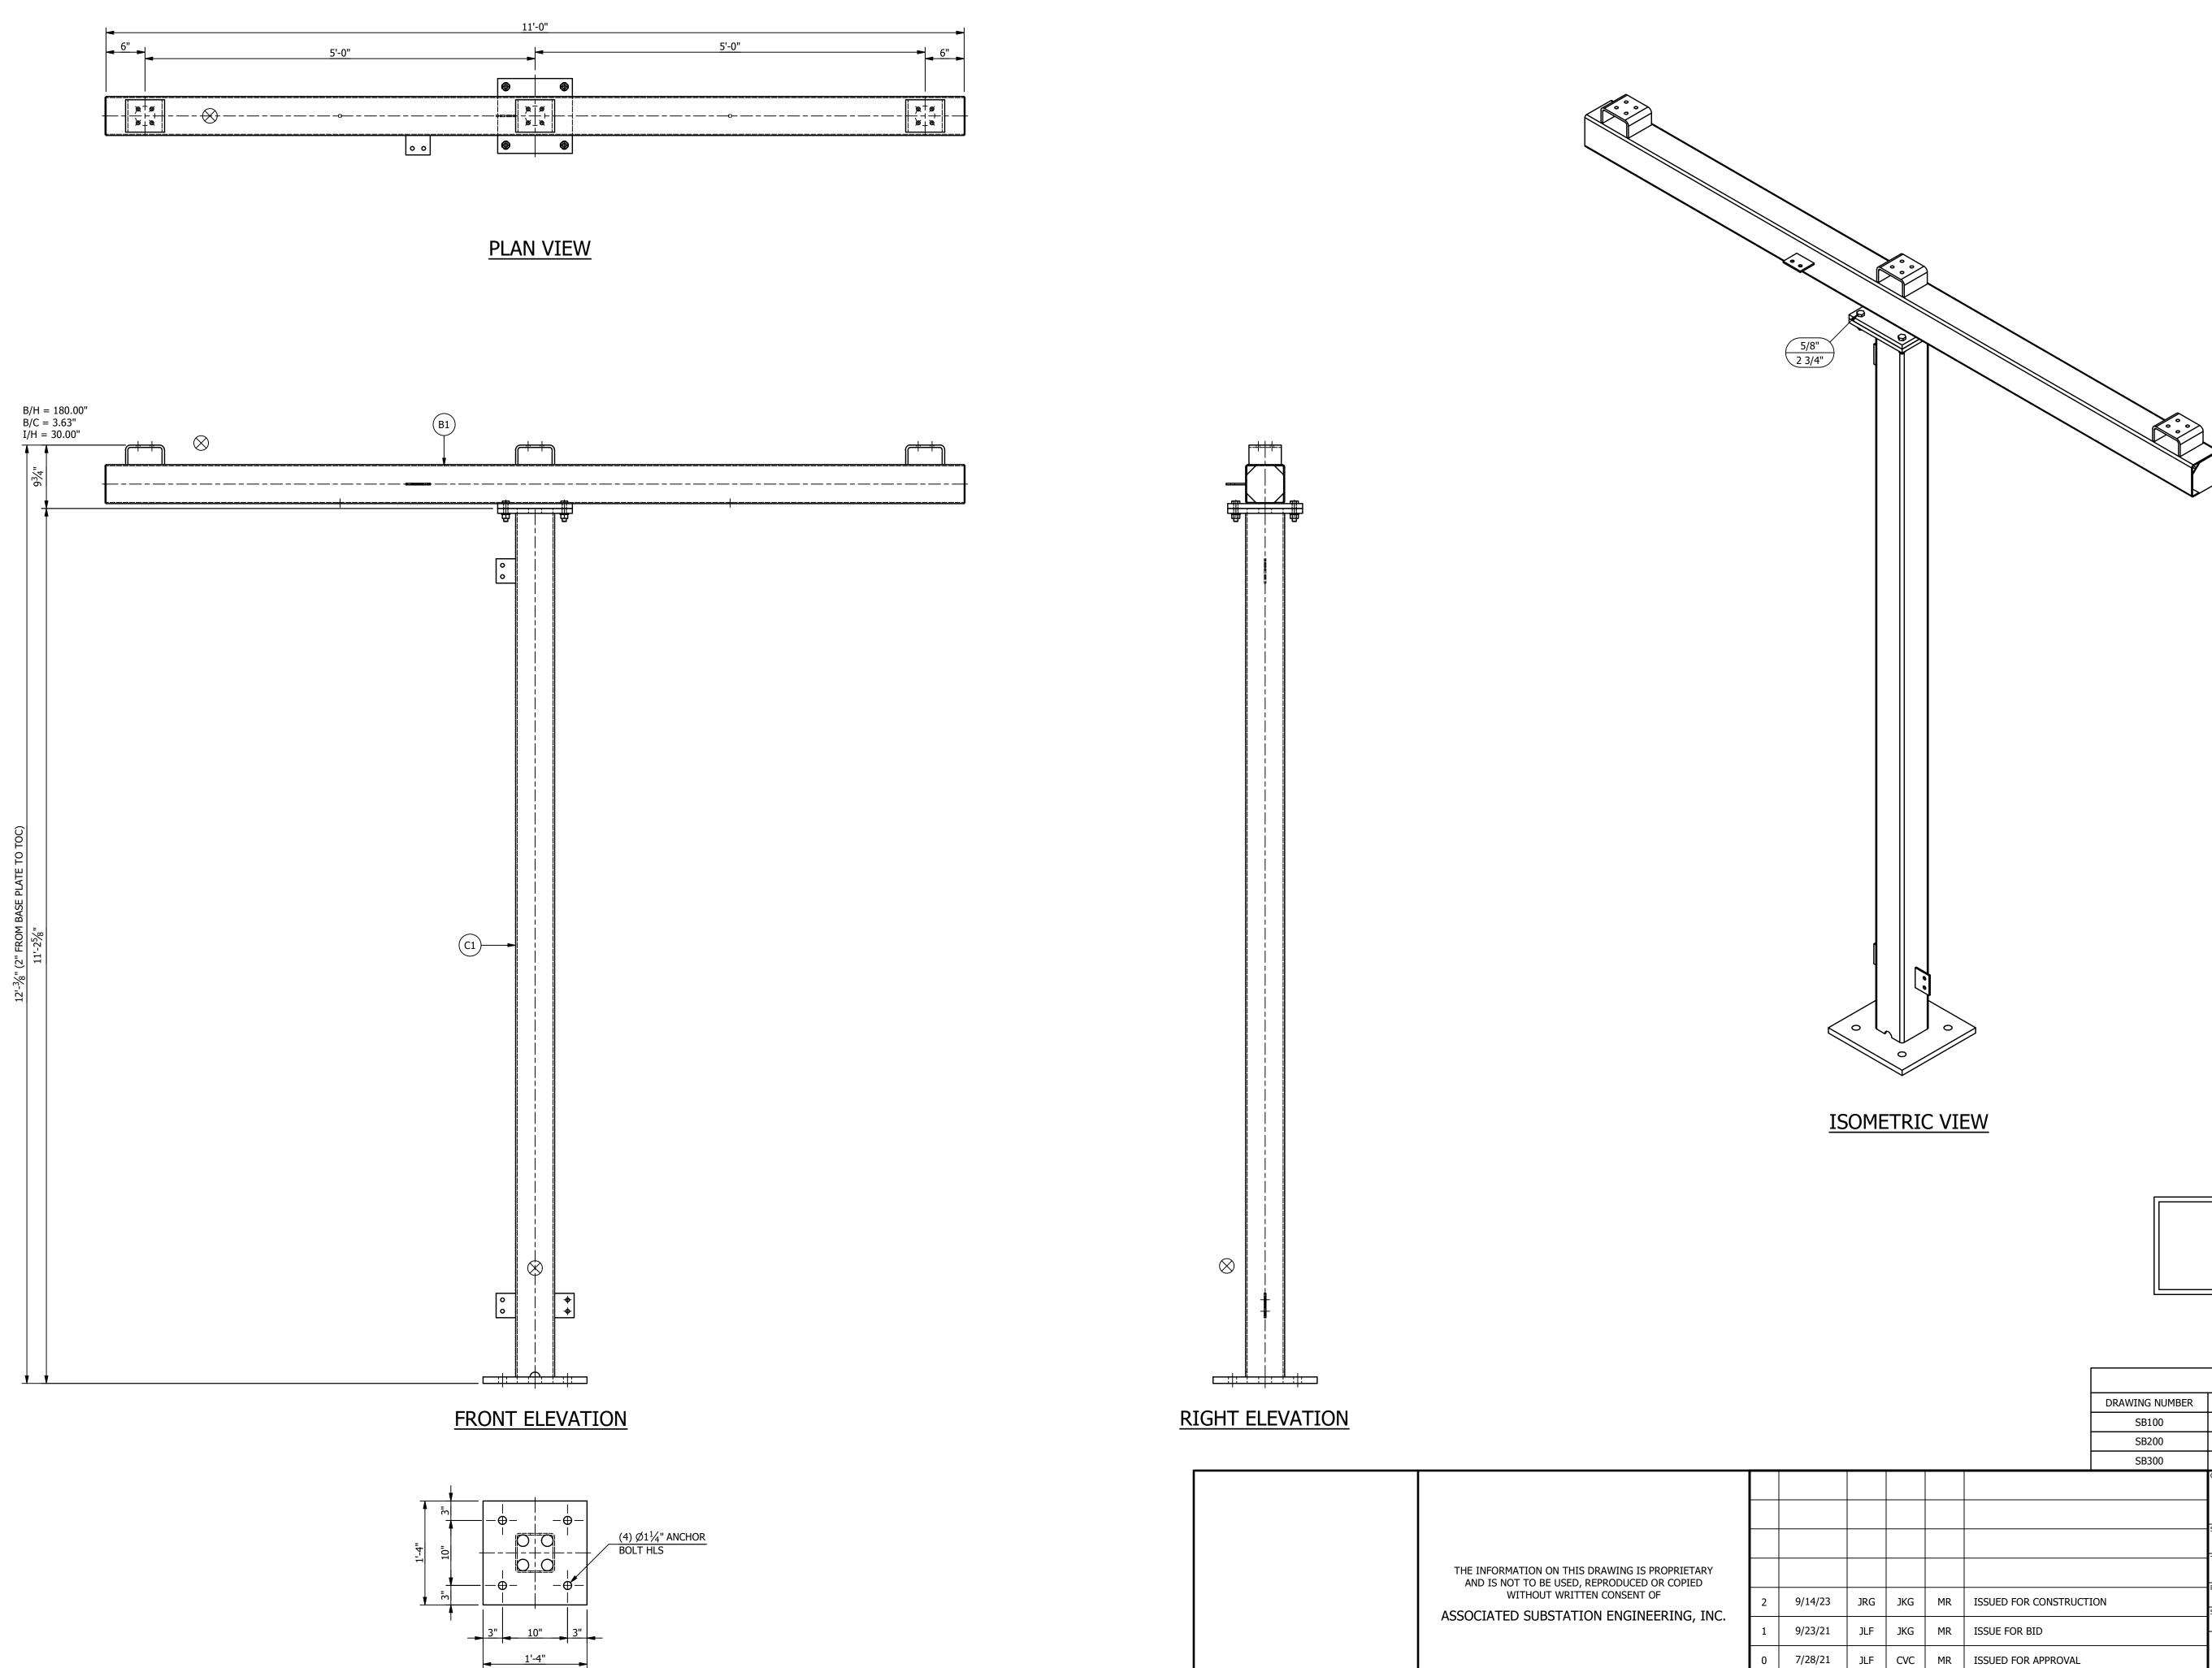

ASSEMBLIES

DESCRIPTION

B1 1 BEAM "B1" C1 1 COLUMN "C1"

NOTES:

MARK QTY

1. ALL ASTM A36 OR A992/A572 GRADE-50 STEEL UNLESS NOTED. ALL TUBING - ASTM A500 GRADE B. ALL STRUCTURAL PIPE - ASTM A53 GRADE-B.

2. ASTM A325 ERECTION BOLTS. USE THE SHORTEST BOLT THAT WILL ALLOW A F436 FLAT WASHER AND A A563 NUT.

3. ALL HOT DIP GALVANIZED AFTER FABRICATION (ASTM A123).

4. ALL HOLES <u>Ø11/16"</u> FOR <u>Ø5/8"</u> BOLTS UNLESS NOTED.


5. MINIMUM EDGE DISTANCE **7/8**" UNLESS NOTED.


6. PIECE MARK STAMPED INTO METAL WITH NOT LESS THAN 3/8" HIGH CHARACTERS BEFORE GALVANIZING.


7. ALL WELDING ELECTRODES SHALL BE E70XX.


MAKE STRUCTURE "B'	I
<u>"4" - TIMES</u>	_


							REFERENCE DRAWINGS
						DRAWING NUMBER	DESCRIPTION
						SB100	STRUCTURE "B" COVER SHEET
						SB200	STRUCTURE "B" ELEVATIONS
						SB300	STRUCTURE "B" ASSEMBLIES & DETAILS (BILL OF MATERIAL)
							CUSTOMER CITY OF DOVER DOVER, DELAWARE SUBSTATION 69-12.47KV SUBSTATION TITLE STR. B - ELEVATIONS
2	9/14/23	JRG	JKG	MR	ISSUED FOR CONSTRUCT	ION	PROJECT NUMBER DRAWN CHECKED APPROVED DRAWING NUMBER 47019 JLF CVC MAR SB200
1	9/23/21	JLF	JKG	MR	ISSUE FOR BID		AUBREY SILVEY ENTERPRISES, INC. SSOCIATED
0	7/28/21	JLF	CVC	MR	ISSUED FOR APPROVAL		Engineer • Procure • Construct
REV	DATE	DRN	CK	APP	DESCRIF	PTION	www.silvey.com/epc 770-537-1144

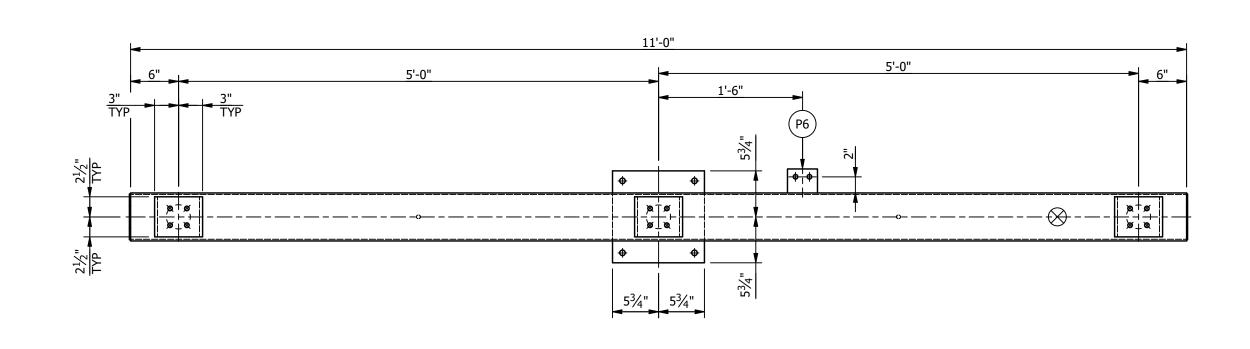


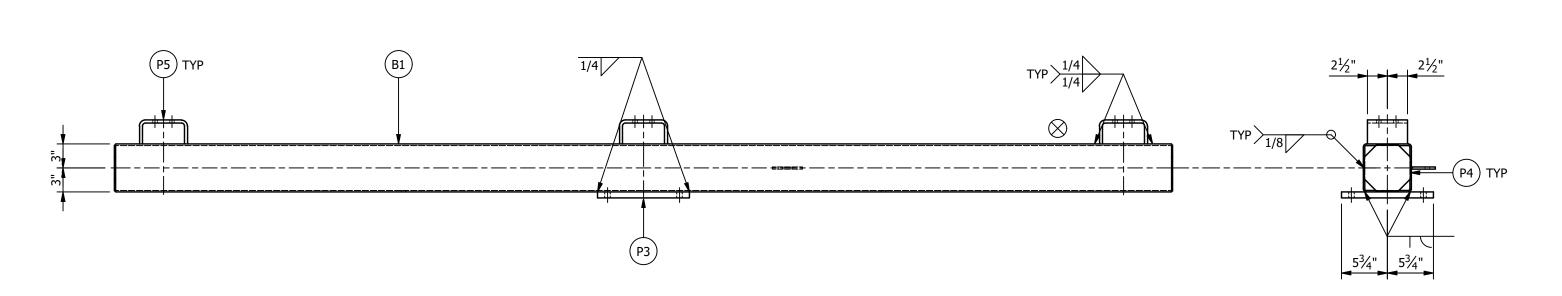

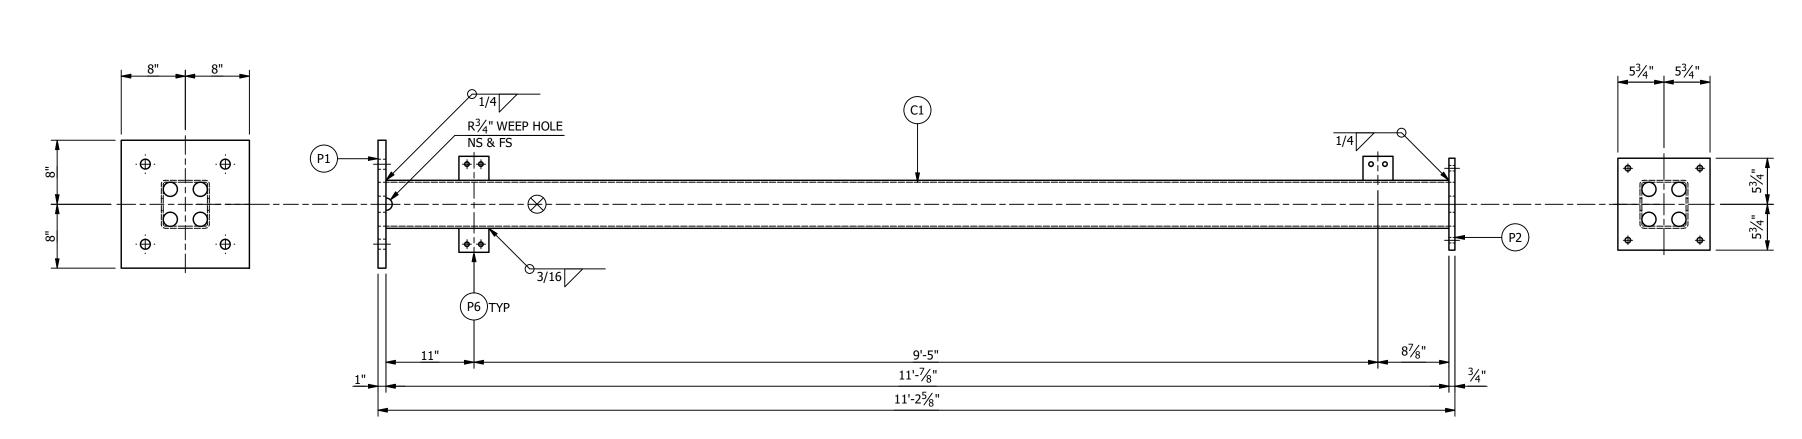


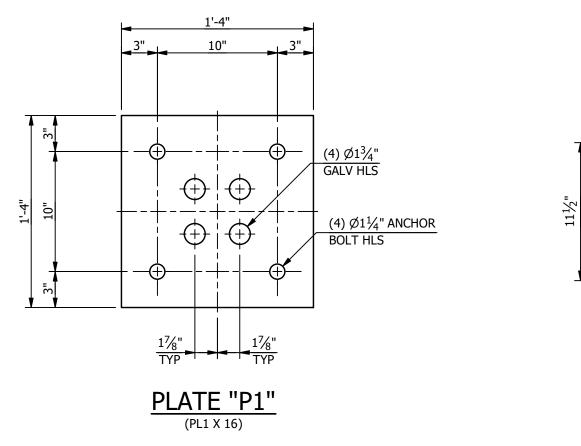


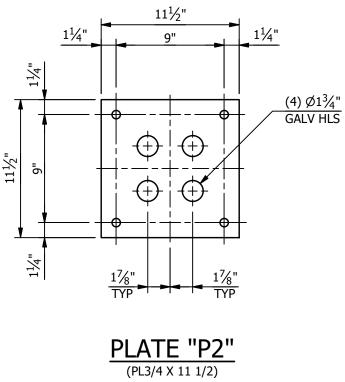


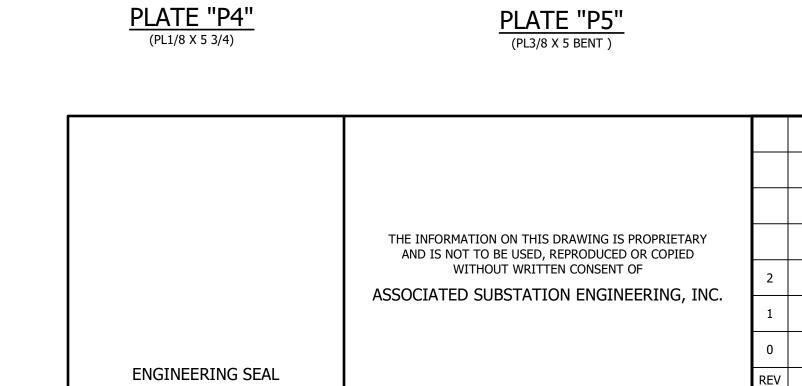



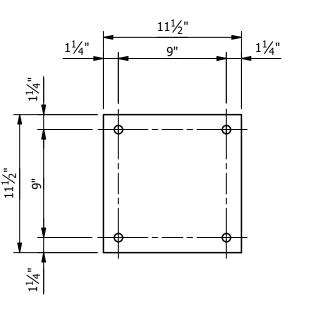

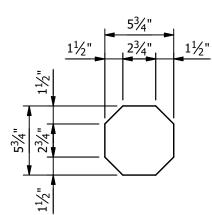

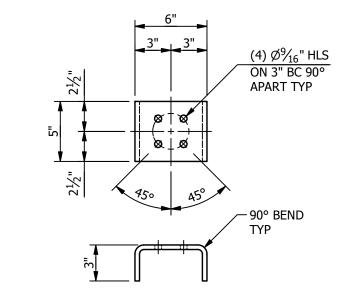

COLUMN "C1" ASSEMBLY

BEAM "B1" ASSEMBLY

			***E	BILL OF MATE	ERIAL*	**	
MARK QTY				DESCRIPTION		LENGTH	TOTAL WGT
B1	1	HSS6 X	6 X 3/16			11'-0"	159.79
C1	1	HSS6 X	6 X 1/4			11'-7/8"	210.59
P1	1	PL1 X 1	.6			1'-4"	72.59
P2	1	PL3/4 X	(11 1/2		0'-11 1/2"	28.13	
Р3	1	PL3/4 X	(11 1/2			0'-11 1/2"	28.13
P4	2	PL1/8 X	(5 3/4			0'-5 3/4"	2.34
P5	3	PL3/8 X	5 BENT			0'-10 11/16"	17.05
P6	4	PL1/4 X	(3			0'-3 3/4"	3.19
						TOTAL BLK WGT TOTAL GALV WGT	
		(STRUC	TURE BOLT A	SSEME	BLIES	
QTY	,	DIA	LENGTH		DESCRIP	TION	

	STRUCTURE DULT ASSEMIDLIES							
QTY	DIA	LENGTH	DESCRIPTION					
5	5/8"	2 3/4"	GALV A325 HHB W/ GALV F436 HARDENED FW & GALV A563-DH HHN					

SUFFIX ALL PIECE MARKS WITH "STRUCTURE DESIGNATION" THUS PIECE MARK XX BECOMES XXB

NOTES:

1. ALL ASTM A36 OR A992/A572 GRADE-50 STEEL UNLESS NOTED. ALL TUBING - ASTM A500 GRADE B. ALL STRUCTURAL PIPE - ASTM A53 GRADE-B.

2. ASTM A325 ERECTION BOLTS. USE THE SHORTEST BOLT THAT WILL ALLOW A F436 FLAT WASHER AND A A563 NUT.


3. ALL HOT DIP GALVANIZED AFTER FABRICATION (ASTM A123).

4. ALL HOLES <u>Ø11/16"</u> FOR <u>Ø5/8"</u> BOLTS UNLESS NOTED.


5. MINIMUM EDGE DISTANCE **7/8**" UNLESS NOTED.


6. PIECE MARK STAMPED INTO METAL WITH NOT LESS THAN 3/8" HIGH CHARACTERS BEFORE GALVANIZING.

7. ALL WELDING ELECTRODES SHALL BE E70XX.

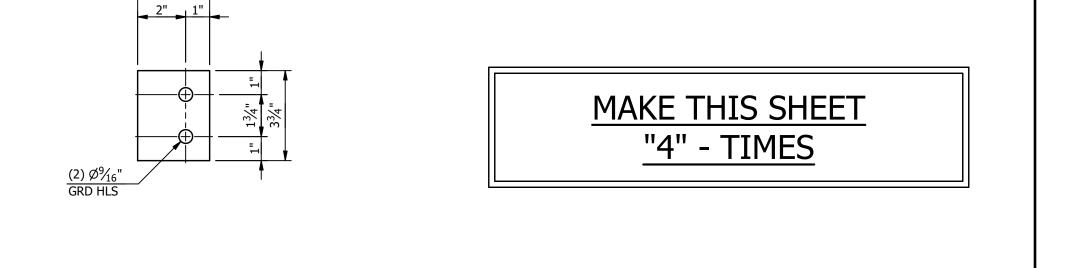

	DI Δ	TE "	D6"		REFERENCE DRAWINGS				
	-	PL1/4 X 3			DRAWING NUMBER	DESCRIPTION			
	,	, –	,		SB100	STRUCTURE "B" COVER SHEET			
					SB200	STRUCTURE "B" ELEVATIONS			
					SB300	STRUCTURE "B" ASSEMBLIES & DETAILS (BILL OF MATERIAL)			
						CUSTOMER CITY OF DOVER DOVER, DELAWARE SUBSTATION 69-12.47KV SUBSTATION TITLE STR. B - ASSEMBLIES & DETAILS PROJECT NUMBER DRAWN CHECKED APPROVED DRAWING NUMBER			
9/14/23	JRG	JKG	MR	ISSUED FOR CONSTRUCT	ION	SCALE JLF CVC MAR SB300			
9/23/21	JLF	JKG	MR	ISSUE FOR BID		AUBREY SILVEY ENTERPRISES, INC.			
7/28/21	JLF	CVC	MR	ISSUED FOR APPROVAL		Engineer • Procure • Construct			
DATE	DRN	CK	APP	DESCRIF	PTION	www.silvey.com/epc 770-537-1144 www.aseng.com 770-537-0033			

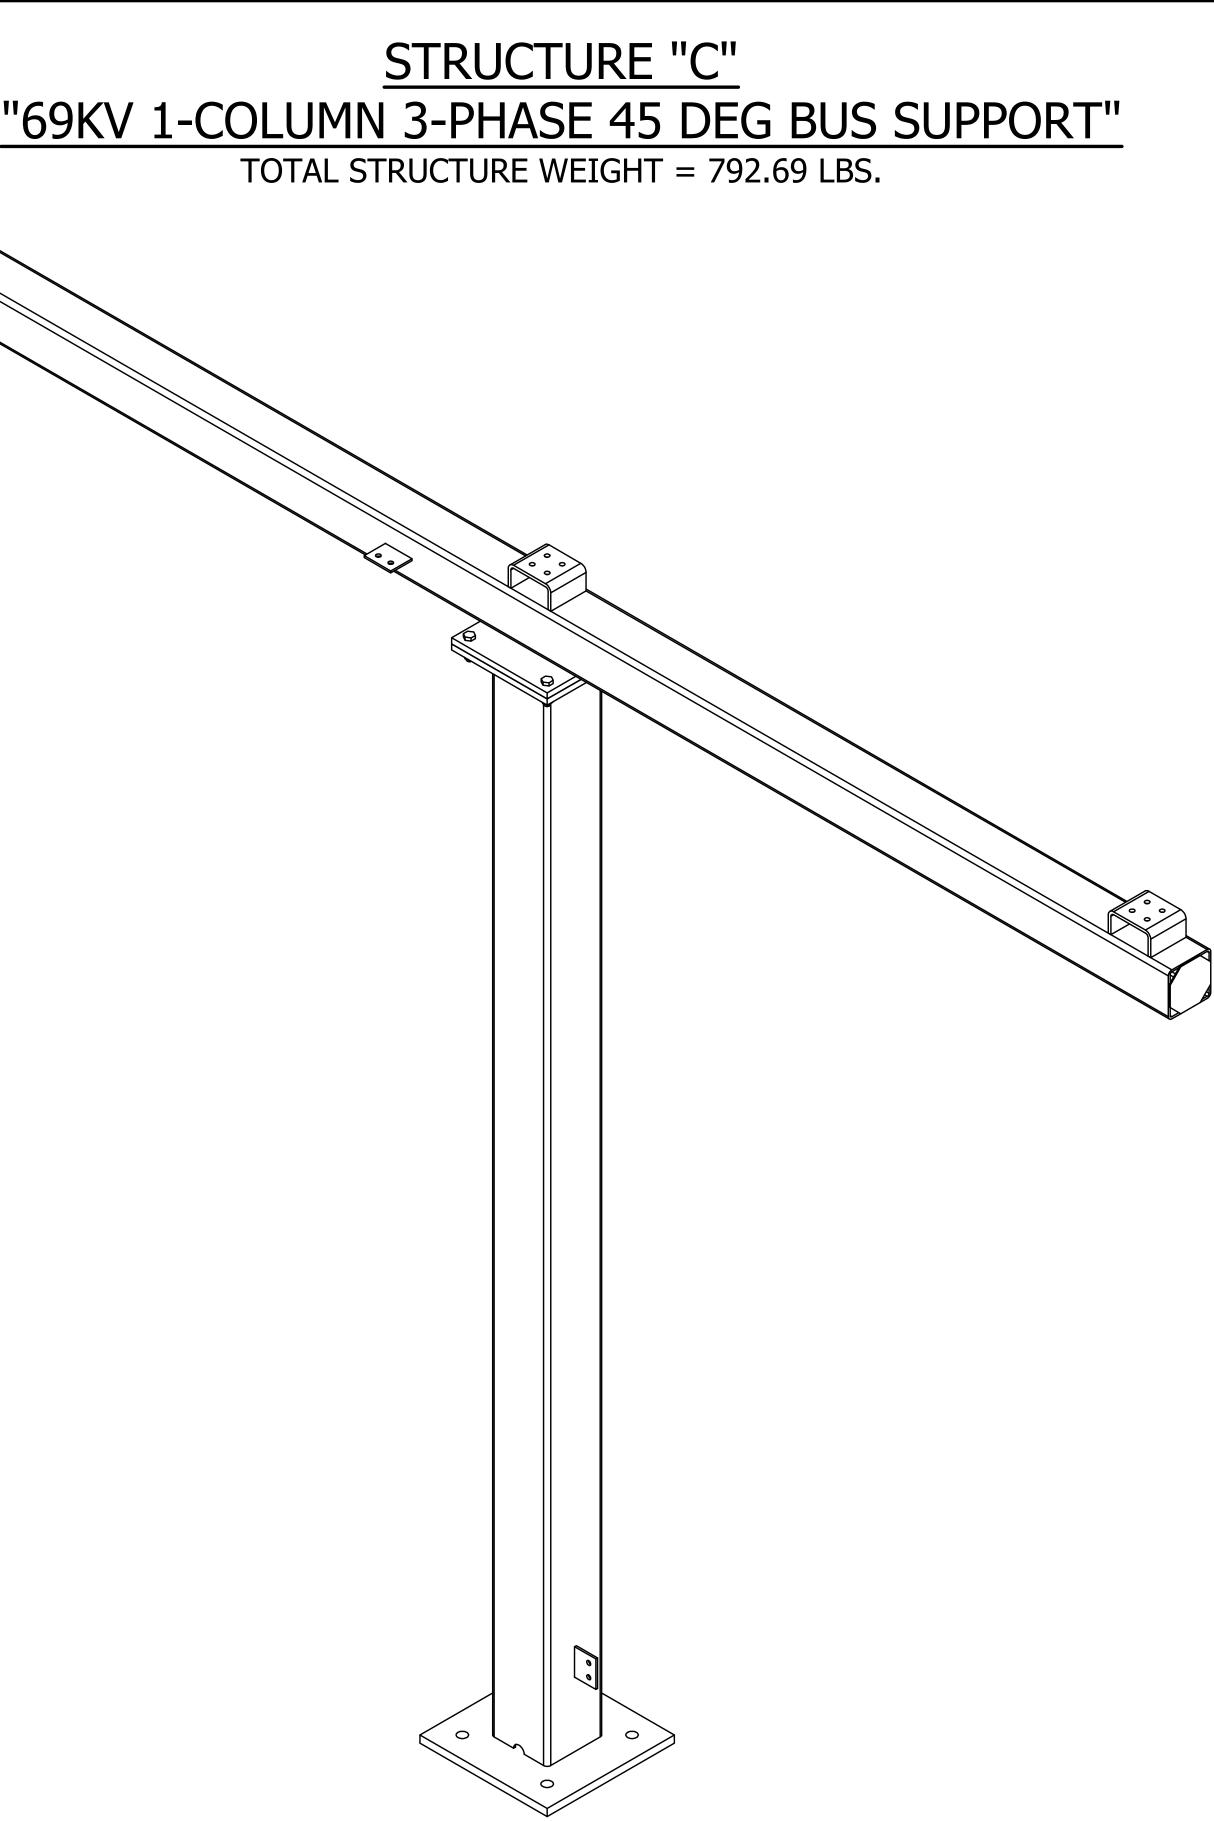

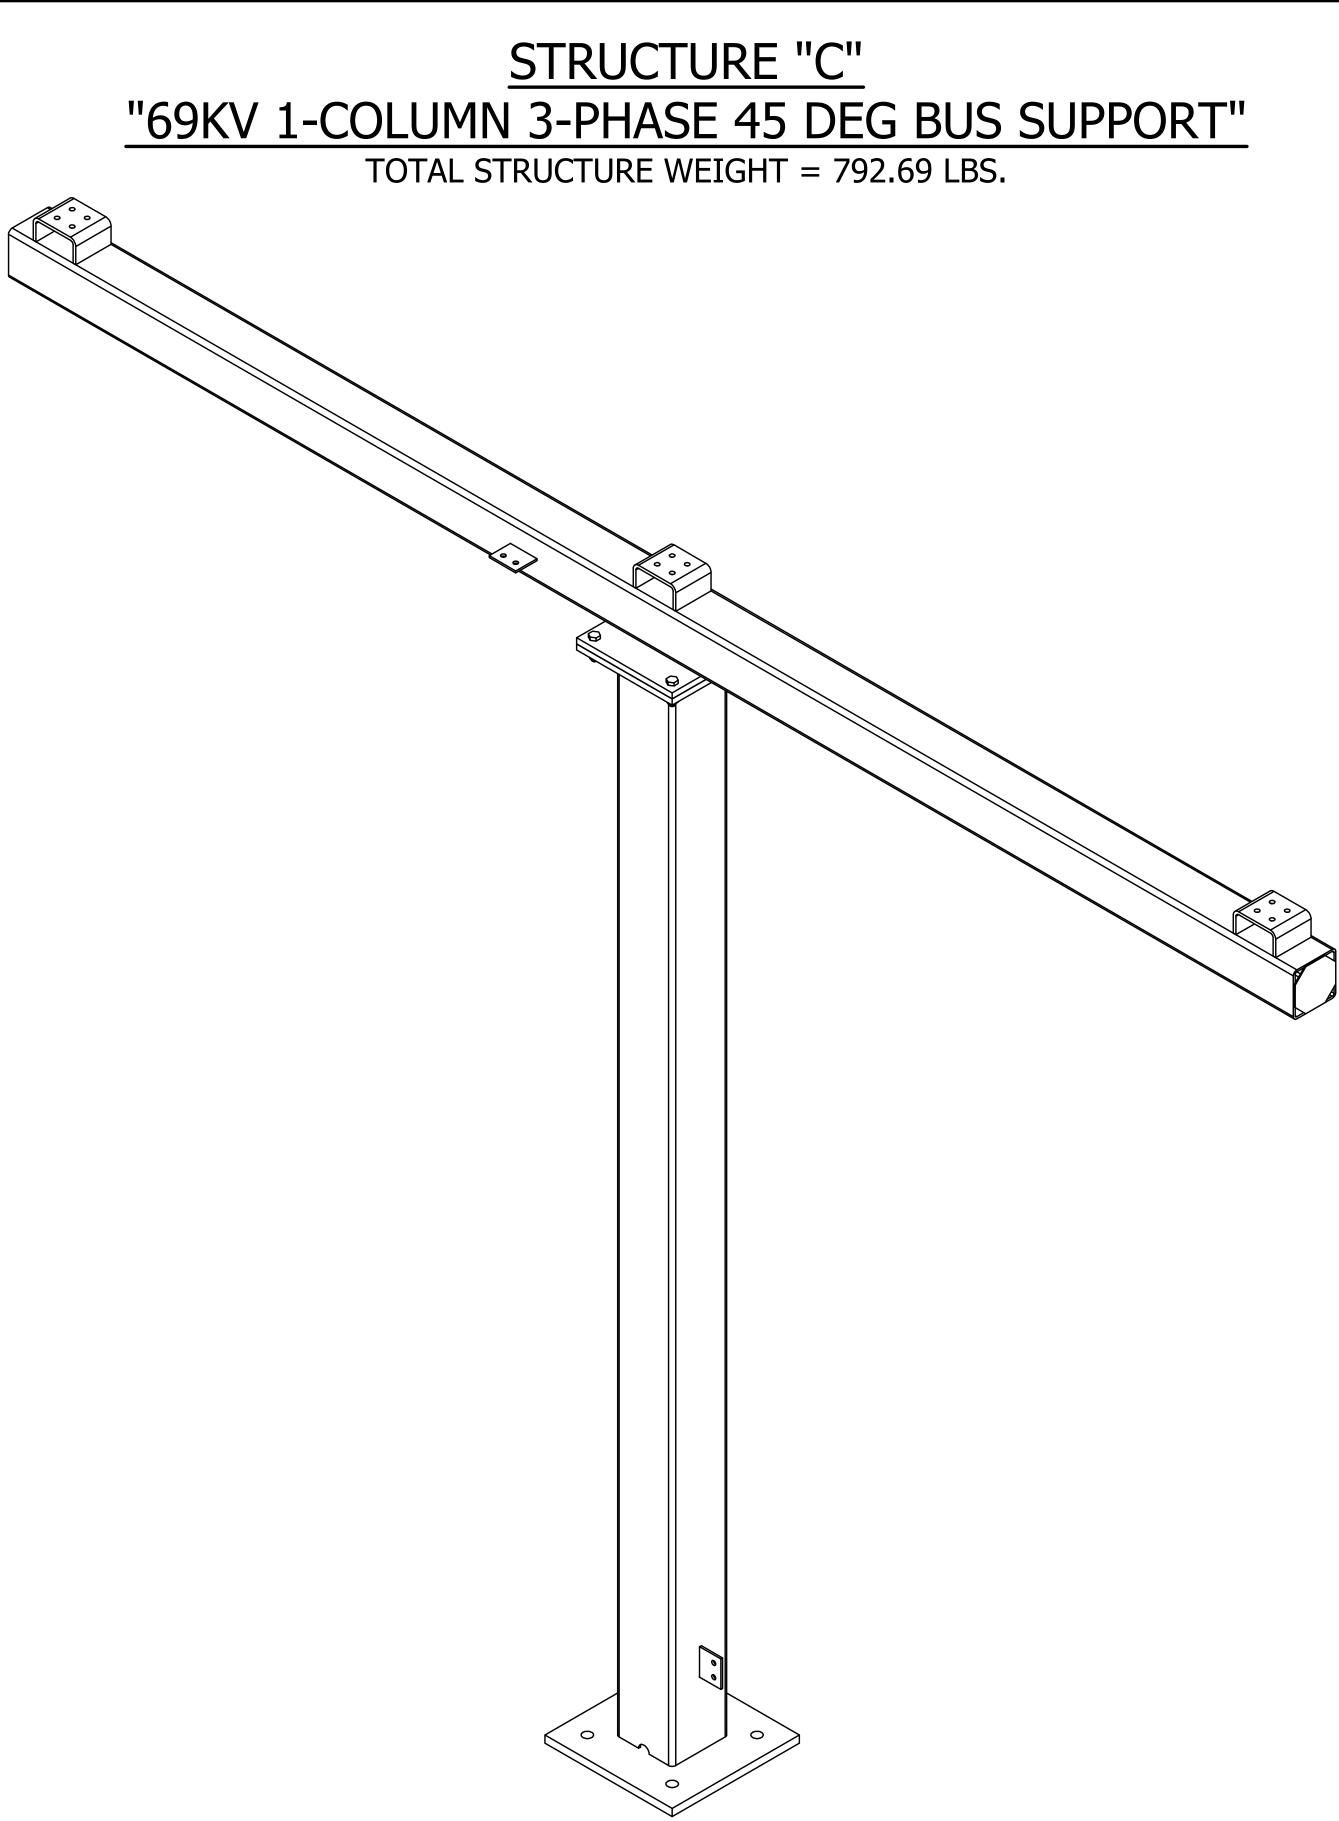


	THE INFORMATION ON THIS DRAWING IS PROPRIETARY AND IS NOT TO BE USED, REPRODUCED OR COPIED		
	WITHOUT WRITTEN CONSENT OF	2	
	ASSOCIATED SUBSTATION ENGINEERING, INC.		
		1	
		0	
ENGINEERING SEAL		RFV	

			ANCHOR BOLTS
QTY	DIA	LENGTH	DECSRIPTION
4	1"	2'-6"	GALV ANCHOR BOLTS WITH 2 HHN AND 2 FW (F1554 GRADE 55)

MAKE STRUCTURE "C" <u>"8" - TIMES</u>

						REFERENCE DRAWINGS
					DRAWING NUMBER	DESCRIPTION
					SC100	STRUCTURE "C" COVER SHEET
					SC200	STRUCTURE "C" ELEVATIONS
					SC300	STRUCTURE "C" ASSEMBLIES & DETAILS (BILL OF MATERIAL)
						CUSTOMER CITY OF DOVER DOVER, DELAWARE
						69-12.47KV SUBSTATION
						STR. C - COVER SHEET
9/14/23	JRG	JKG	MR	ISSUED FOR CONSTRUCT	ION	PROJECT NUMBER 47019 SCALE JLF CVC MAR SC100
9/23/21	KDC	JKG	MR	ISSUE FOR BID		AUBREY SILVEY ENTERPRISES, INC.
7/28/21	JLF	CVC	MR	ISSUED FOR APPROVAL		Engineer • Procure • Construct
DATE	DRN	CK	APP	DESCRIF	PTION	www.silvey.com/epc 770-537-1144

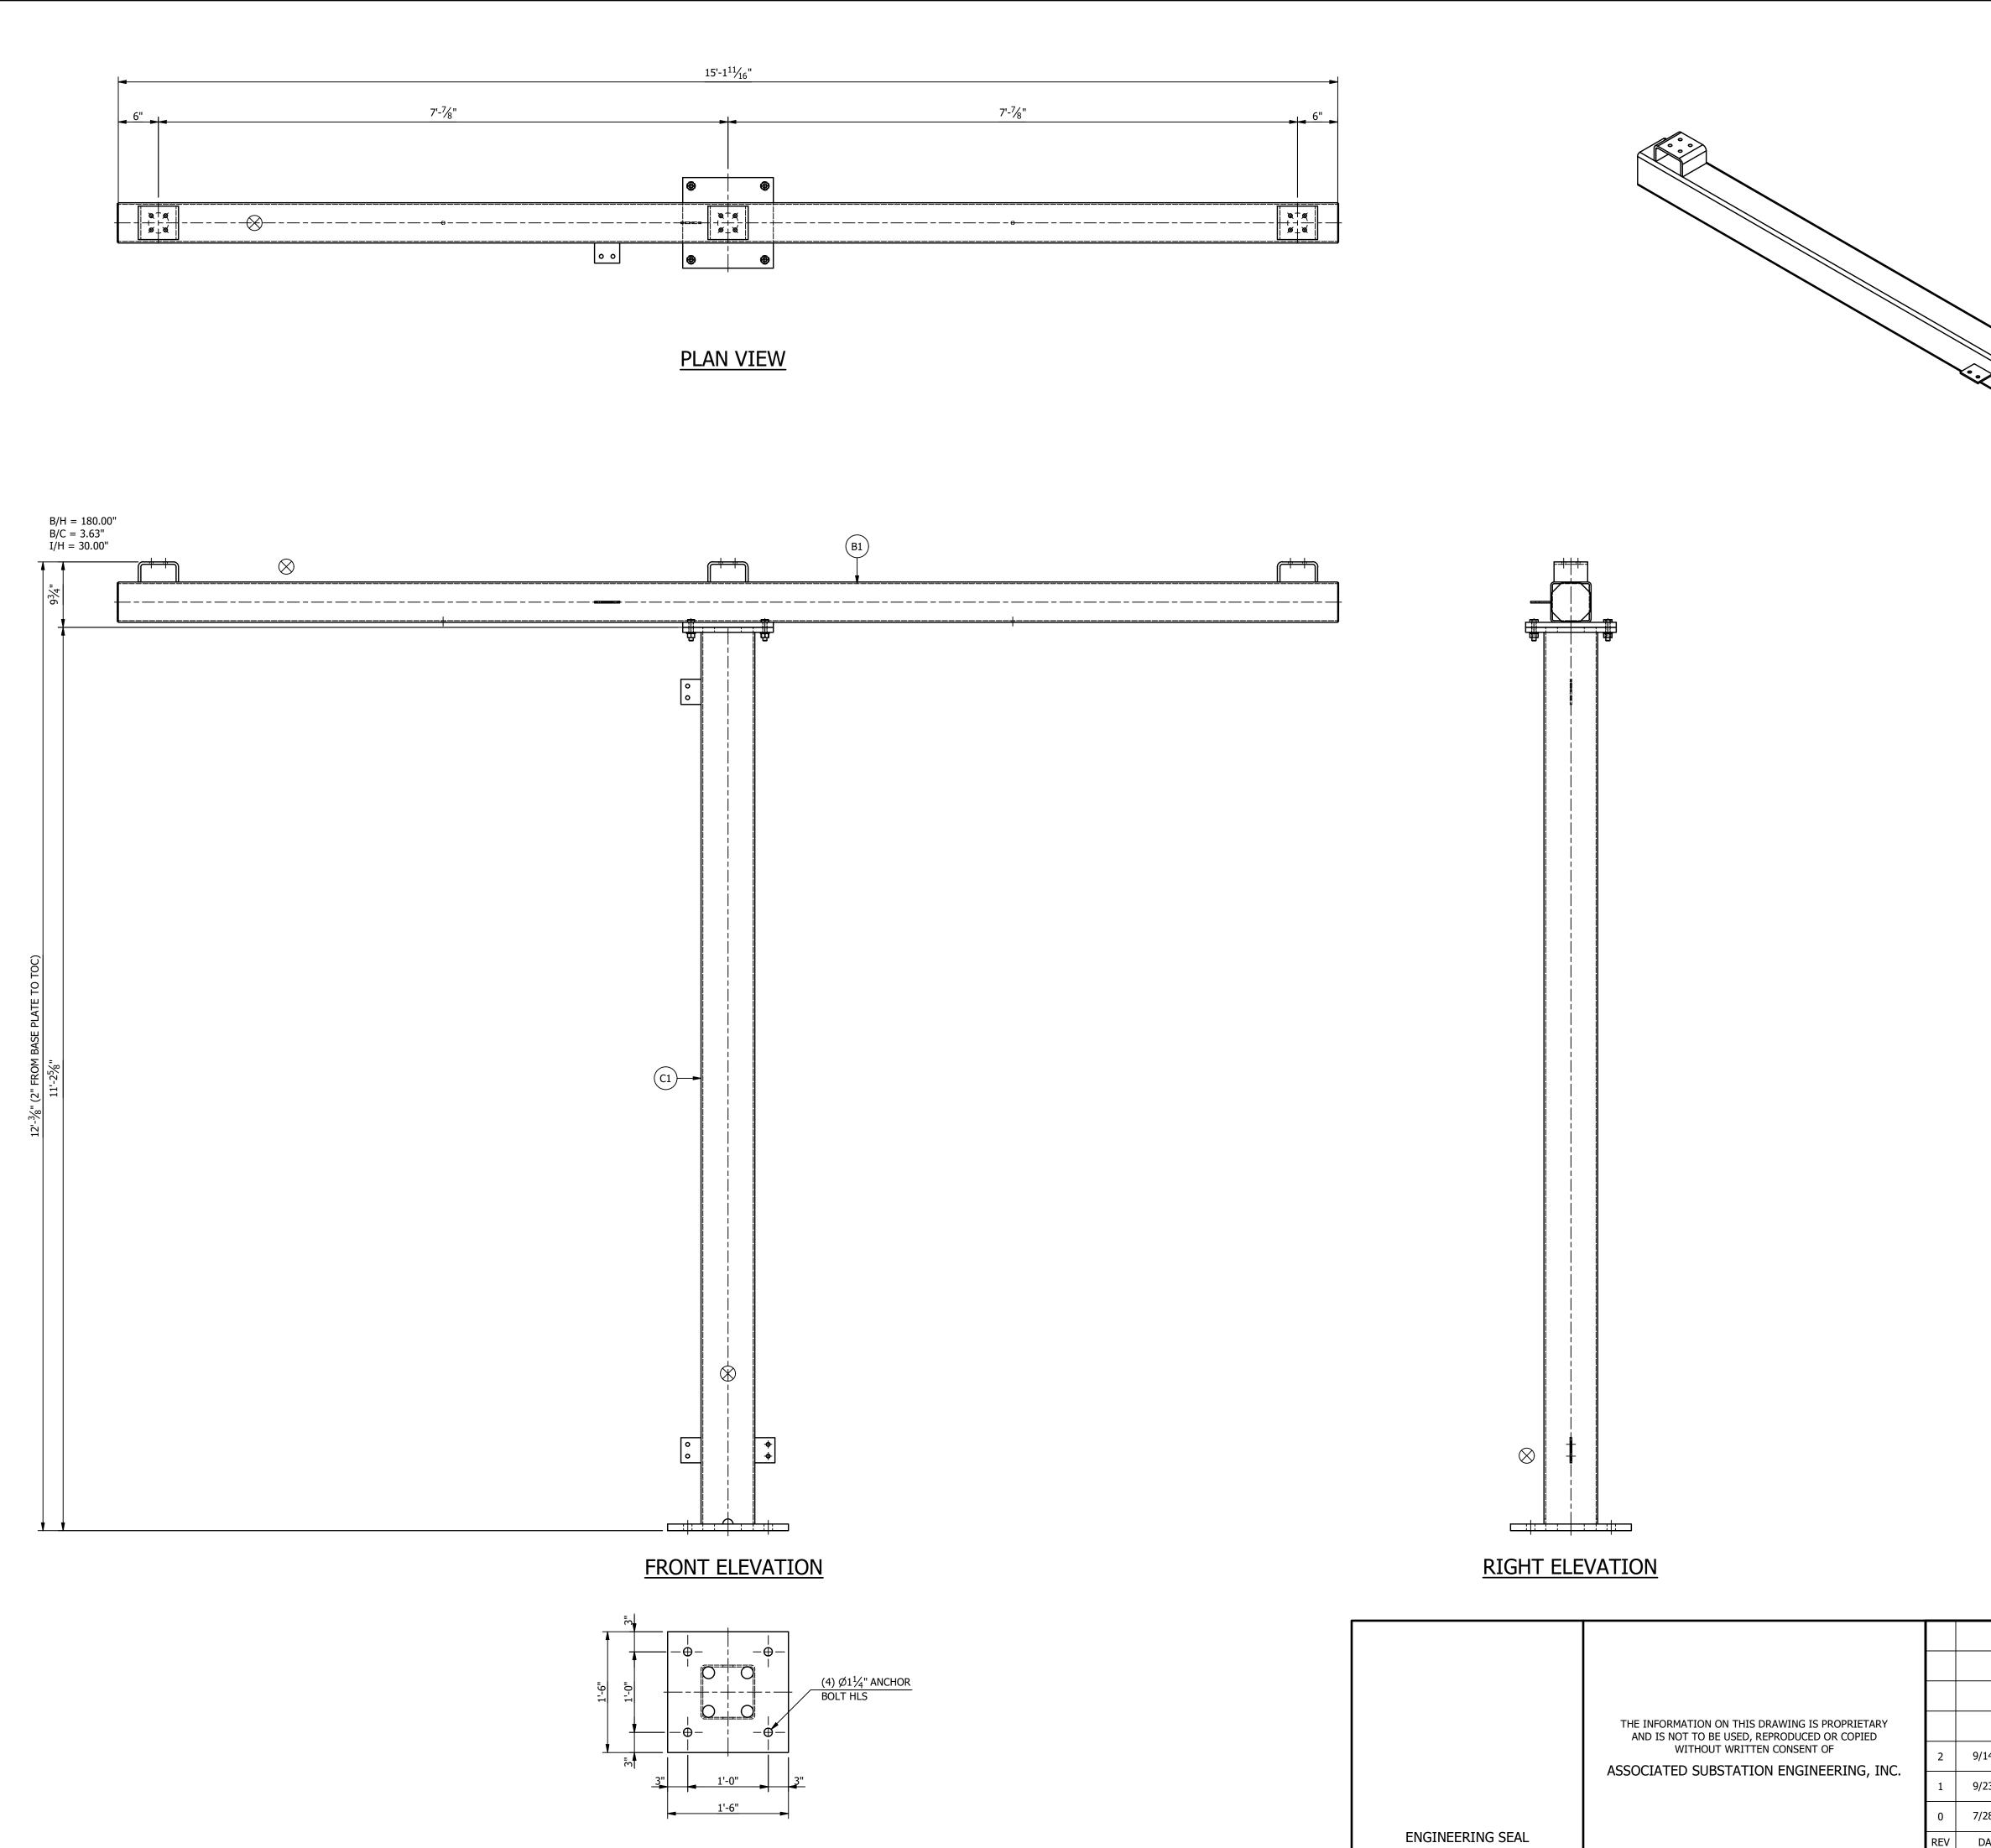

ASSEMBLIES

DESCRIPTION

 B1
 1
 BEAM "B1"

 C1
 1
 COLUMN "C1"

NOTES:

MARK QTY

1. ALL ASTM A36 OR A992/A572 GRADE-50 STEEL UNLESS NOTED. ALL TUBING - ASTM A500 GRADE B. ALL STRUCTURAL PIPE - ASTM A53 GRADE-B.

2. ASTM A325 ERECTION BOLTS. USE THE SHORTEST BOLT THAT WILL ALLOW A F436 FLAT WASHER AND A A563 NUT.

3. ALL HOT DIP GALVANIZED AFTER FABRICATION (ASTM A123).


4. ALL HOLES <u>Ø11/16"</u> FOR <u>Ø5/8"</u> BOLTS UNLESS NOTED.

5. MINIMUM EDGE DISTANCE **7/8**" UNLESS NOTED.

6. PIECE MARK STAMPED INTO METAL WITH NOT LESS THAN 3/8" HIGH CHARACTERS BEFORE GALVANIZING.

7. ALL WELDING ELECTRODES SHALL BE E70XX.


8. \bigotimes MARK INDICATES PROPER ORIENTATION OF STRUCTURAL PIECES.

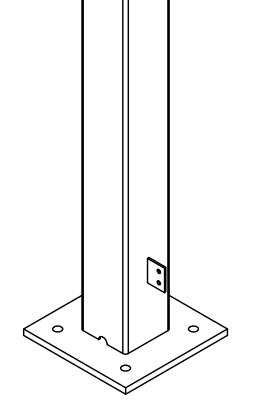



ISOMETRIC VIEW

	-
MAKE STRUCTURE "C"	
<u>"8" - TIMES</u>	


						REFERENCE DRAWINGS
					DRAWING NUMBER	DESCRIPTION
					SC100	STRUCTURE "C" COVER SHEET
					SC200	STRUCTURE "C" ELEVATIONS
					SC300	STRUCTURE "C" ASSEMBLIES & DETAILS (BILL OF MATERIAL)
						CUSTOMER CITY OF DOVER DOVER, DELAWARE SUBSTATION 69-12.47KV SUBSTATION
						TITLE STR. C - ELEVATIONS
9/14/23	JRG	JKG	MR	ISSUED FOR CONSTRUCT	ION	47019 SCALE JLF CVC MAR SC200
9/23/21	KDC	JKG	MR	ISSUE FOR BID		AUBREY SILVEY ENTERPRISES, INC.
7/28/21	JLF	CVC	MR	ISSUED FOR APPROVAL		EPC DIVISION Engineer • Procure • Construct
DATE	DRN	СК	APP	DESCRI	PTION	www.silvey.com/epc 770-537-1144

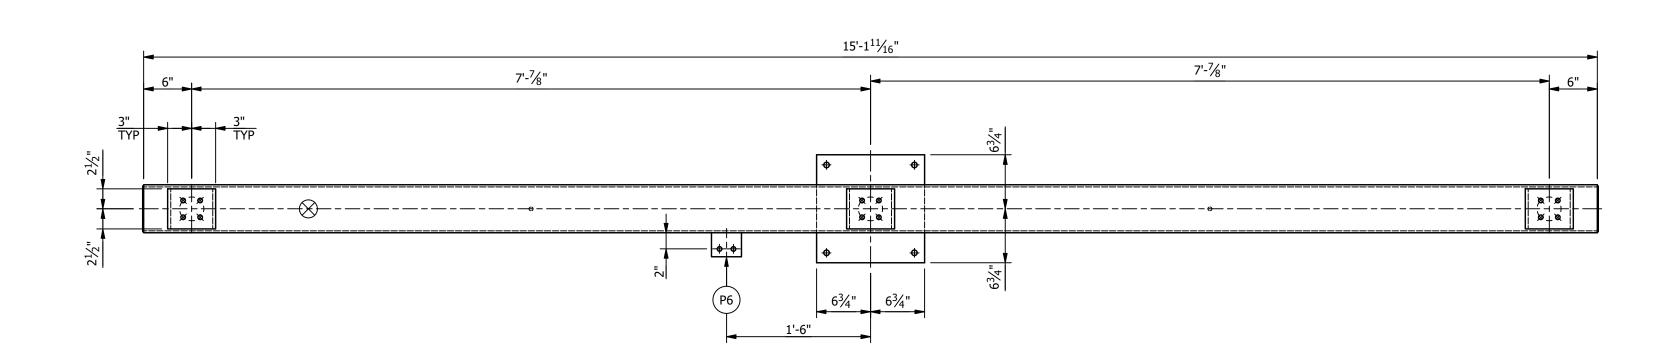


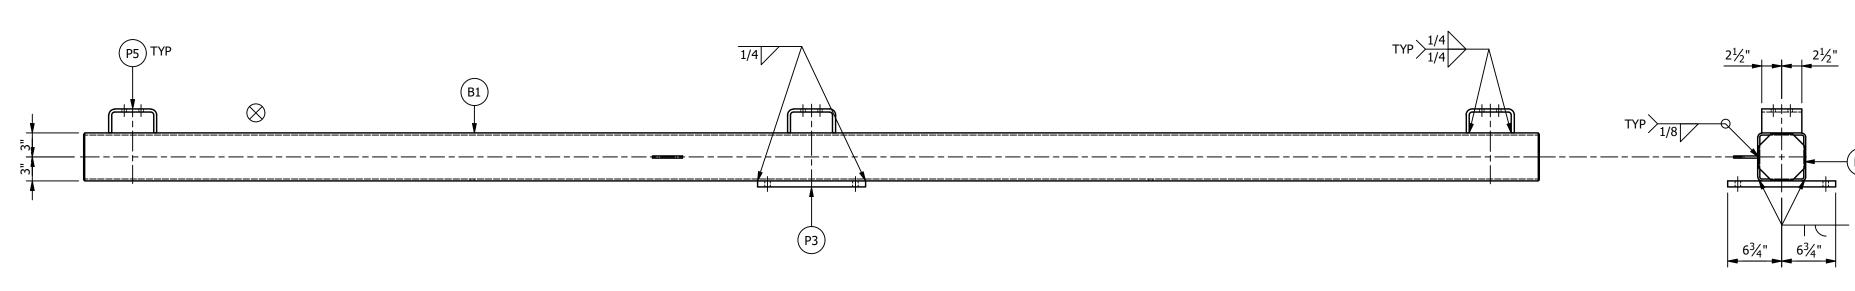


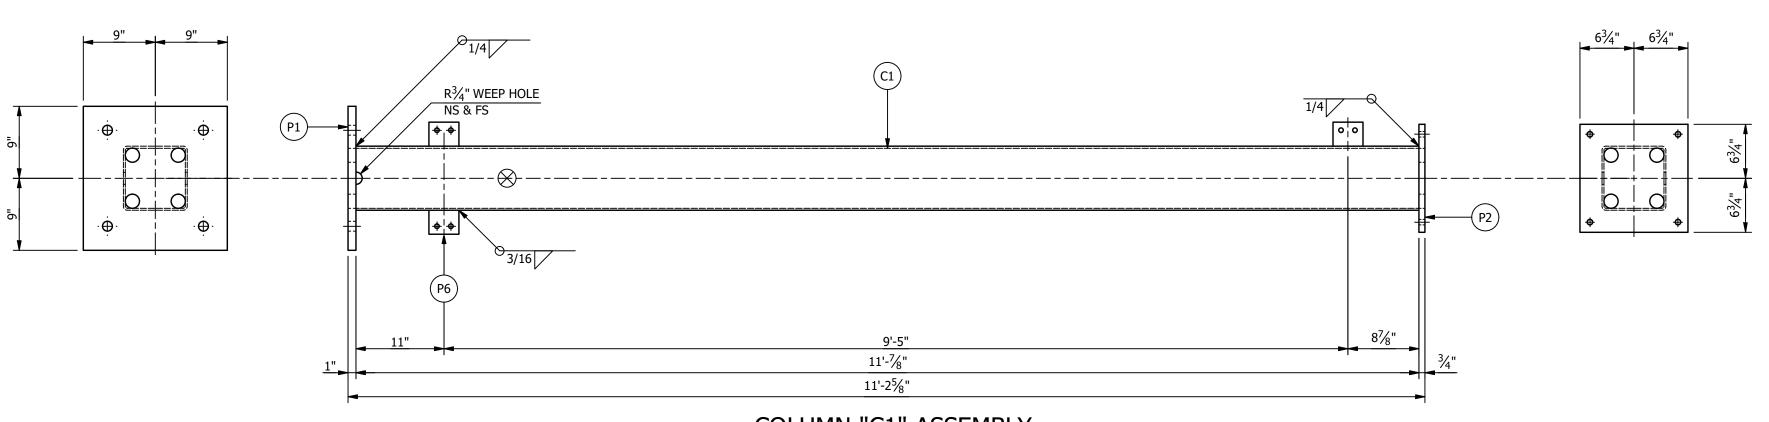


BEAM "B1" ASSEMBLY

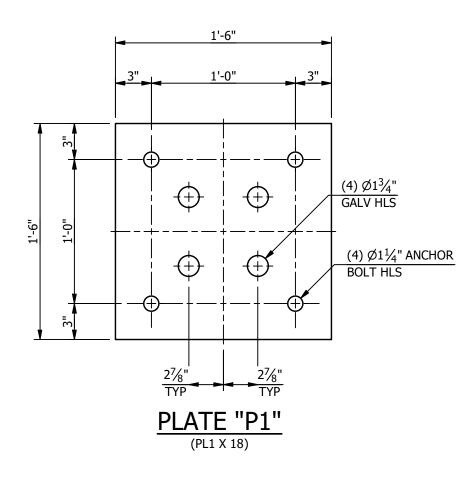


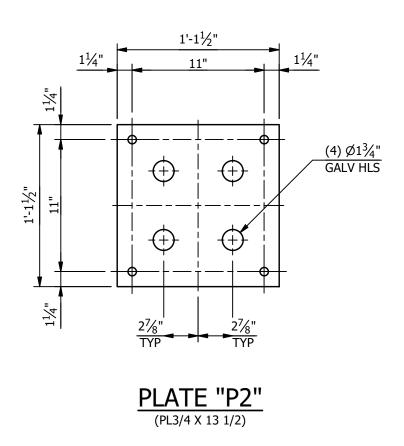


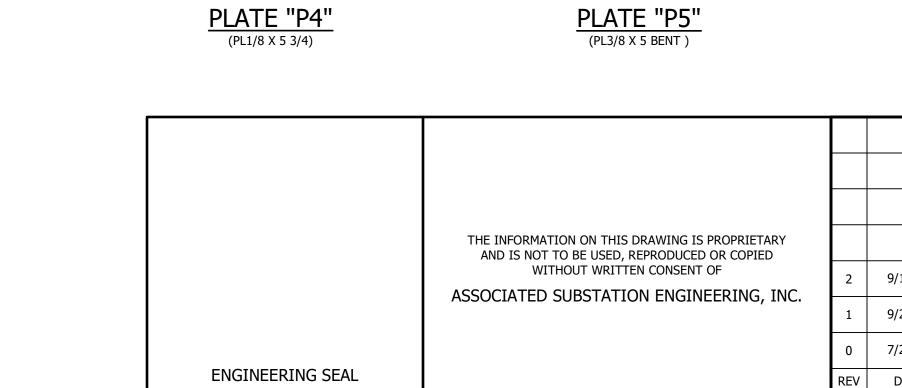



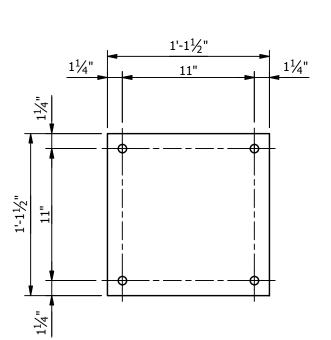

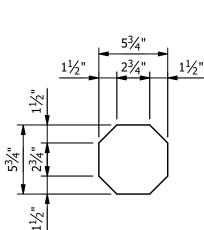

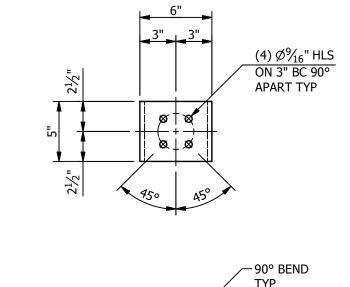

COLUMN "C1" ASSEMBLY

			***E	BILL OF MATERIAL*	**	
MARK	QTY			DESCRIPTION	LENGTH	TOTAL WGT
B1	1	HSS6 X	6 X 1/4		15'-1 11/16"	287.95
C1	1	HSS8 X	8 X 1/4		11'-7/8"	285.95
P1	1	PL1 X 1	8		1'-6"	91.88
P2	1	PL3/4 X	13 1/2		1'-1 1/2"	38.76
P3	1	PL3/4 X	13 1/2		1'-1 1/2"	38.76
P4	2	PL1/8 X	5 3/4		0'-5 3/4"	2.34
P5	3	PL3/8 X	5 BENT		0'-10 11/16"	17.05
P6	4	PL1/4 X	3		0'-3 3/4"	3.19
					Total Blk wgt = Tal galv wgt =	
		9	STRUC	TURE BOLT ASSEME	BLIES	
QTY	,	DIA	LENGTH	DESCRIP	ΓΙΟΝ	
5		5/8"	2 3/4"	GALV A325 HHB W/ GALV F436 HARDI	ENED FW & GALV	A563-DH HHN

-(P4) TYP

SUFFIX ALL PIECE MARKS WITH "STRUCTURE DESIGNATION" THUS PIECE MARK XX BECOMES XXC

NOTES:

1. ALL ASTM A36 OR A992/A572 GRADE-50 STEEL UNLESS NOTED. ALL TUBING - ASTM A500 GRADE B. ALL STRUCTURAL PIPE - ASTM A53 GRADE-B.


2. ASTM A325 ERECTION BOLTS. USE THE SHORTEST BOLT THAT WILL ALLOW A F436 FLAT WASHER AND A A563 NUT.

3. ALL HOT DIP GALVANIZED AFTER FABRICATION (ASTM A123).


ALL HOLES <u>Ø11/16"</u> FOR <u>Ø5/8"</u> BOLTS UNLESS NOTED.
 MINIMUM EDGE DISTANCE <u>7/8"</u> UNLESS NOTED.

6. PIECE MARK STAMPED INTO METAL WITH NOT LESS THAN 3/8" HIGH CHARACTERS BEFORE GALVANIZING.

7. ALL WELDING ELECTRODES SHALL BE E70XX.

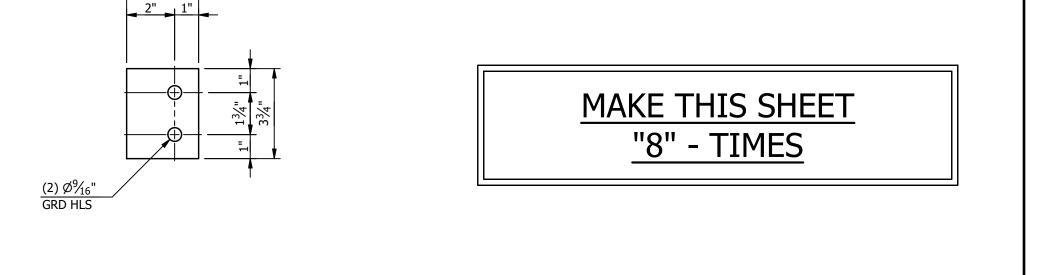

	ΟΙ Δ	TE "	D6"		REFERENCE DRAWINGS			
		PL1/4 X 3			DRAWING NUMBER	DESCRIPTION		
	(·	, . ,	,		SC100	STRUCTURE "C" COVER SHEET		
					SC200	STRUCTURE "C" ELEVATIONS		
					SC300	STRUCTURE "C" ASSEMBLIES & DETAILS (BILL OF MATERIAL)		
9/14/23	IRG	JKG	MR	ISSUED FOR CONSTRUCT	ION	CUSTOMER CITY OF DOVER DOVER, DELAWARE SUBSTATION 69-12.47KV SUBSTATION TITLE STR. C - ASSEMBLIES & DETAILS PROJECT NUMBER 47019 CHECKED APPROVED DRAWING NUMBER		
9/23/21	JLF	JKG	MR	ISSUE FOR BID		SCALE JLF CVC MAR SC300		
7/28/21	JLF	CVC	MR	ISSUED FOR APPROVAL		AUBREY SILVEY ENTERPRISES, INC. EPC DIVISION Engineer • Procure • Construct		
DATE	DRN	СК	APP	DESCRI	PTION	www.silvey.com/epc 770-537-1144		

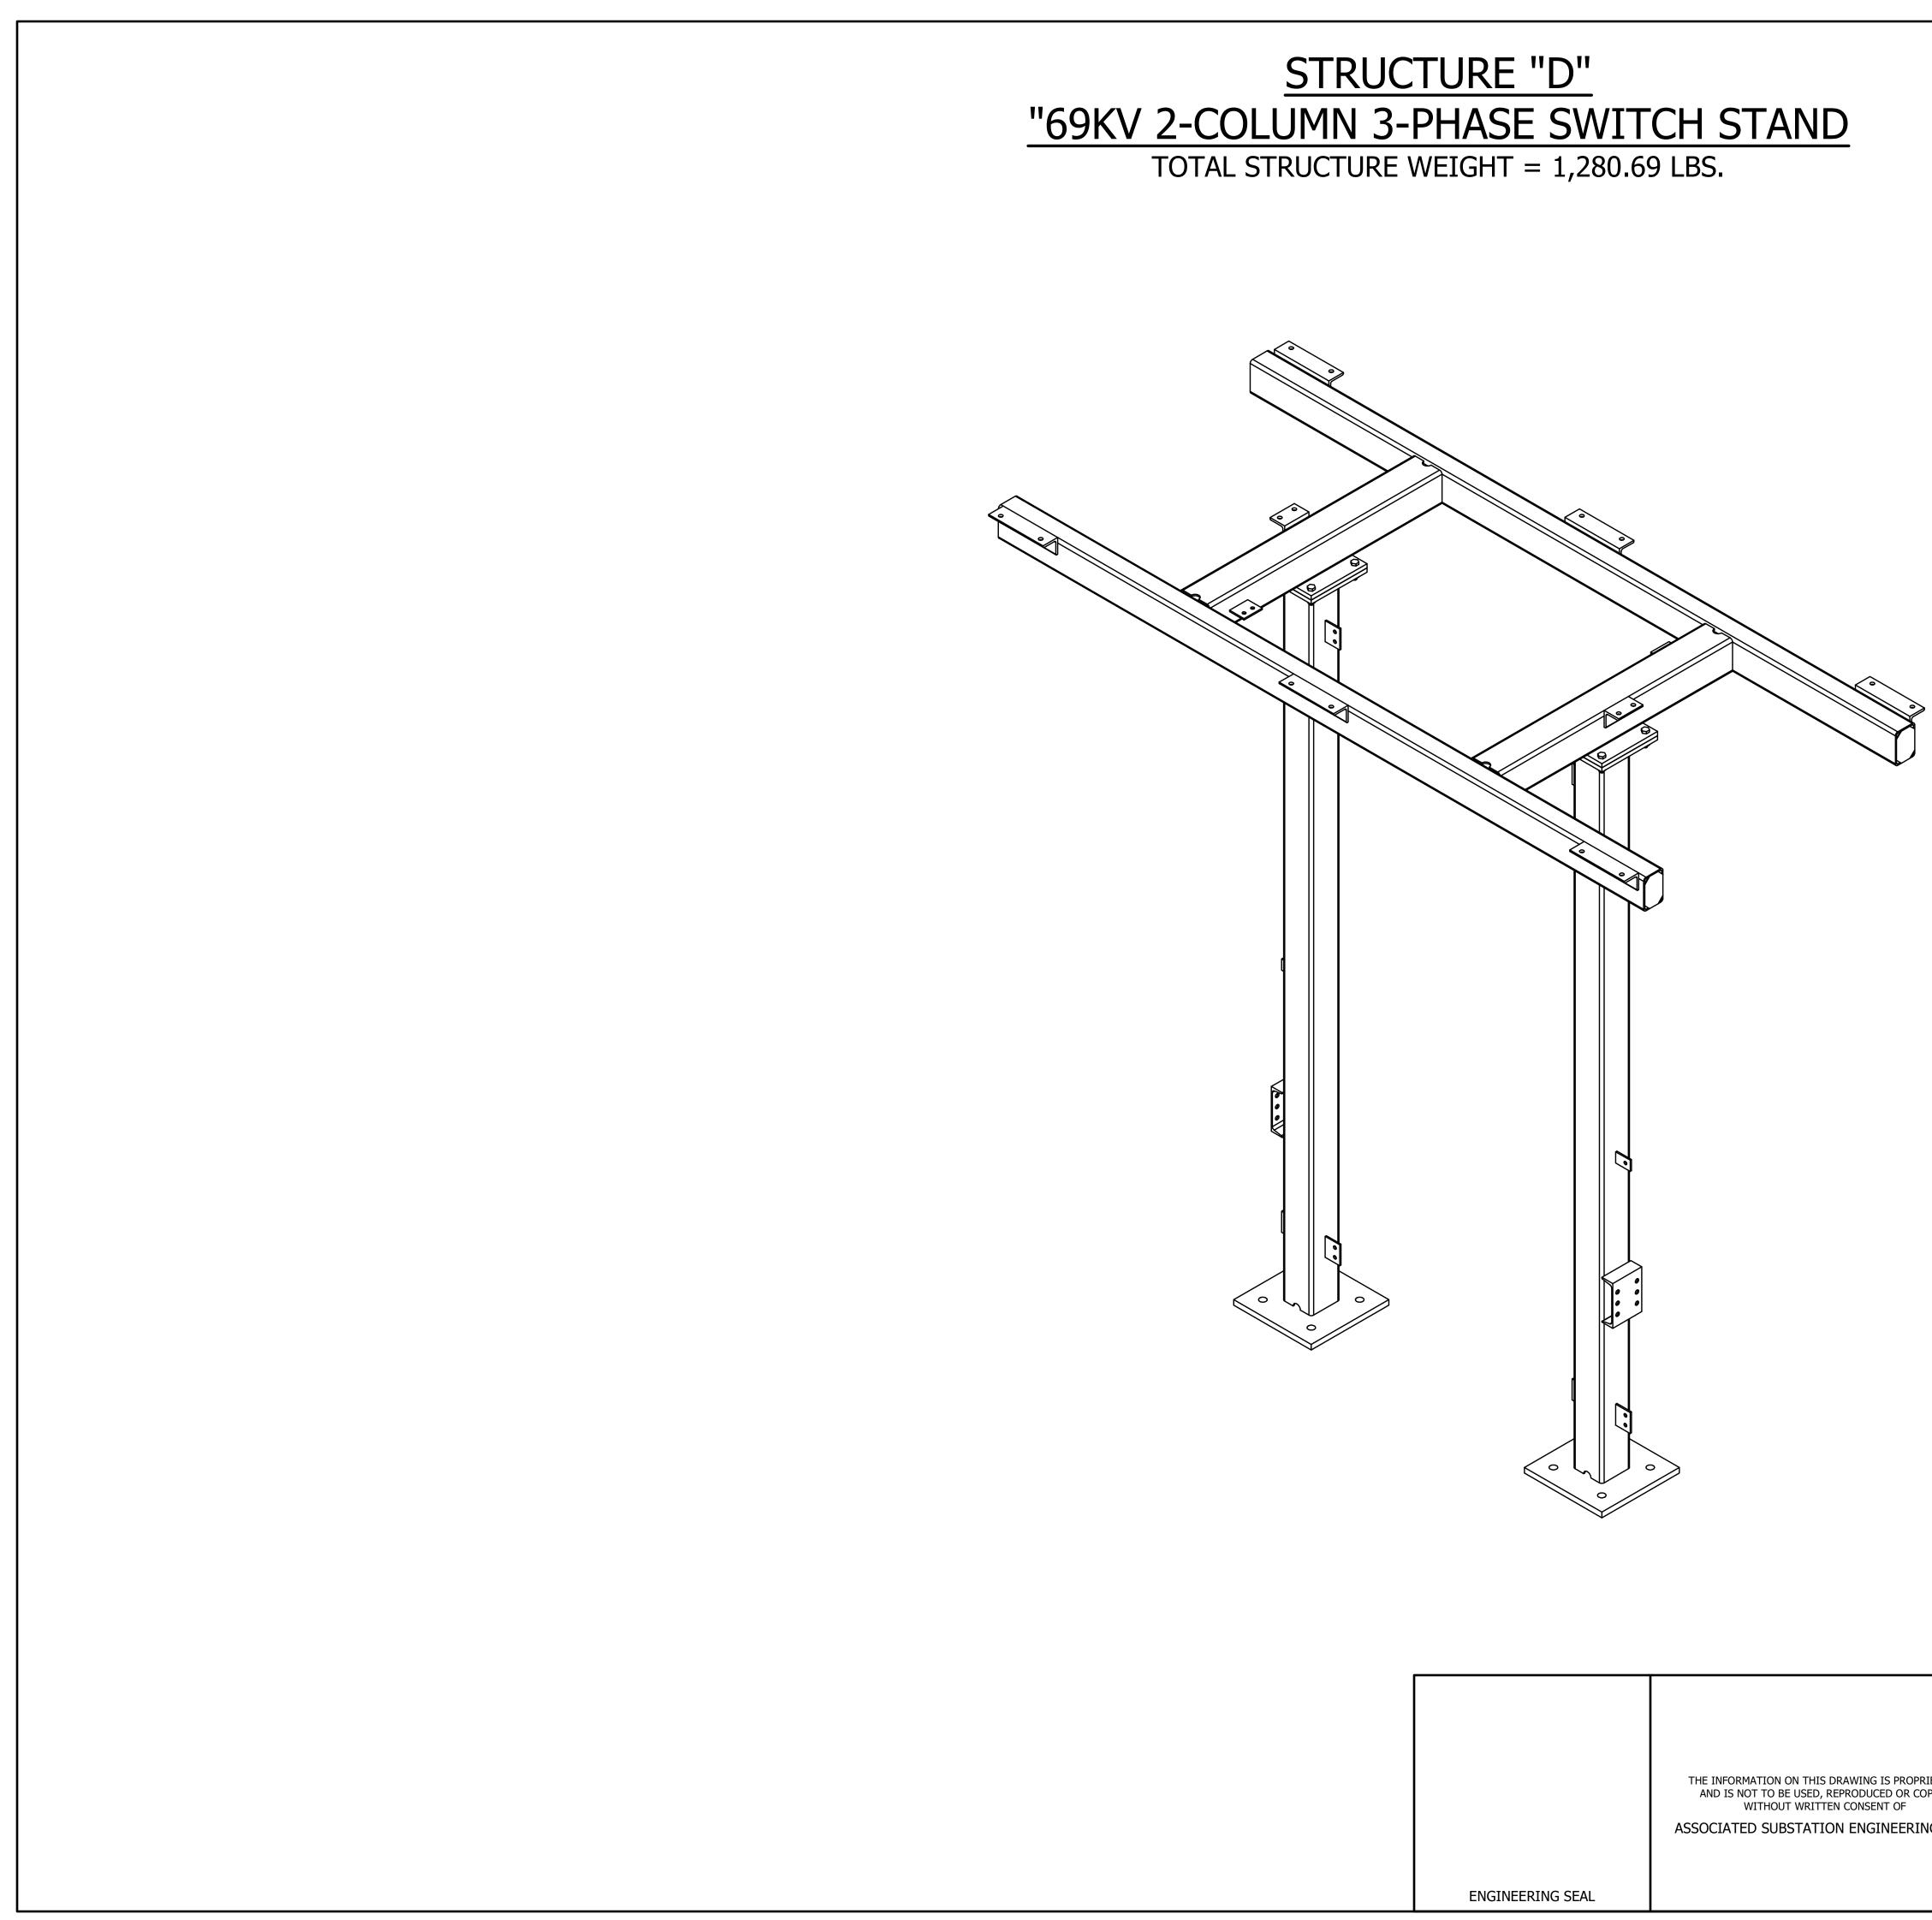


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	WITHOUT WRITTEN CONSENT OF	2	
	ASSOCIATED SUBSTATION ENGINEERING, INC.	1	
		0	
ENGINEERING SEAL		REV	


			ANCHOR BOLTS
QTY	DIA	LENGTH	DECSRIPTION
8	1"	2'-6"	GALV ANCHOR BOLTS WITH 2 HHN AND 2 FW (F1554 GRADE 55)

MAKE STRUCTURE "D" <u>"1" - TIME</u>

						REFERENCE DRAWINGS
					DRAWING NUMBER	DESCRIPTION
					SD100	STRUCTURE "D" COVER SHEET
					SD200	STRUCTURE "D" ELEVATIONS
					SD300	STRUCTURE "D" ASSEMBLIES & DETAILS (BILL OF MATERIAL)
						CUSTOMER CITY OF DOVER DOVER, DELEWARE SUBSTATION 69-12.47 KV SUBSTATION TITLE STR. D - COVER SHEET
9/14/23	JRG	JKG	MR	ISSUED FOR CONSTRUC	CTION	PROJECT NUMBER DRAWN CHECKED APPROVED DRAWING NUMBER 47019 JLF JKG MAR SD100
9/23/21	KDC	JKG	MR	ISSUE FOR BID		AUBREY SILVEY ENTERPRISES, INC. SSOCIATED
7/28/21	JLF	CVC	MR	ISSUED FOR APPROVAL		Engineer • Procure • Construct
DATE	DRN	СК	APP	DESCR	IPTION	www.silvey.com/epc 770-537-1144

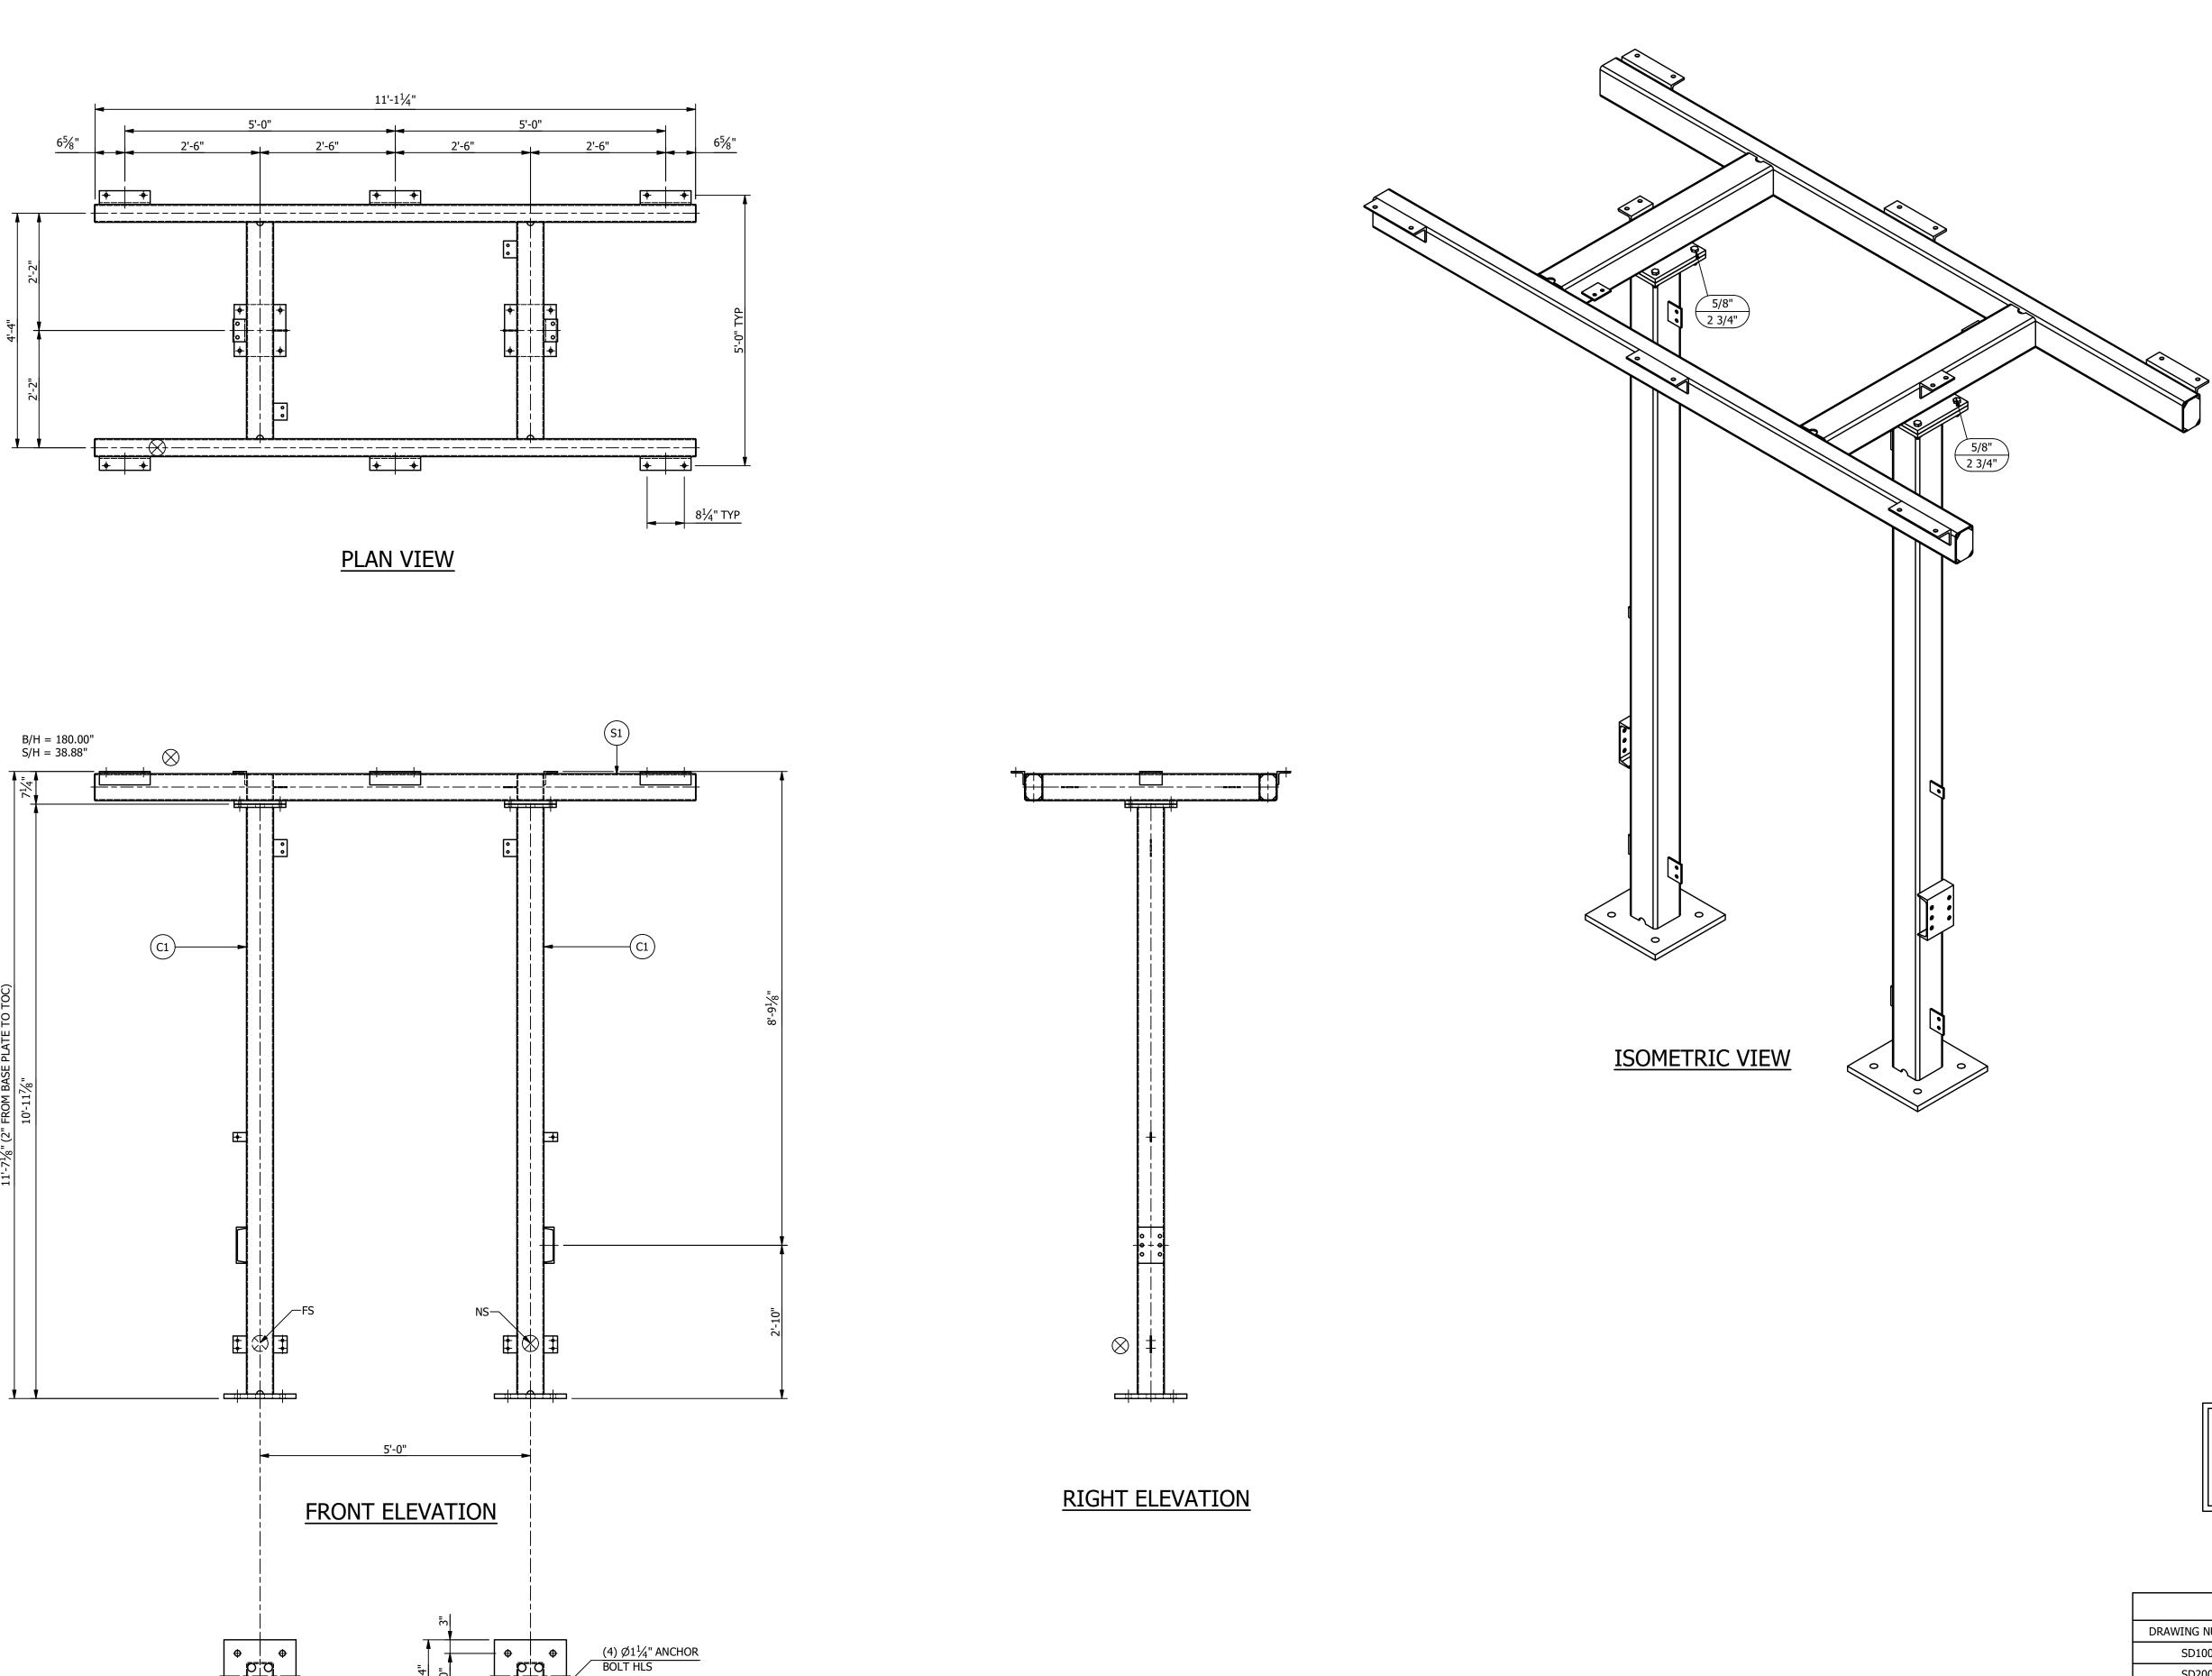



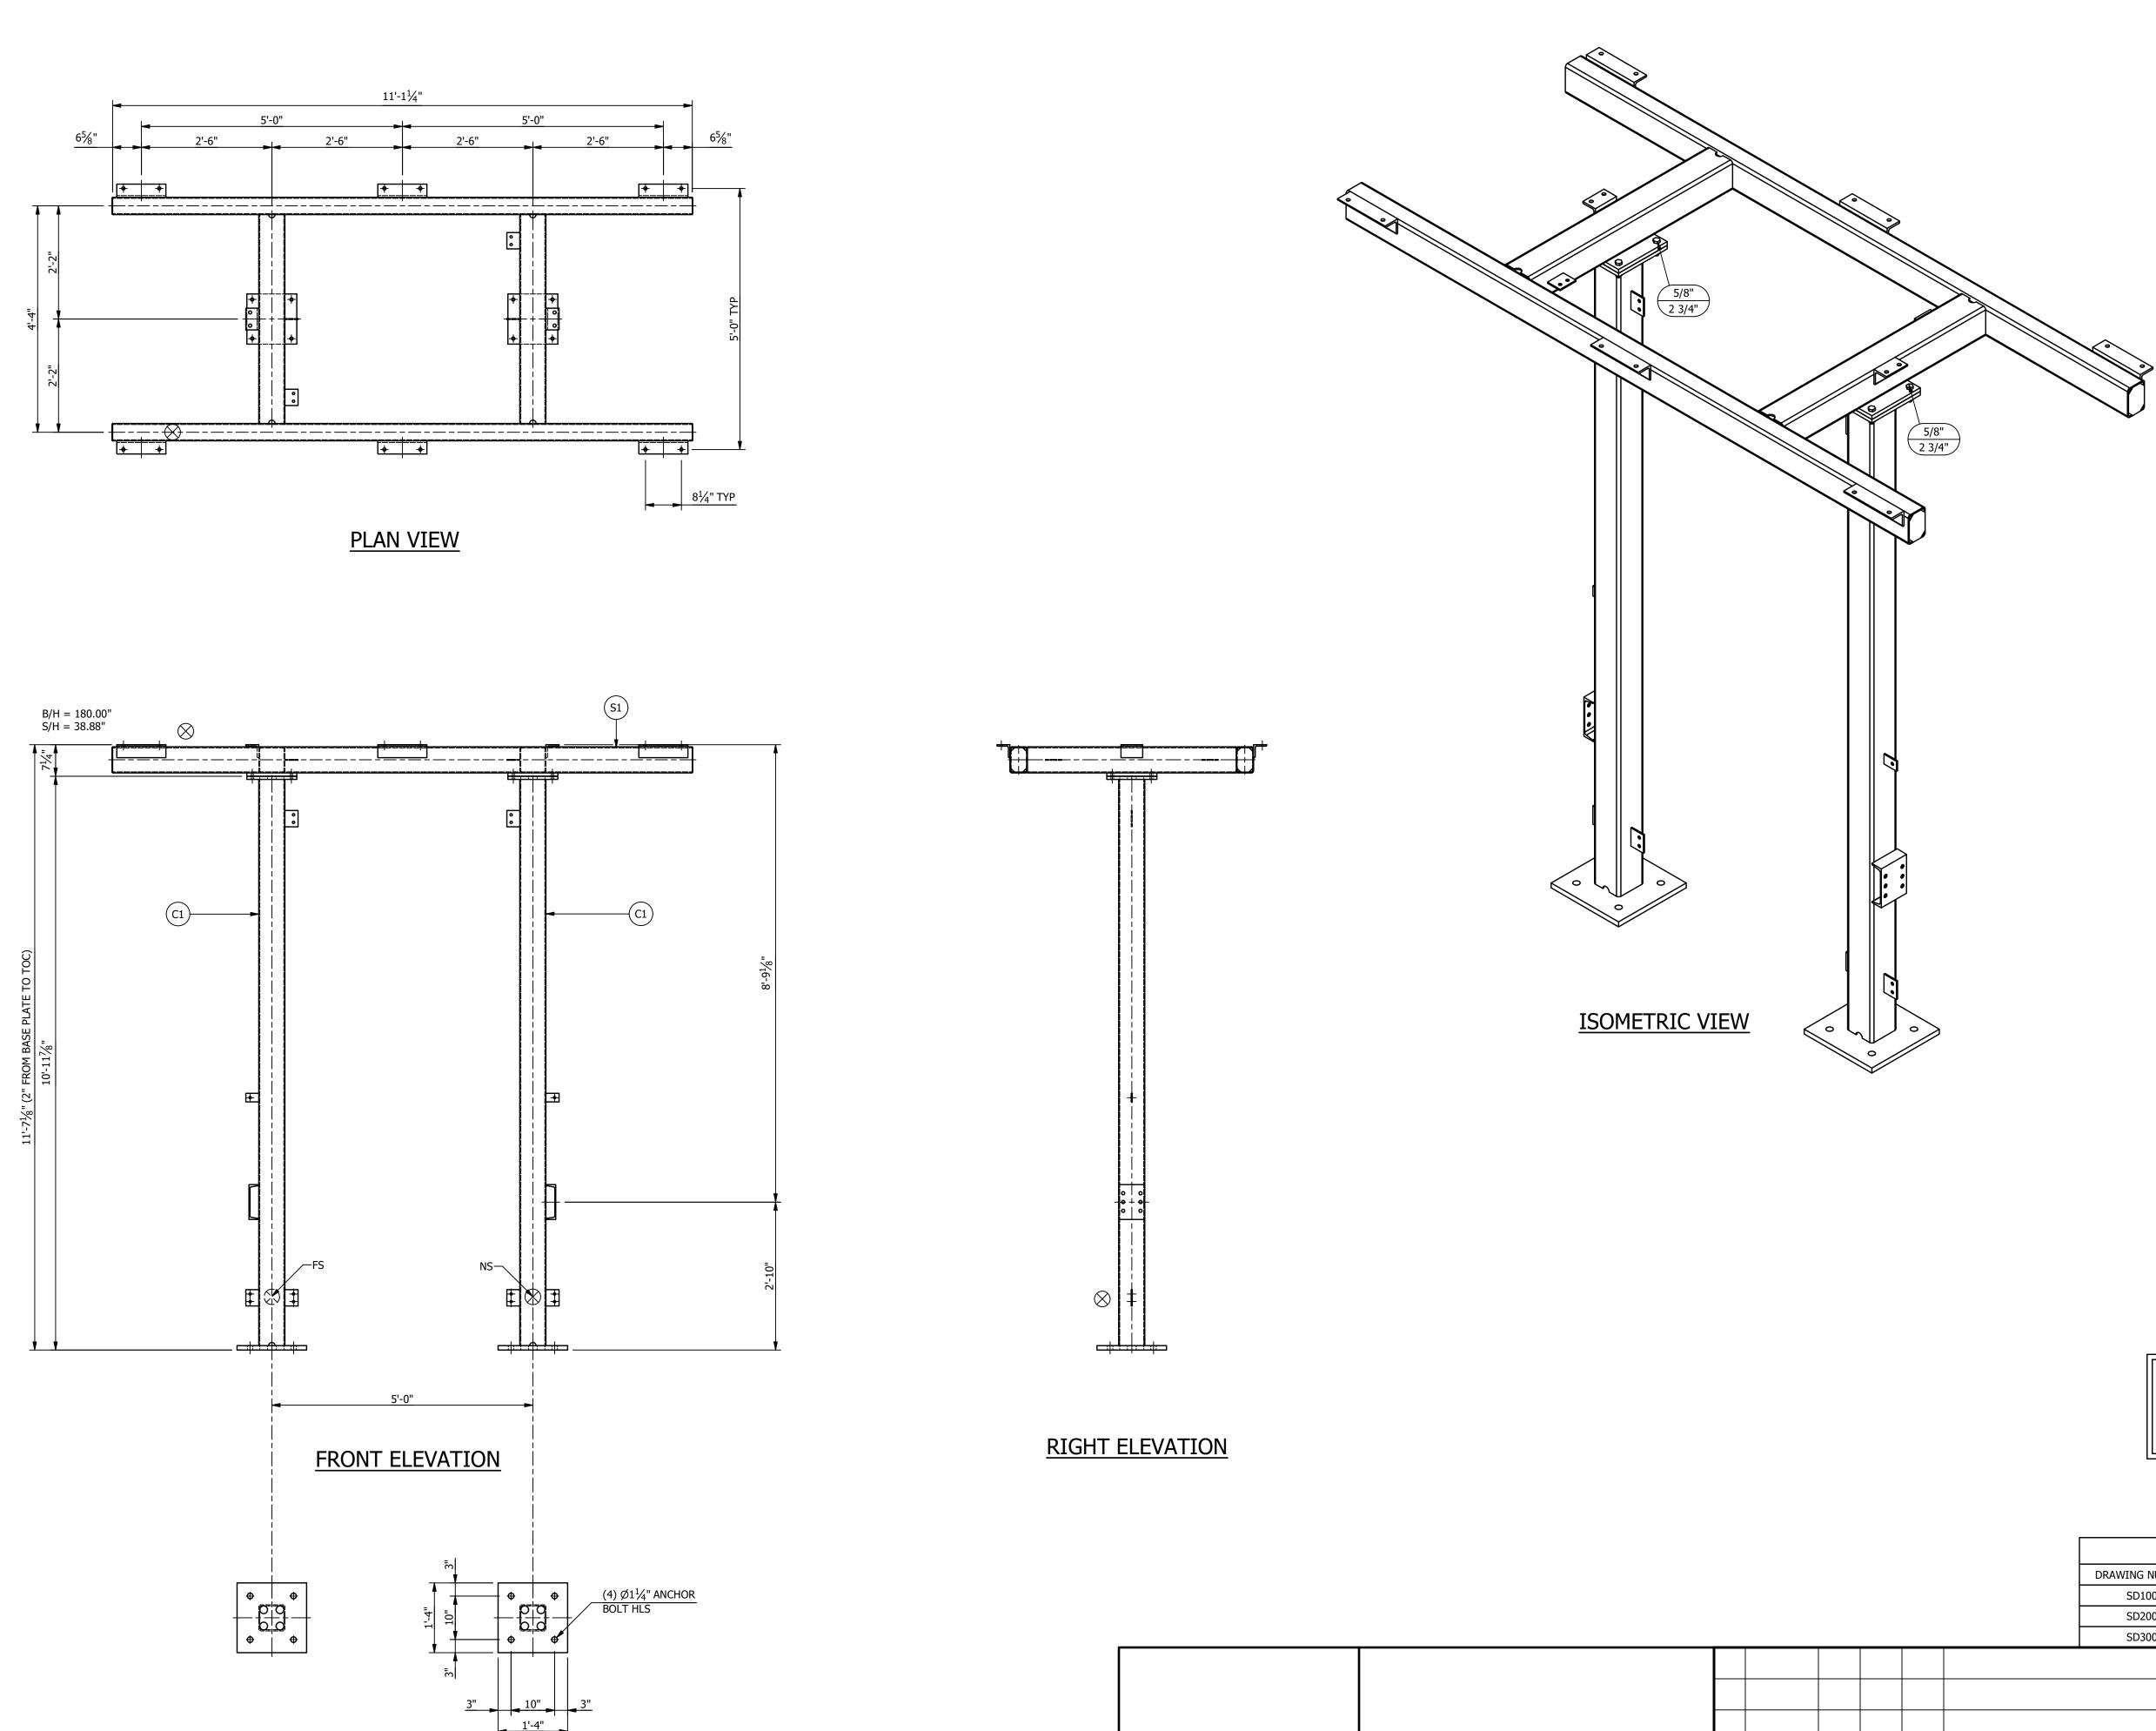

	THE INFORMATION ON THIS DRAWING IS PROPRIETARY AND IS NOT TO BE USED, REPRODUCED OR COPIED		
	WITHOUT WRITTEN CONSENT OF	2	
	ASSOCIATED SUBSTATION ENGINEERING, INC.		╞
		1	
		0	
ENGINEERING SEAL		REV	

ASSEMBLIES DESCRIPTION

- MARK QTY
- C1 2 COLUMN "C1" S1 1 SWITCH FRAME "S1"

NOTES:

1. ALL ASTM A36 OR A992/A572 GRADE-50 STEEL UNLESS NOTED. ALL TUBING - ASTM A500 GRADE B. ALL STRUCTURAL PIPE - ASTM A53 GRADE-B.

2. ASTM A325 ERECTION BOLTS. USE THE SHORTEST BOLT THAT WILL ALLOW A F436 FLAT WASHER AND A A563 NUT.

- 3. ALL HOT DIP GALVANIZED AFTER FABRICATION (ASTM A123).
- 4. ALL HOLES <u>Ø11/16"</u> FOR <u>Ø5/8"</u> BOLTS UNLESS NOTED.
- 5. MINIMUM EDGE DISTANCE 7/8" UNLESS NOTED.


6. PIECE MARK STAMPED INTO METAL WITH NOT LESS THAN 3/8" HIGH CHARACTERS BEFORE GALVANIZING.


7. ALL WELDING ELECTRODES SHALL BE E70XX.

8. \bigotimes MARK INDICATES PROPER ORIENTATION OF STRUCTURAL PIECES.

MAKE STRUCTURE "D" <u>"1" - TIME</u>


						REFE	RENCE	E DRAN	WING	6
					DRAWING NUMBER			DESC	RIPTION	
					SD100	STRUCTURE "D'	' COVER SHE	EET		
					SD200	STRUCTURE "D'	' ELEVATION	NS		
					SD300	STRUCTURE "D'	' ASSEMBLIE	ES & DETAIL	S (BILL OF I	MATERIAL)
						TITLE	69 -12	2.47 K\ . D - E	DELEWARE	
9/14/23	JRG	JKG	MR	ISSUED FOR CONSTRUCT	ION	PROJECT NUMBER 47019 SCALE NTS		JKG	APPROVED MAR	DRAWING NUMBER
9/23/21	KDC	JKG	MR	ISSUE FOR BID		AUBREY SILV	I Ey enterp	I RISES, INC		SOCIATED
7/28/21	JLF	CVC	MR	ISSUED FOR APPROVAL			-	/ISION	▞▏/▔▌▁	UBSTATION
DATE	DRN	СК	APP	DESCRIF	PTION		silvey.com/ep			www.aseng.com 770-537-0033

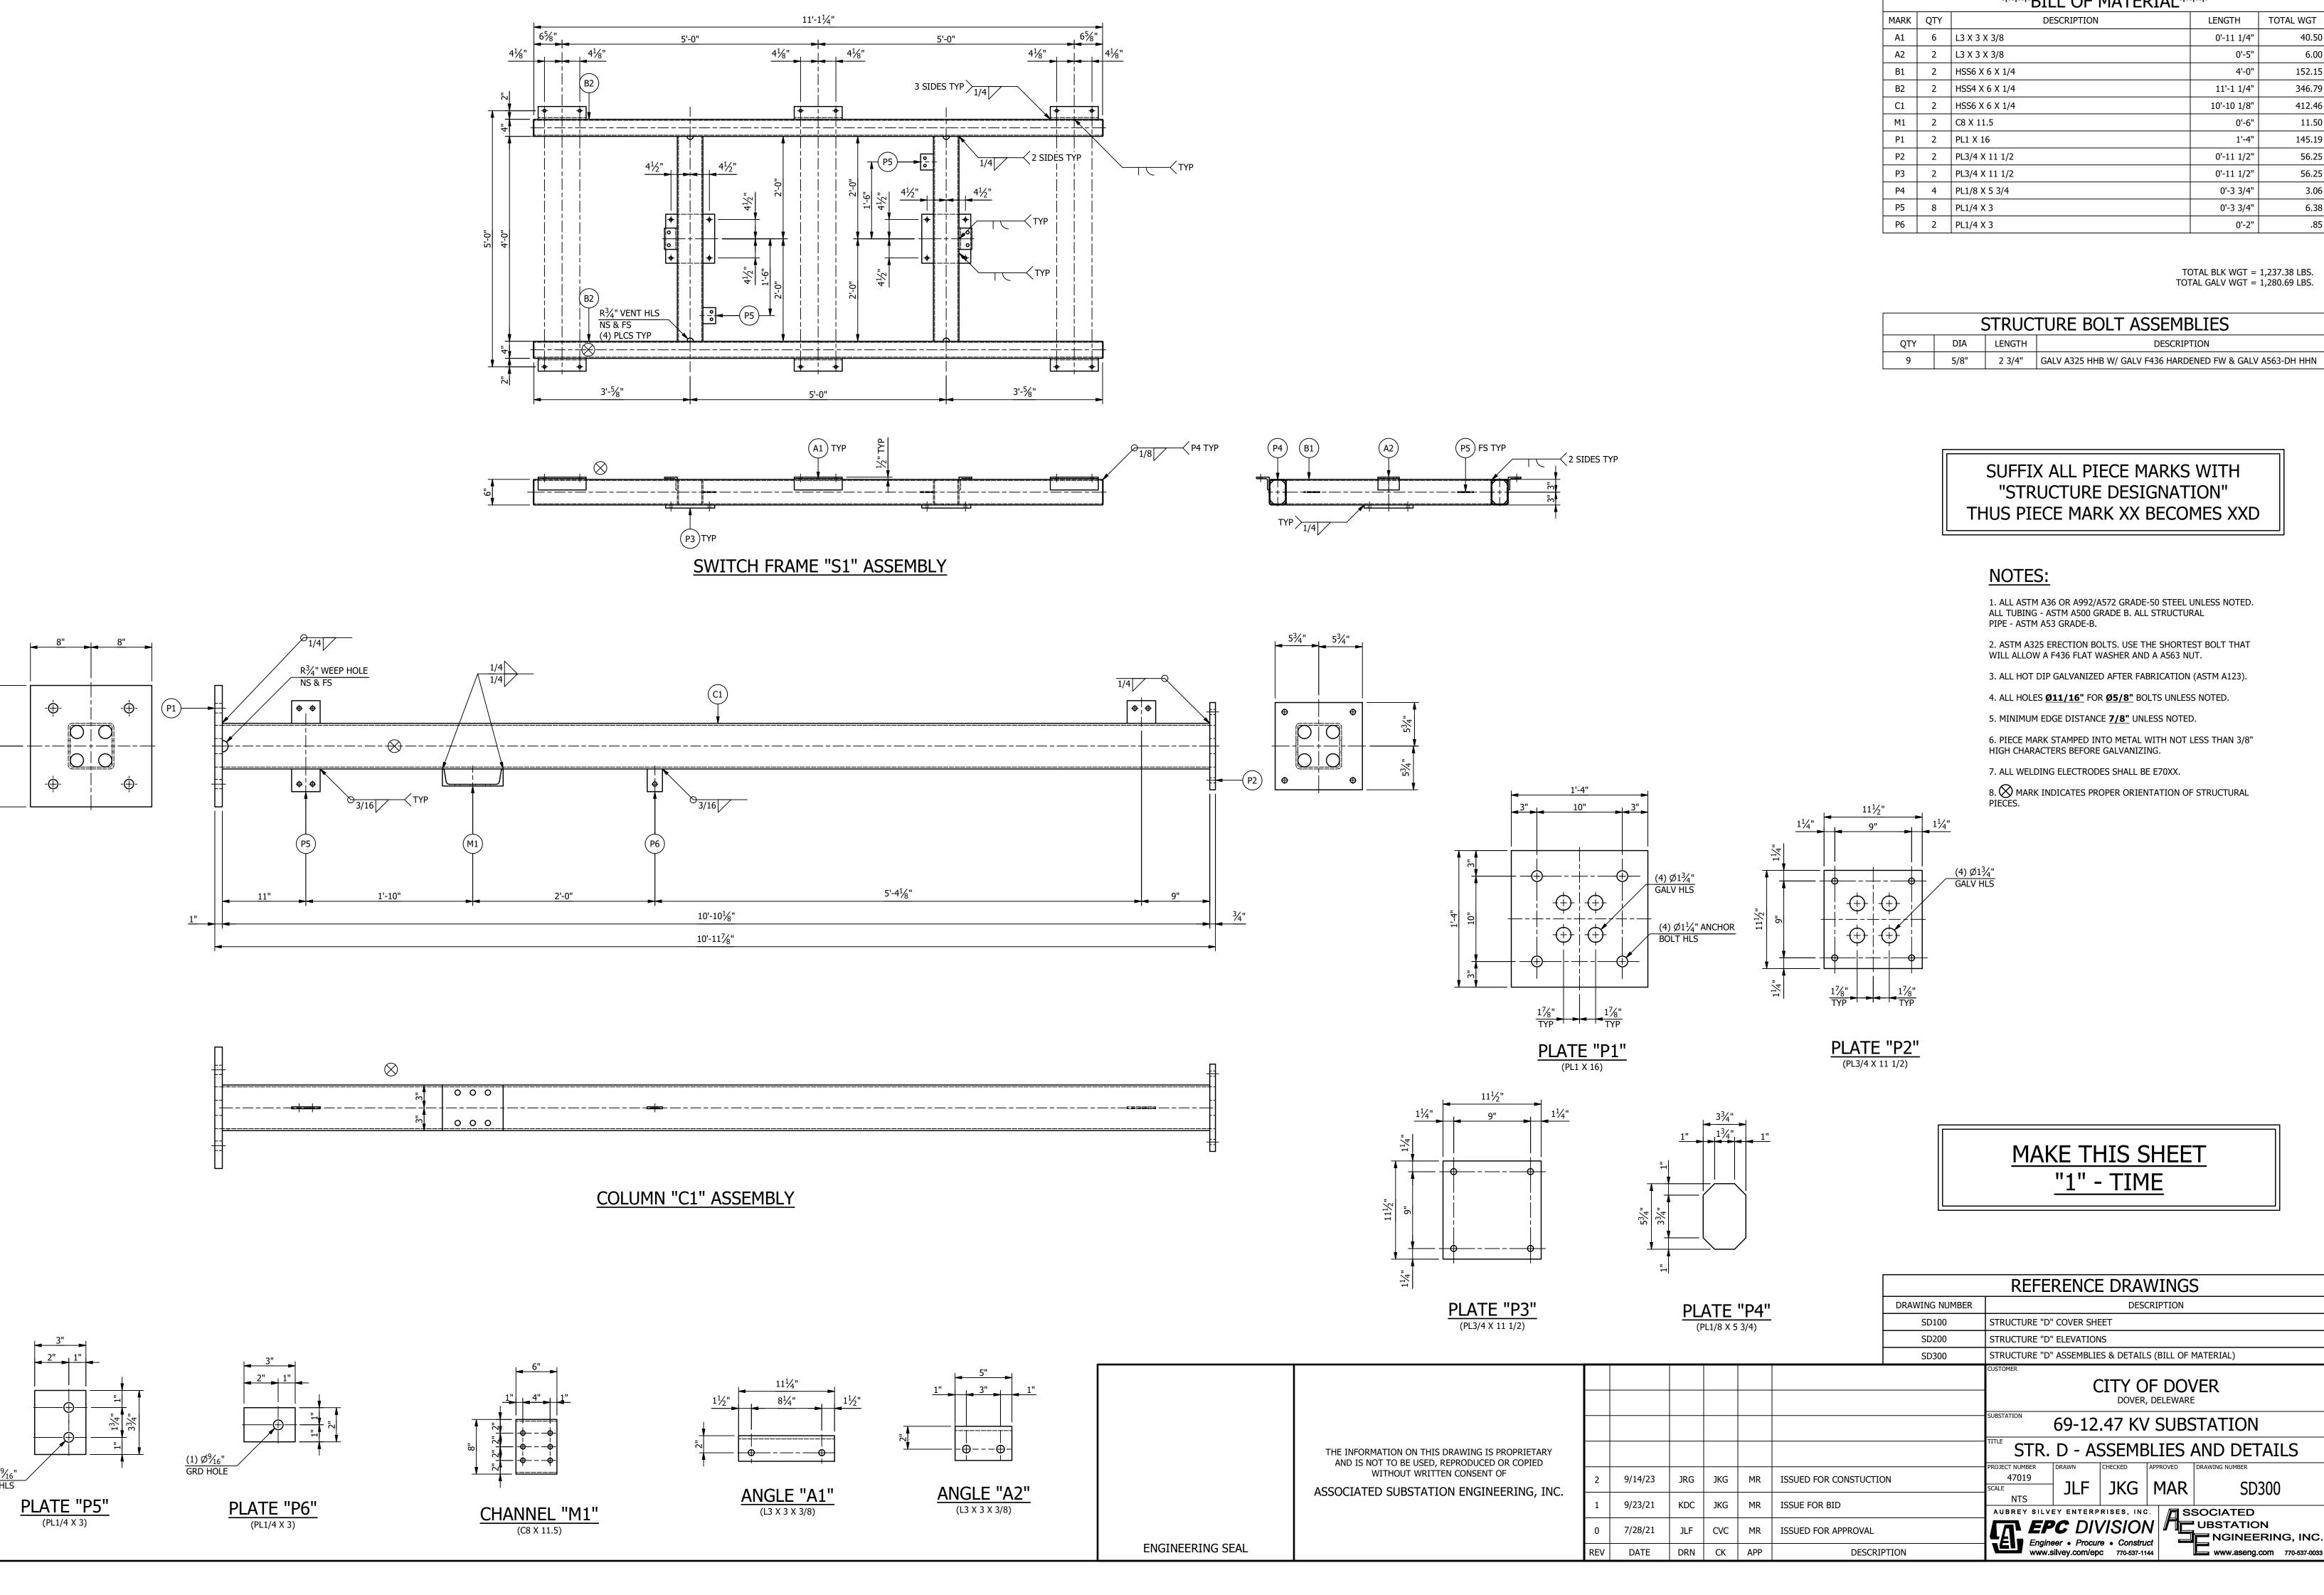

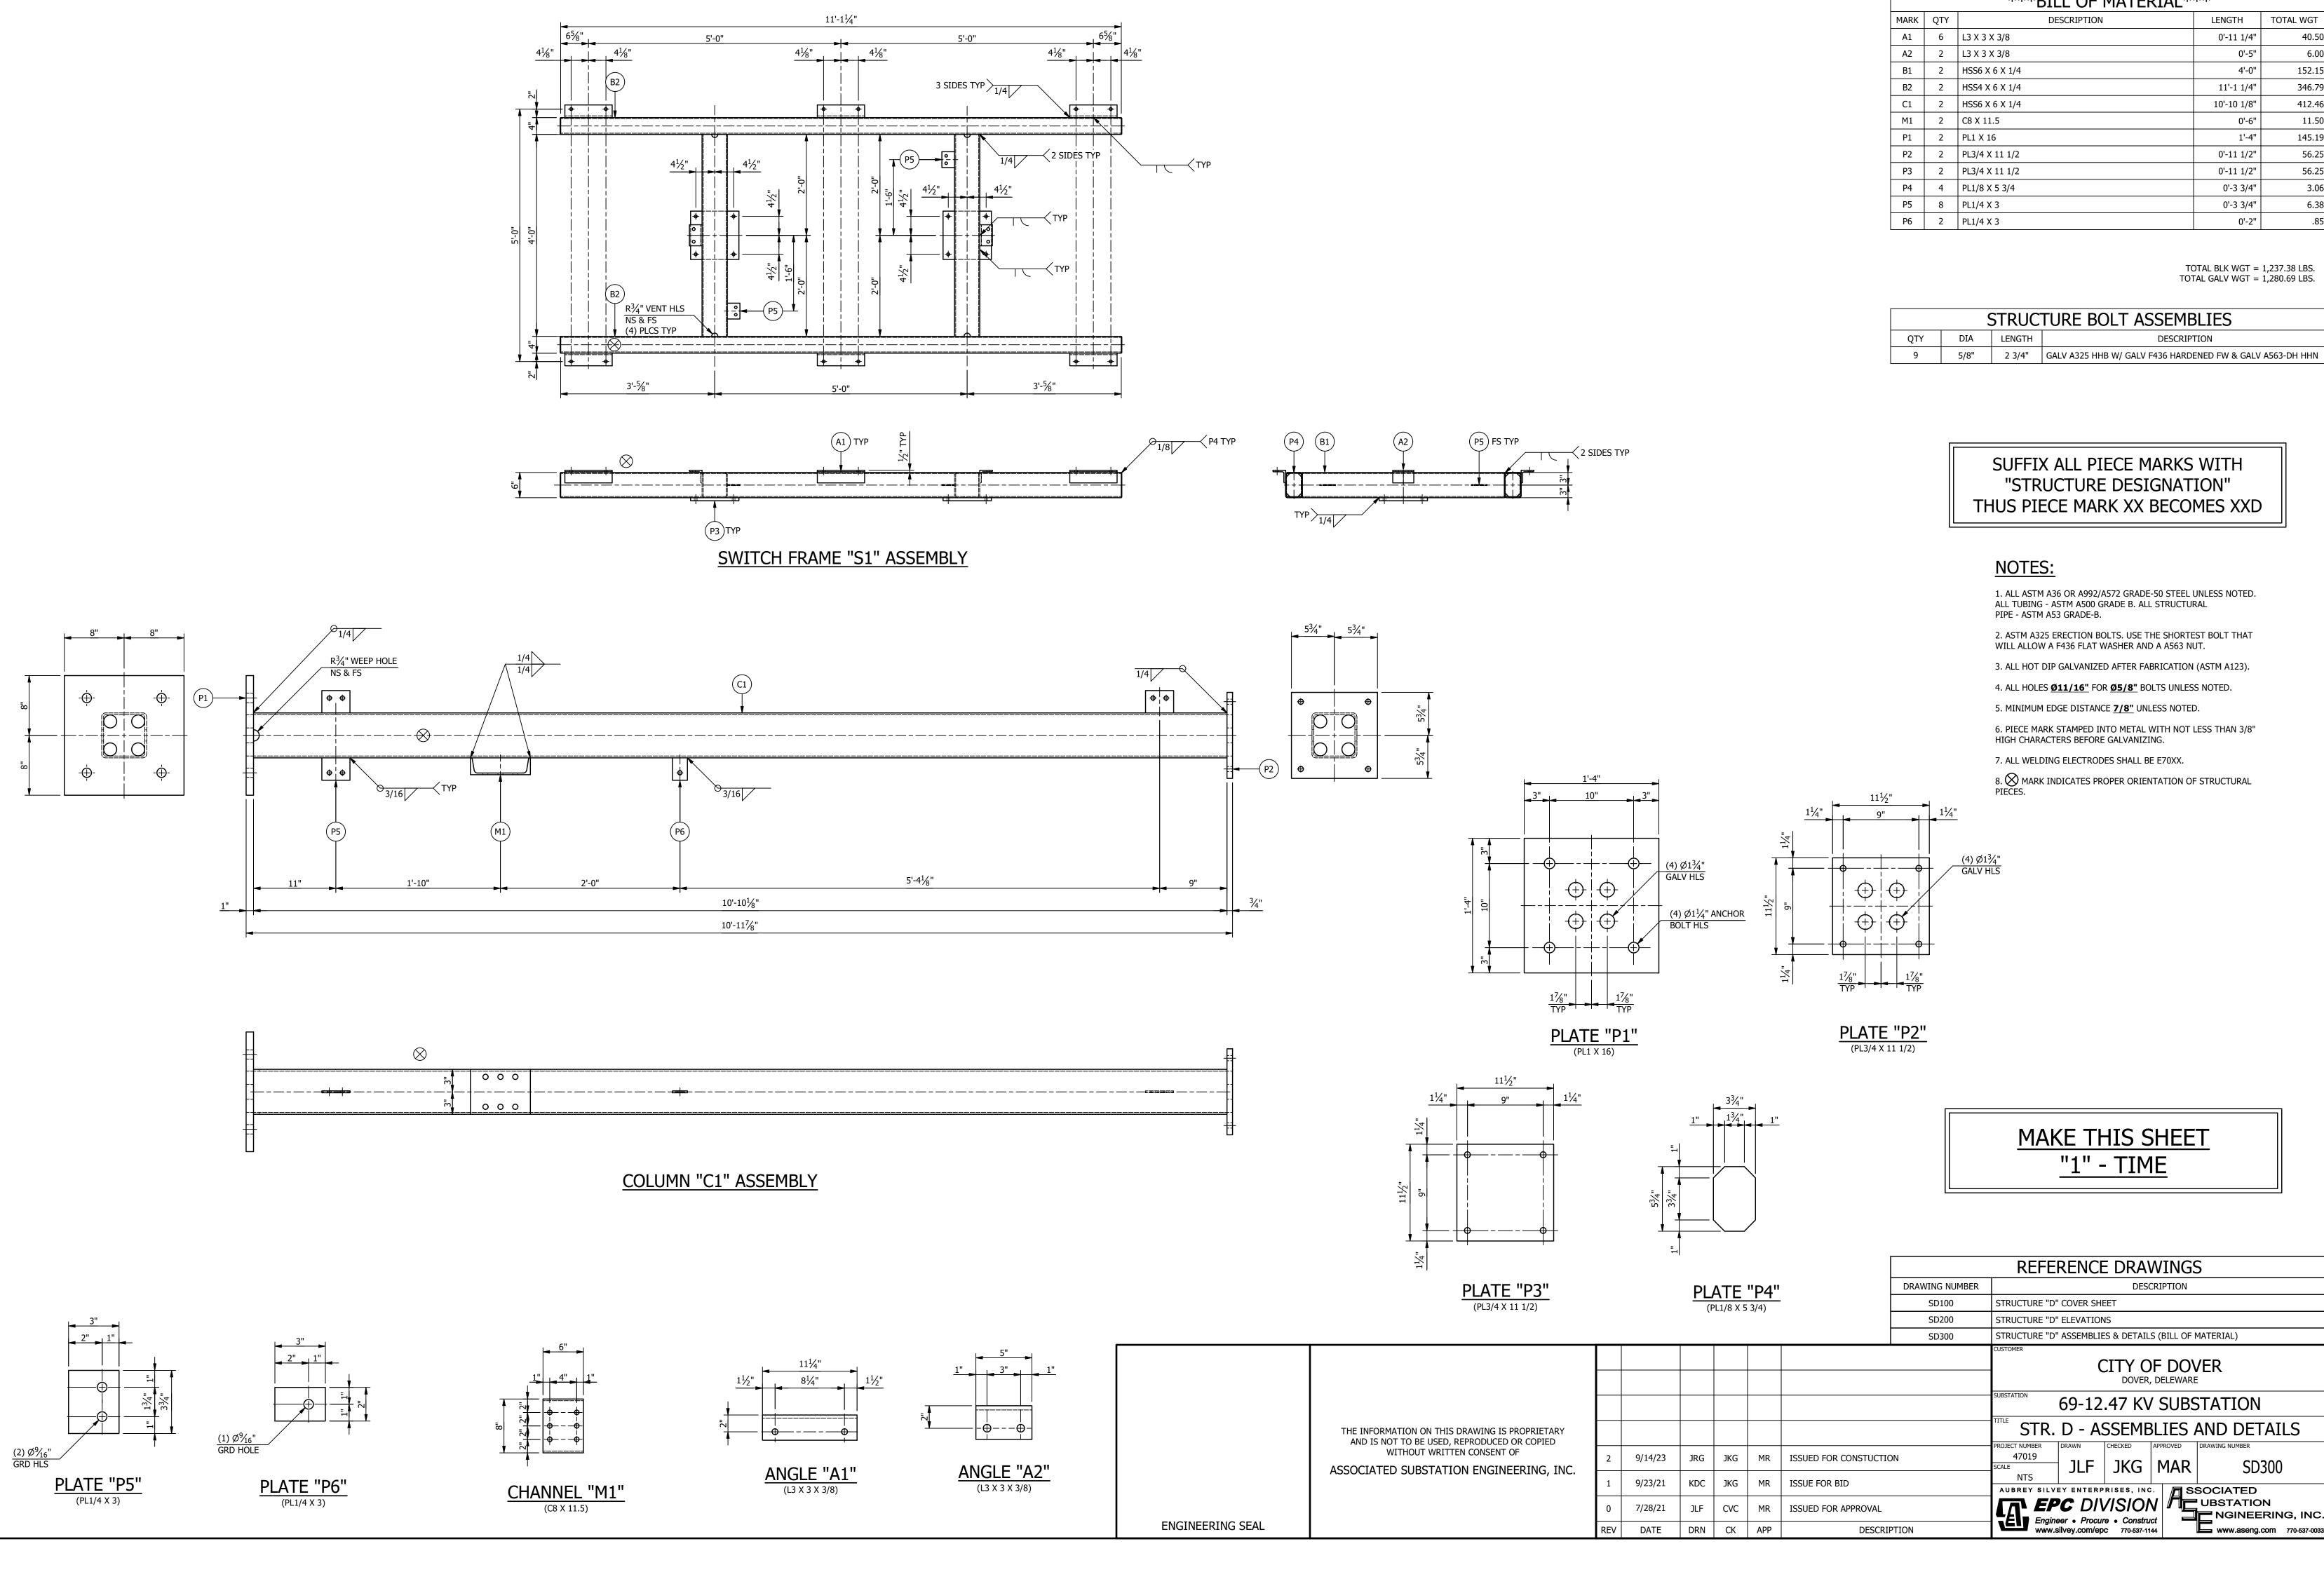

	BILL OF MATERIAL								
MARK	QTY	DESCRIPTION	LENGTH	TOTAL WGT					
A1	6	L3 X 3 X 3/8	0'-11 1/4"	40.50					
A2	2	L3 X 3 X 3/8	0'-5"	6.00					
B1	2	HSS6 X 6 X 1/4	4'-0"	152.15					
B2	2	HSS4 X 6 X 1/4	11'-1 1/4"	346.79					
C1	2	HSS6 X 6 X 1/4	10'-10 1/8"	412.46					
M1	2	C8 X 11.5	0'-6"	11.50					
P1	2	PL1 X 16	1'-4"	145.19					
P2	2	PL3/4 X 11 1/2	0'-11 1/2"	56.25					
P3	2	PL3/4 X 11 1/2	0'-11 1/2"	56.25					
P4	4	PL1/8 X 5 3/4	0'-3 3/4"	3.06					
P5	8	PL1/4 X 3	0'-3 3/4"	6.38					
P6	2	PL1/4 X 3	0'-2"	.85					

STRUCTURE BOLT ASSEMBLIES							
QTY	DIA	LENGTH	DESCRIPTION				
9	5/8"	2 3/4"	GALV A325 HHB W/ GALV F436 HARDENED FW & GALV A563-DH HHN				

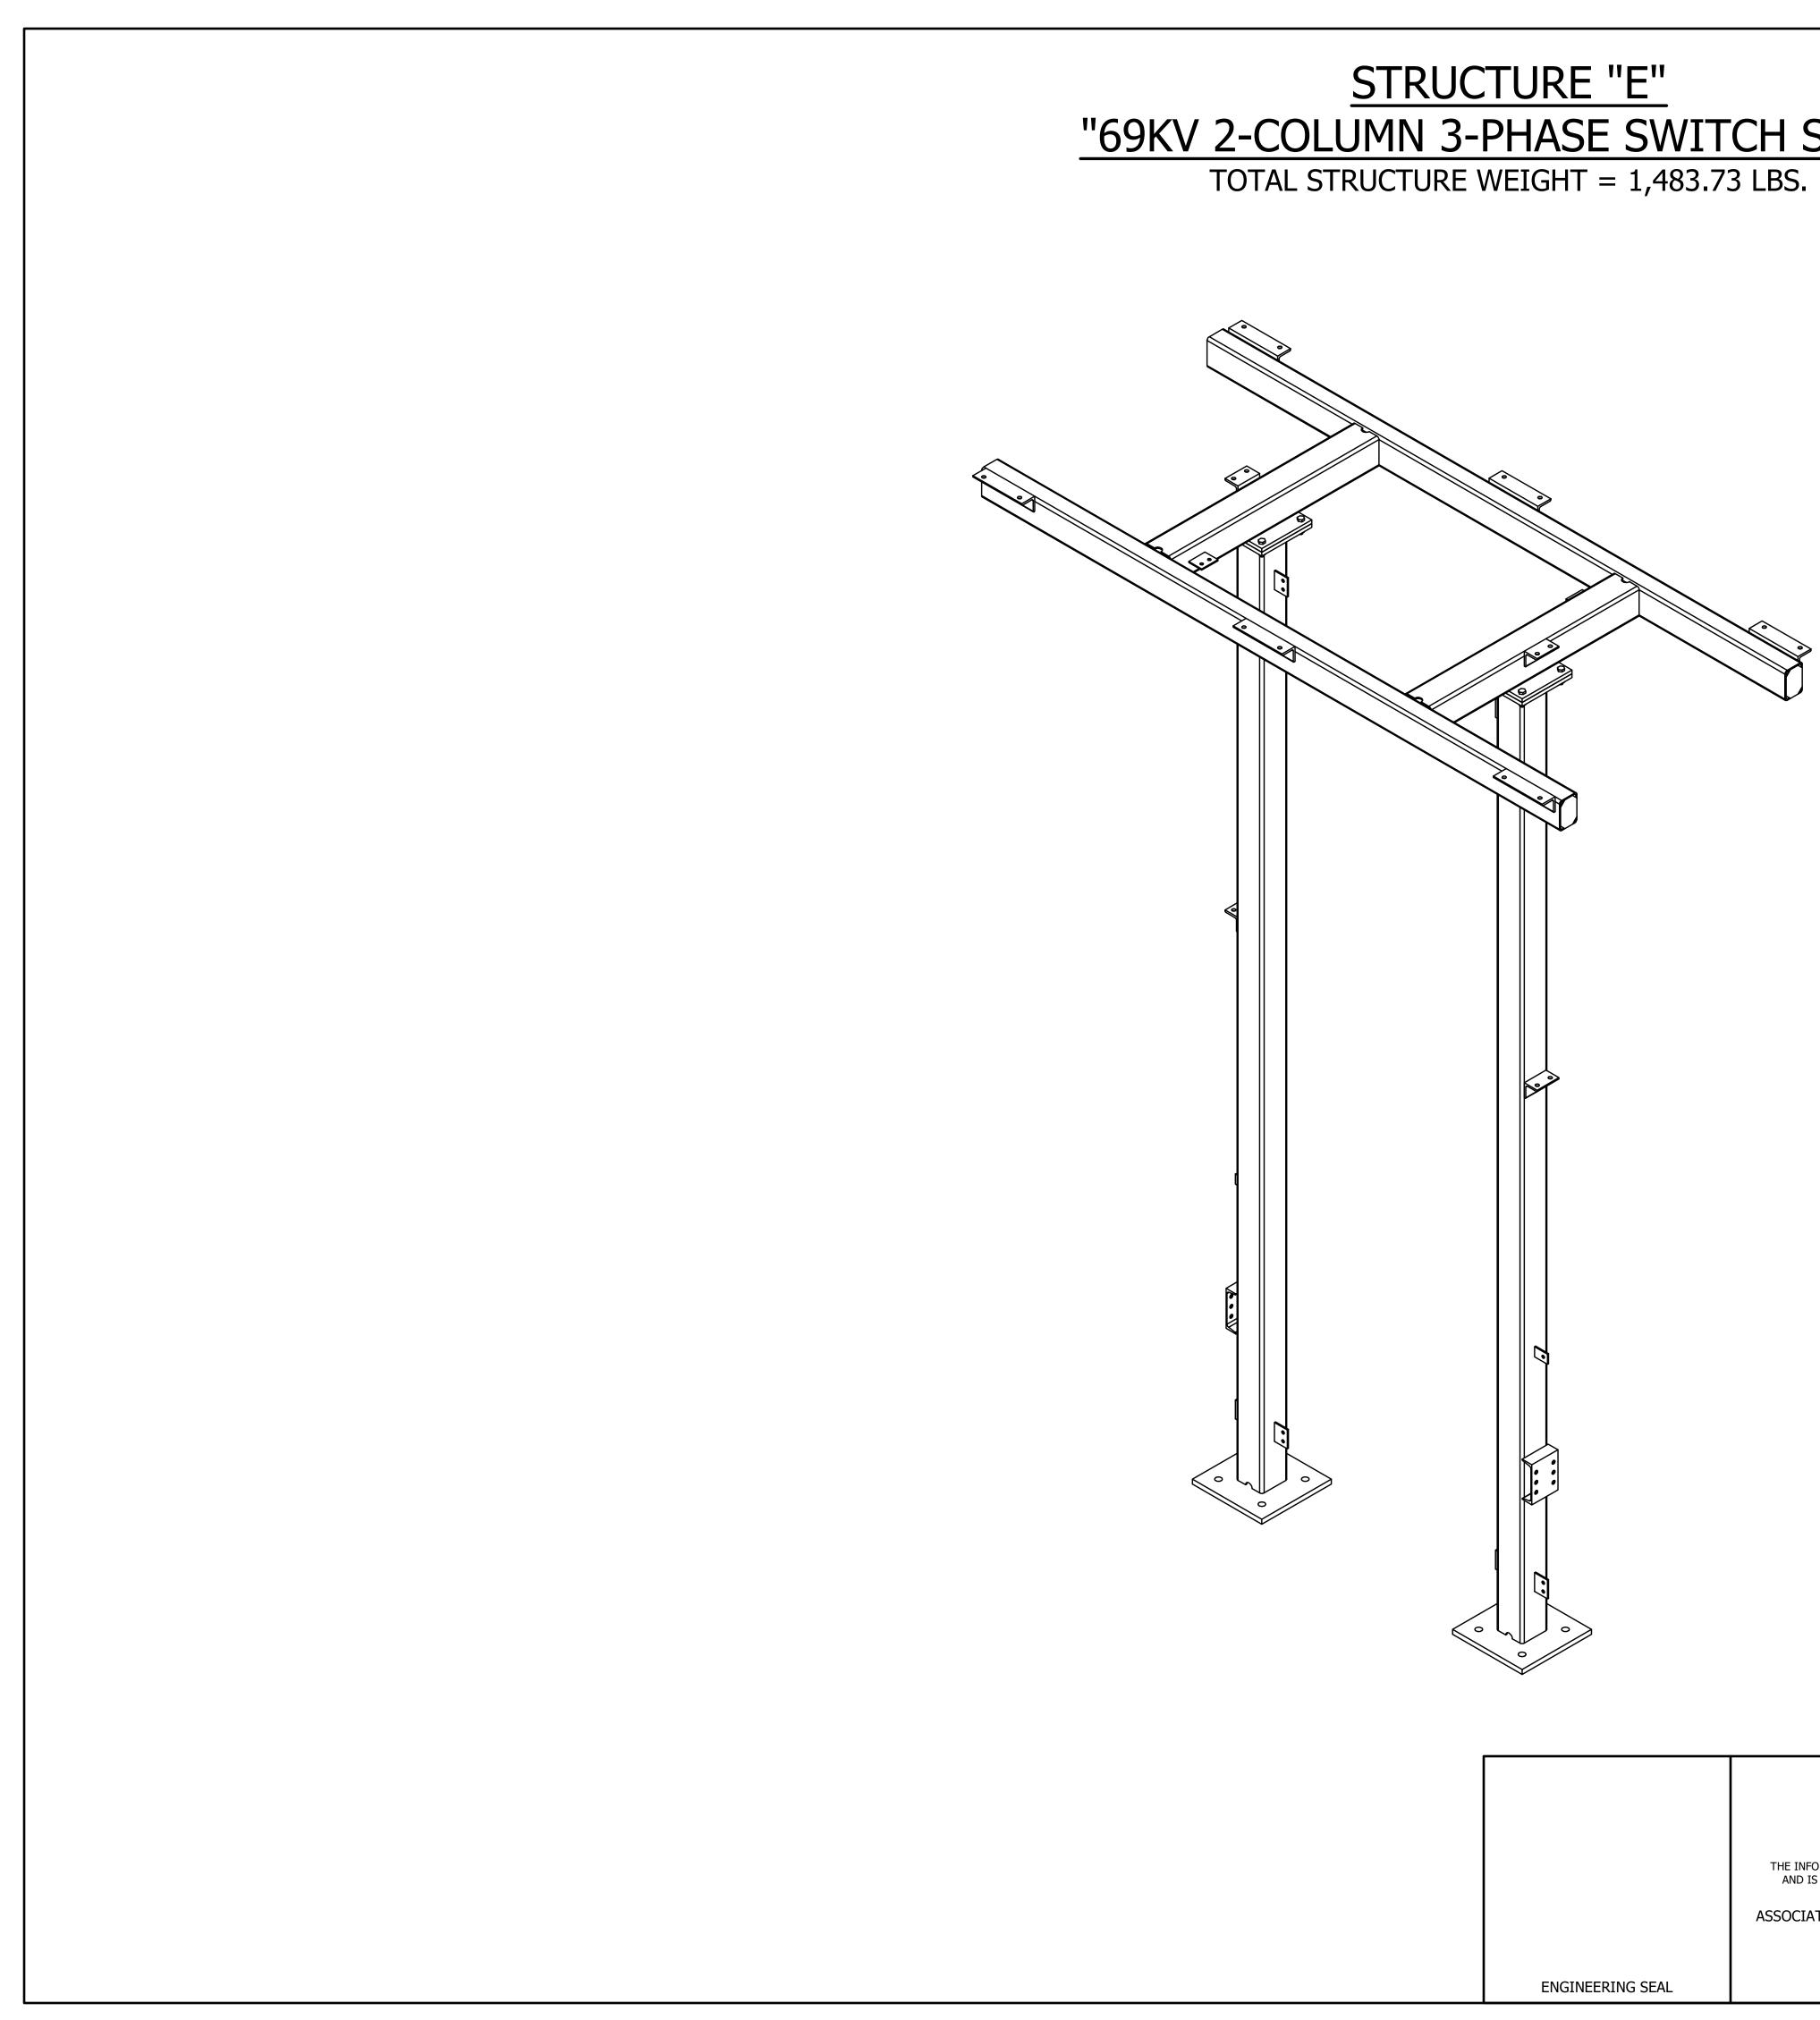


<u>"69KV 2-COLUMN 3-PHASE SWITCH STAND</u>

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			ANCHOR BOLTS
QTY	DIA	LENGTH	DECSRIPTION
8	1"	2'-6"	GALV ANCHOR BOLTS WITH 2 HHN AND 2 FW (F1554 GRADE 55)

<u>MAKE STRUCTURE "E"</u> <u>"12" - TIMES</u>

						REFER	RENCE	E DRAN	WING	5
					DRAWING NUMBER			DESC	CRIPTION	
					SE100	STRUCTURE "E" C	COVER SHE	ET		
					SE200	STRUCTURE "E" E	ELEVATION	IS		
					SE300	STRUCTURE "E" A	ASSEMBLIE	S & DETAILS	5 (BILL OF N	MATERIAL)
						- TITLE	59-12 STR.	.47 KV . E - C	deleware SUBS OVER	STATION SHEET
9/14/23	JRG	JKG	MR	ISSUED FOR CONSTRUC	TION	PROJECT NUMBER D 47019 SCALE		CHECKED	APPROVED MAR	DRAWING NUMBER
9/23/21	JLF	JKG	MR	ISSUE FOR BID		NTS AUBREY SILVEY				
7/28/21	JLF	CVC	MR	ISSUED FOR APPROVAL			C DIN	/ISION	• •	SOCIATED UBSTATION NGINEERING, INC.
DATE	DRN	СК	APP	DESCR	IPTION		vey.com/ep			www.aseng.com 770-537-0033

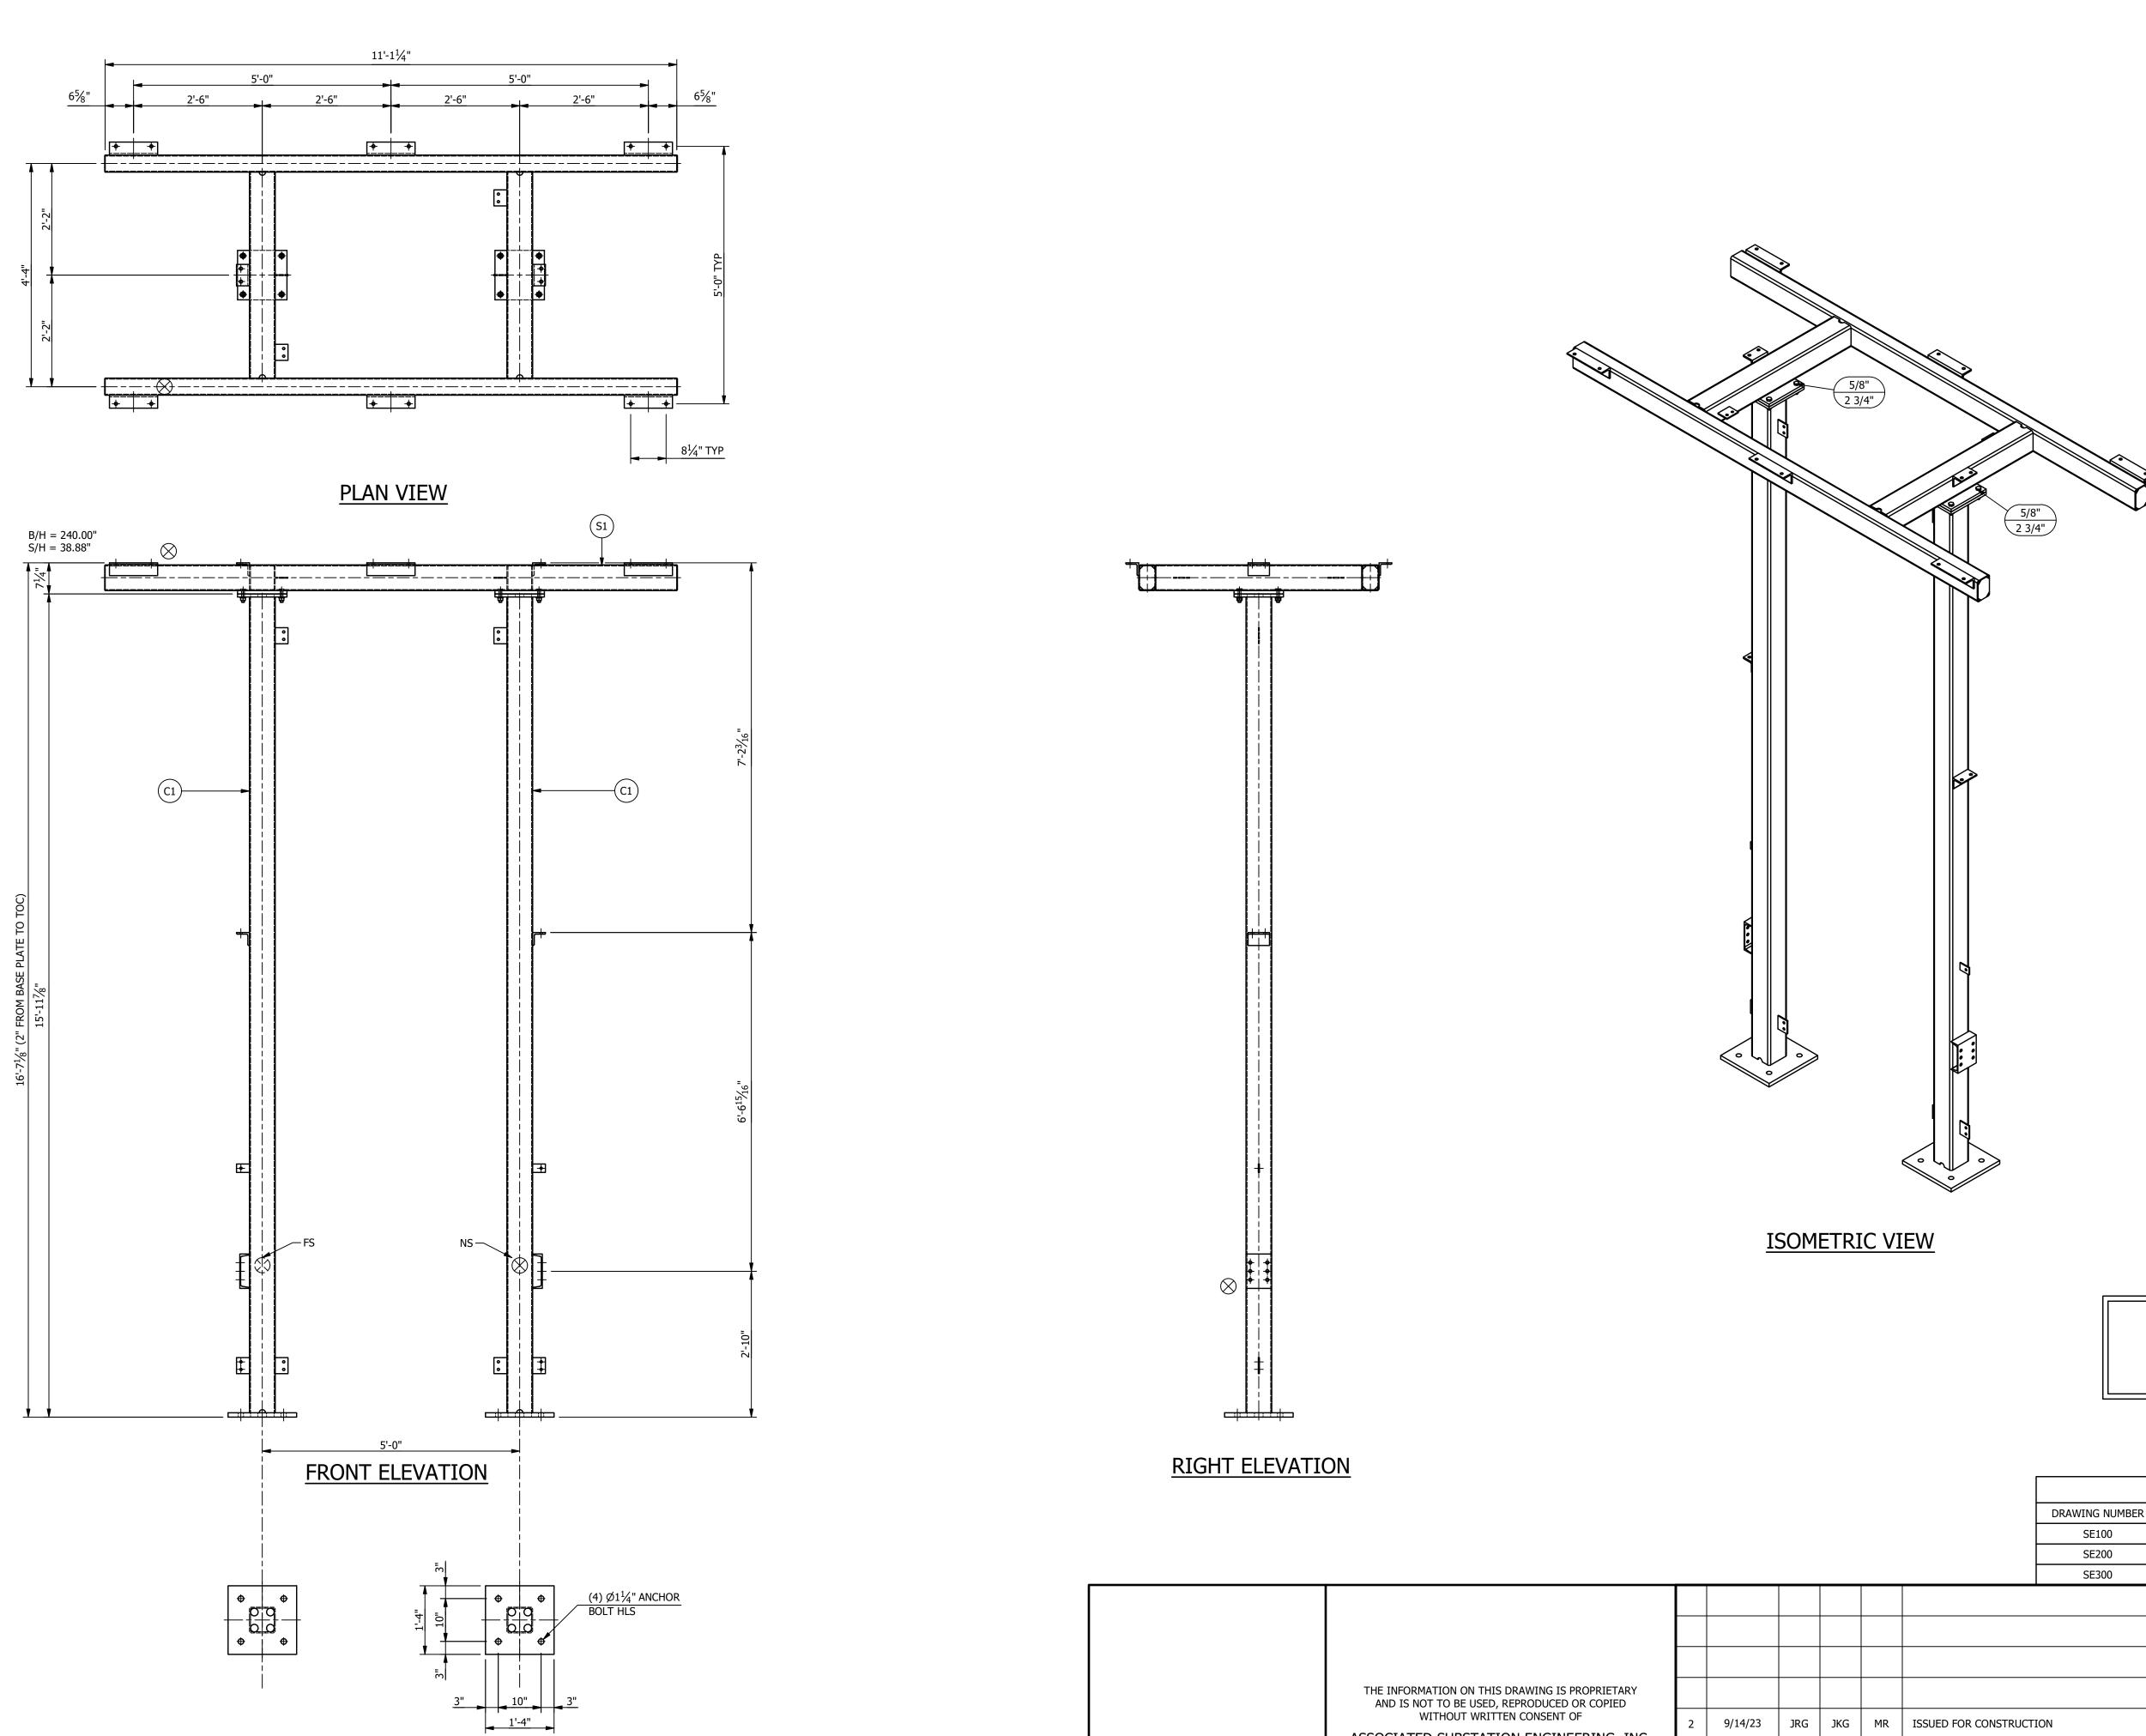

	THE INFORMATION ON THIS DRAWING IS PROPRIETARY AND IS NOT TO BE USED, REPRODUCED OR COPIED		
	WITHOUT WRITTEN CONSENT OF ASSOCIATED SUBSTATION ENGINEERING, INC.	2	
	ASSOCIATED SUBSTATION ENGINEERING, INC.	1	
		0	
ENGINEERING SEAL		REV	

ASSEMBLIES

- MARK QTY DESCRIPTION
- C1 2 COLUMN "C1"
- S1 1 SWITCH FRAME "S1"
- 5/8" 8 GALV A325 HHB W/ GALV F436 HARDENED FW & GALV A563-DH HHN
- X 2 N@TES:

1. ALL ASTM A36 OR A992/A572 GRADE-50 STEEL UNLESS NOTED. ALL TUBING - ASTM A500 GRADE B. ALL STRUCTURAL PIPE - ASTM A53 GRADE-B.

2. ASTM A325 ERECTION BOLTS. USE THE SHORTEST BOLT THAT WILL ALLOW A F436 FLAT WASHER AND A A563 NUT.

- 3. ALL HOT DIP GALVANIZED AFTER FABRICATION (ASTM A123).
- 4. ALL HOLES <u>Ø11/16"</u> FOR <u>Ø5/8"</u> BOLTS UNLESS NOTED.
- 5. MINIMUM EDGE DISTANCE 7/8" UNLESS NOTED.


6. PIECE MARK STAMPED INTO METAL WITH NOT LESS THAN 3/8" HIGH CHARACTERS BEFORE GALVANIZING.

7. ALL WELDING ELECTRODES SHALL BE E70XX.

8. \bigotimes MARK INDICATES PROPER ORIENTATION OF STRUCTURAL PIECES.

MAKE STRUCTURE "E" "12" - TIMES

						REFERENCE DRAWINGS
					DRAWING NUMBER	DESCRIPTION
					SE100	STRUCTURE "E" COVER SHEET
					SE200	STRUCTURE "E" ELEVATIONS
					SE300	STRUCTURE "E" ASSEMBLIES & DETAILS (BILL OF MATERIAL)
						CUSTOMER CITY OF DOVER DOVER, DELEWARE SUBSTATION 69 -12.47 KV SUBSTATION TITLE STR. E - ELEVATIONS PROJECT NUMBER
9/14/23	JRG	JKG	MR	ISSUED FOR CONSTRUCT	ION	47019 JLF JKG MAR SE200
9/23/21	JLF	JKG	MR	ISSUE FOR BID		AUBREY SILVEY ENTERPRISES, INC. SSOCIATED
7/28/21	JLF	CVC	MR	ISSUED FOR APPROVAL		Engineer • Procure • Construct
DATE	DRN	СК	APP	DESCRI	PTION	www.silvey.com/epc 770-537-1144

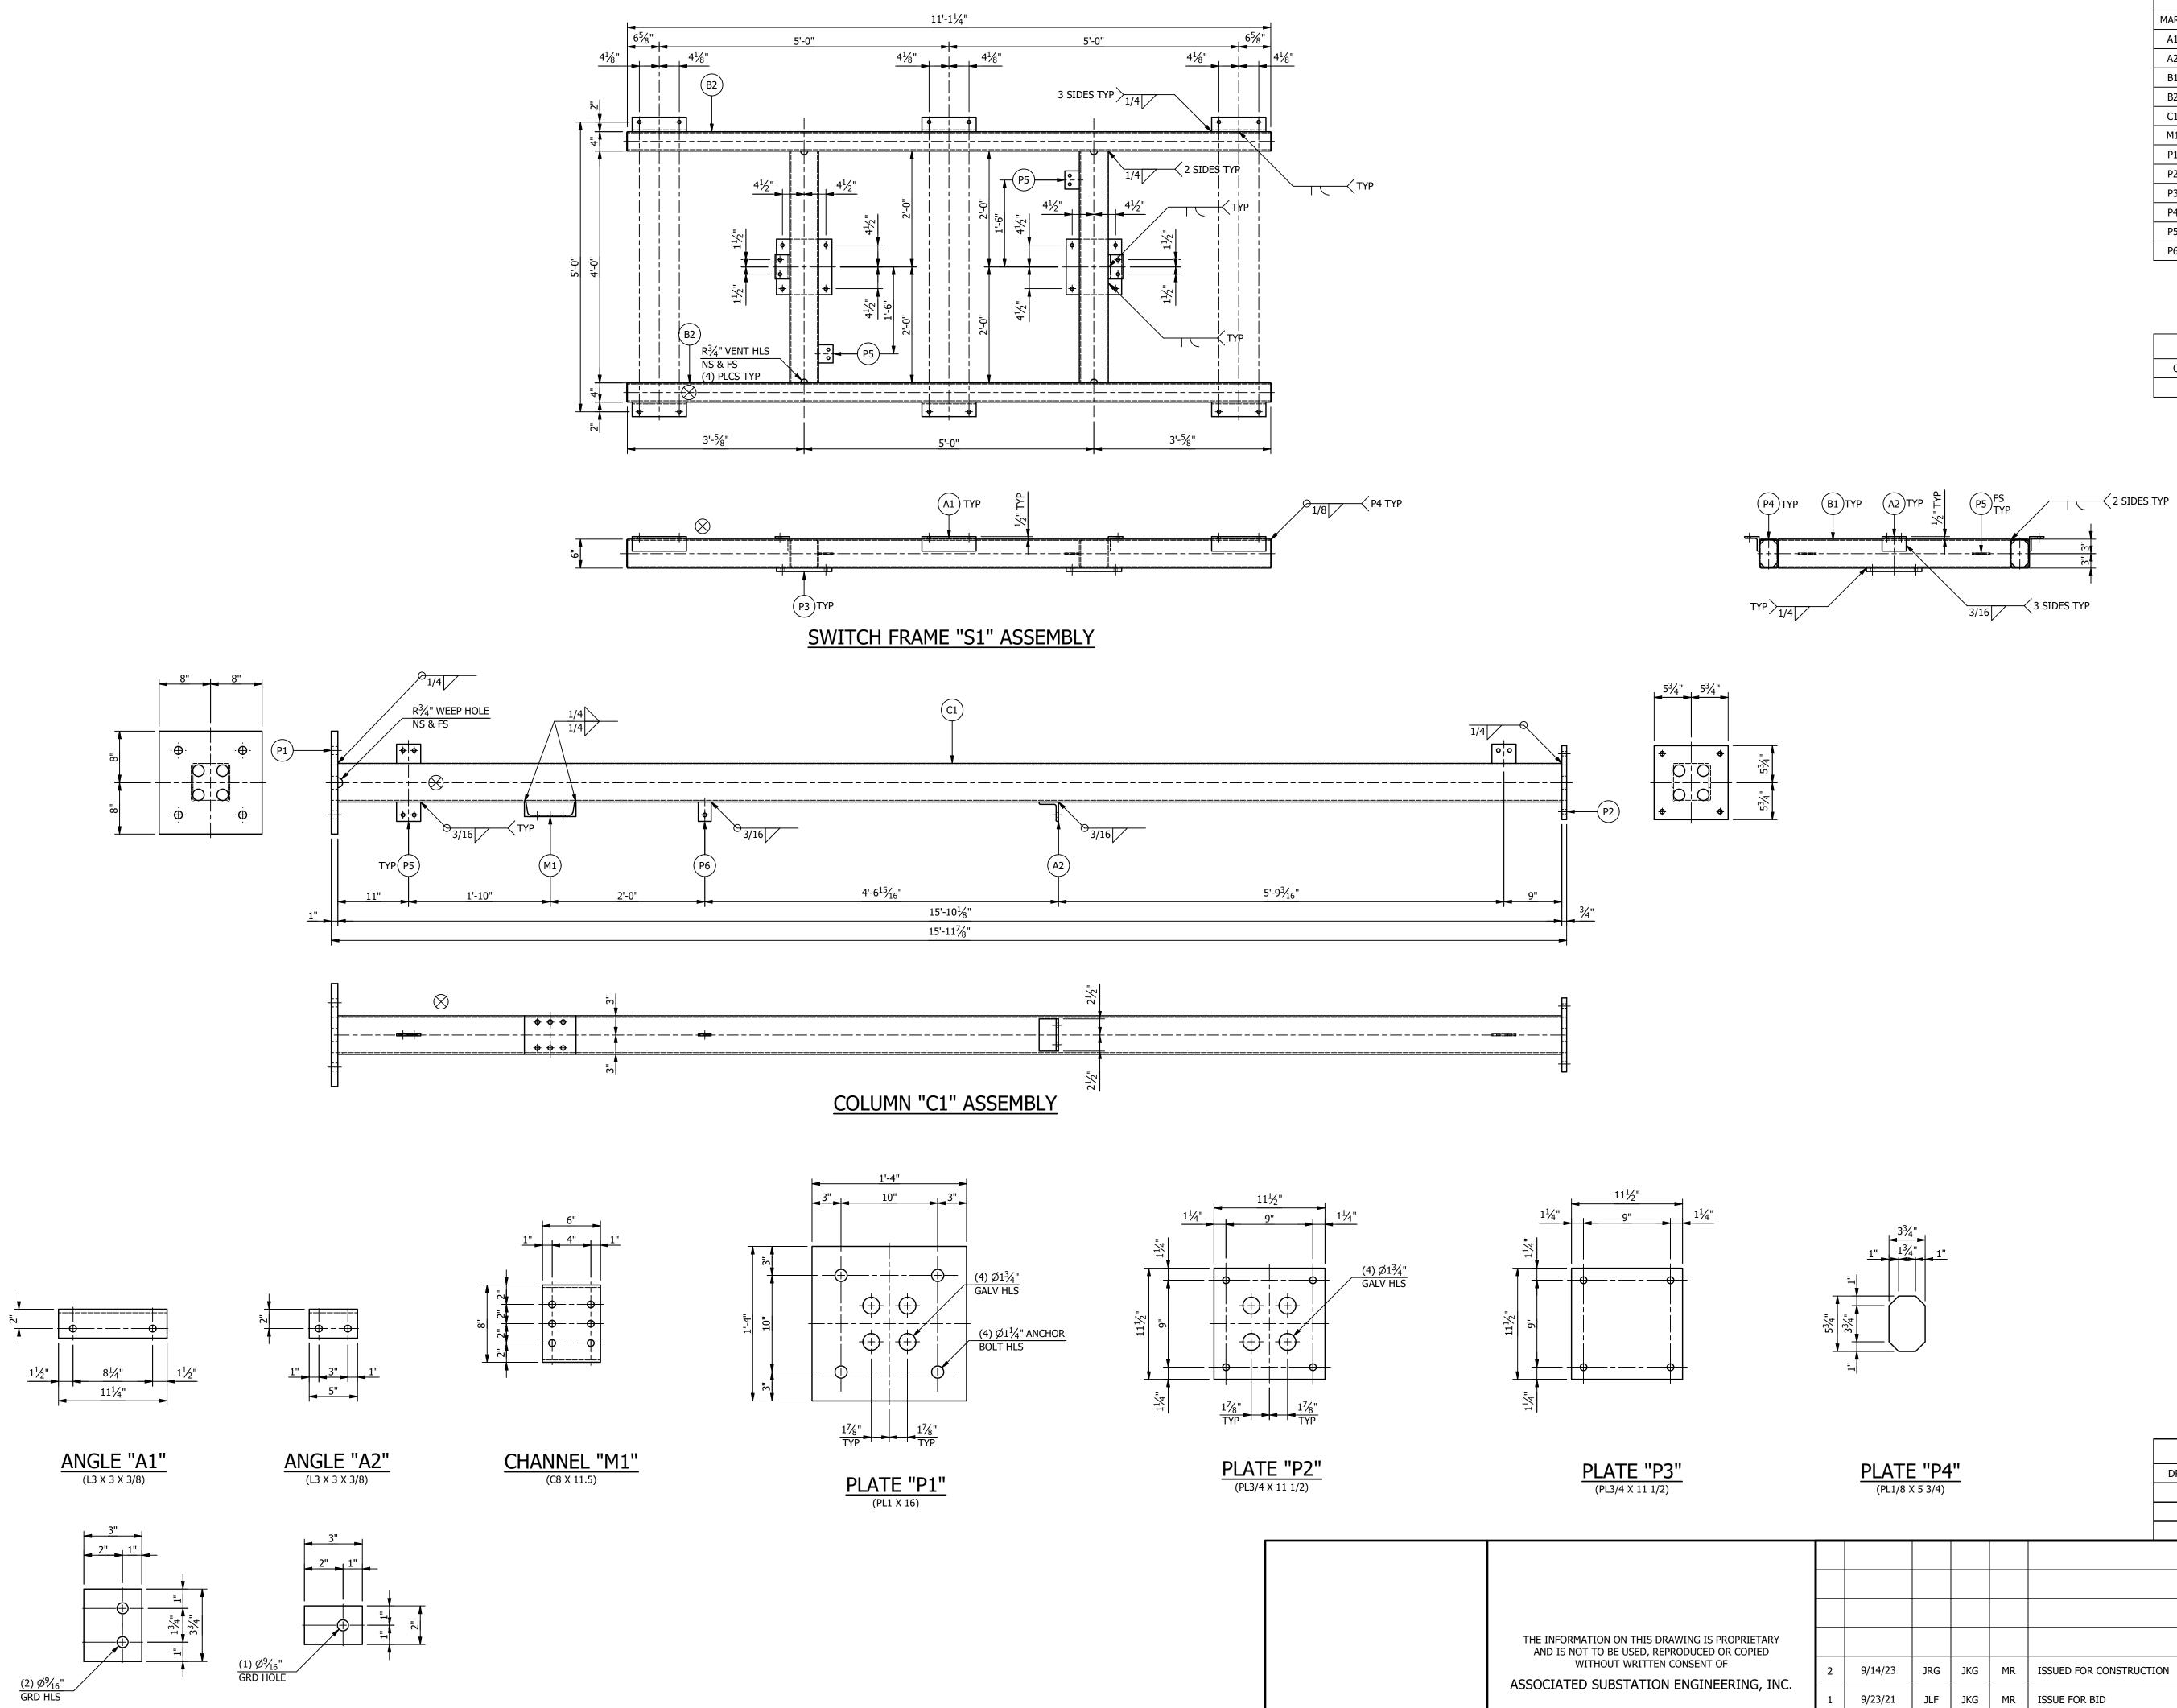

<u>PLATE "P5"</u> (PL1/4 X 3)

<u>PLATE "P6"</u> (PL1/4 X 3)

REV

ENGINEERING SEAL

	BILL OF MATERIAL								
MARK	QTY	DESCRIPTION	LENGTH	TOTAL WGT					
A1	6	L3 X 3 X 3/8	0'-11 1/4"	40.50					
A2	4	L3 X 3 X 3/8	0'-5"	12.00					
B1	2	HSS6 X 6 X 1/4	4'-0"	152.15					
B2	2	HSS4 X 6 X 1/4	11'-1 1/4"	346.79					
C1	2	HSS6 X 6 X 1/4	15'-10 1/8"	602.64					
M1	2	C8 X 11.5	0'-6"	11.50					
P1	2	PL1 X 16	1'-4"	145.19					
P2	2	PL3/4 X 11 1/2	0'-11 1/2"	56.25					
P3	2	PL3/4 X 11 1/2	0'-11 1/2"	56.25					
P4	4	PL1/8 X 5 3/4	0'-3 3/4"	3.06					
P5	8	PL1/4 X 3	0'-3 3/4"	6.38					
P6	2	PL1/4 X 3	0'-2"	.85					
			OTAL BLK WGT = TAL GALV WGT =						

	STRUCTURE BOLT ASSEMBLIES							
QTY	DIA	LENGTH	DESCRIPTION					
9	5/8"	2 3/4"	GALV A325 HHB W/ GALV F436 HARDENED FW & GALV A563-DH HHN					

SUFFIX ALL PIECE MARKS WITH "STRUCTURE DESIGNATION" THUS PIECE MARK XX BECOMES XXE

NOTES:

1. ALL ASTM A36 OR A992/A572 GRADE-50 STEEL UNLESS NOTED. ALL TUBING - ASTM A500 GRADE B. ALL STRUCTURAL PIPE - ASTM A53 GRADE-B.

2. ASTM A325 ERECTION BOLTS. USE THE SHORTEST BOLT THAT WILL ALLOW A F436 FLAT WASHER AND A A563 NUT.

3. ALL HOT DIP GALVANIZED AFTER FABRICATION (ASTM A123).

4. ALL HOLES <u>Ø11/16"</u> FOR <u>Ø5/8"</u> BOLTS UNLESS NOTED.

5. MINIMUM EDGE DISTANCE **7/8"** UNLESS NOTED.


6. PIECE MARK STAMPED INTO METAL WITH NOT LESS THAN 3/8" HIGH CHARACTERS BEFORE GALVANIZING.

7. ALL WELDING ELECTRODES SHALL BE E70XX.

8. \bigotimes MARK INDICATES PROPER ORIENTATION OF STRUCTURAL PIECES.


MAKE THIS SHEET <u>"12" - TIMES</u>

						REFERENCE DRAWINGS
PLATE "P4"					DRAWING NUMBER	DESCRIPTION
(PL1/8 >	X 5 3/4)	_			SE100	STRUCTURE "E" COVER SHEET
					SE200	STRUCTURE "E" ELEVATIONS
					SE300	STRUCTURE "E" ASSEMBLIES & DETAILS (BILL OF MATERIAL)
	· ·	· ·	· ·			CUSTOMER
	<u> </u>	<u> </u>	<u> </u>			CITY OF DOVER
						DOVER, DELEWARE
						SUBSTATION 69-12.47 KV SUBSTATION
						STR. E - ASSEMBLIES AND DETAILS
	├ ───┤	├ ───┤	├ ───┤	<u> </u>		PROJECT NUMBER DRAWN CHECKED APPROVED DRAWING NUMBER
9/14/23	JRG	JKG	MR	ISSUED FOR CONSTRUCT	ION	JILF JKG MAR SE300
9/23/21	JLF	JKG	MR	ISSUE FOR BID		NTS
	├ ───'	├ ────'	├ ───'	 		AUBREY SILVEY ENTERPRISES, INC. SSOCIATED
7/28/21	JLF	CVC	MR	ISSUED FOR APPROVAL		Engineer • Procure • Construct
DATE	DRN	СК	APP	DESCRIF	PTION	Engineer • Procure • Construct www.silvey.com/epc 770-537-1144

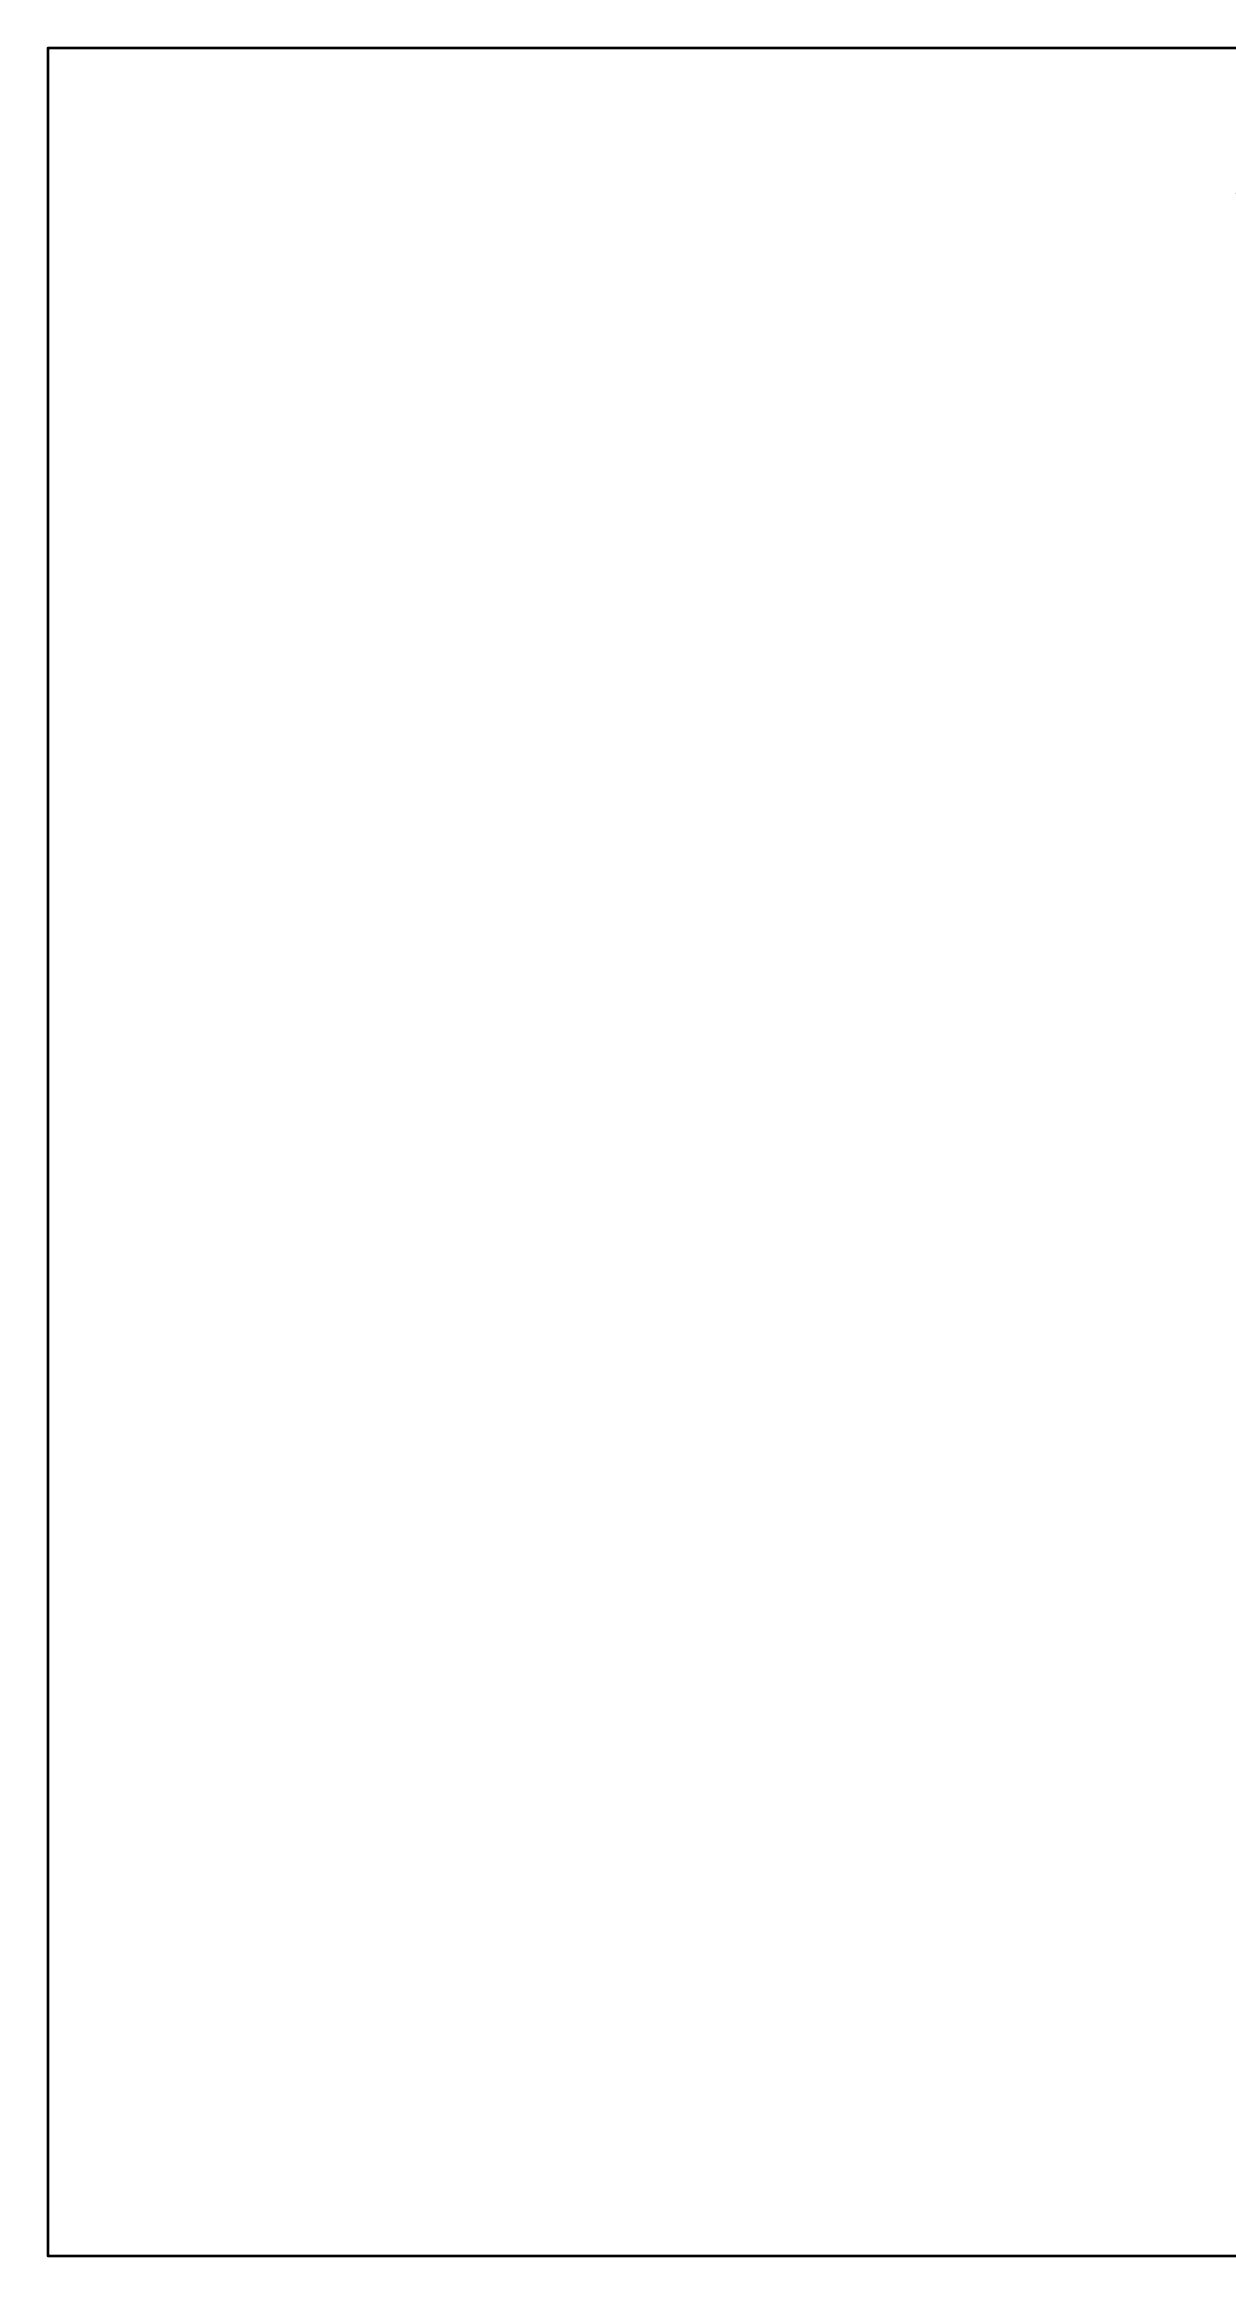

STRUCTURE "F" "69KV 1-COLUMN 2-PHASE BUS SUPPORT"

TOTAL STRUCTURE WEIGHT = 456.51

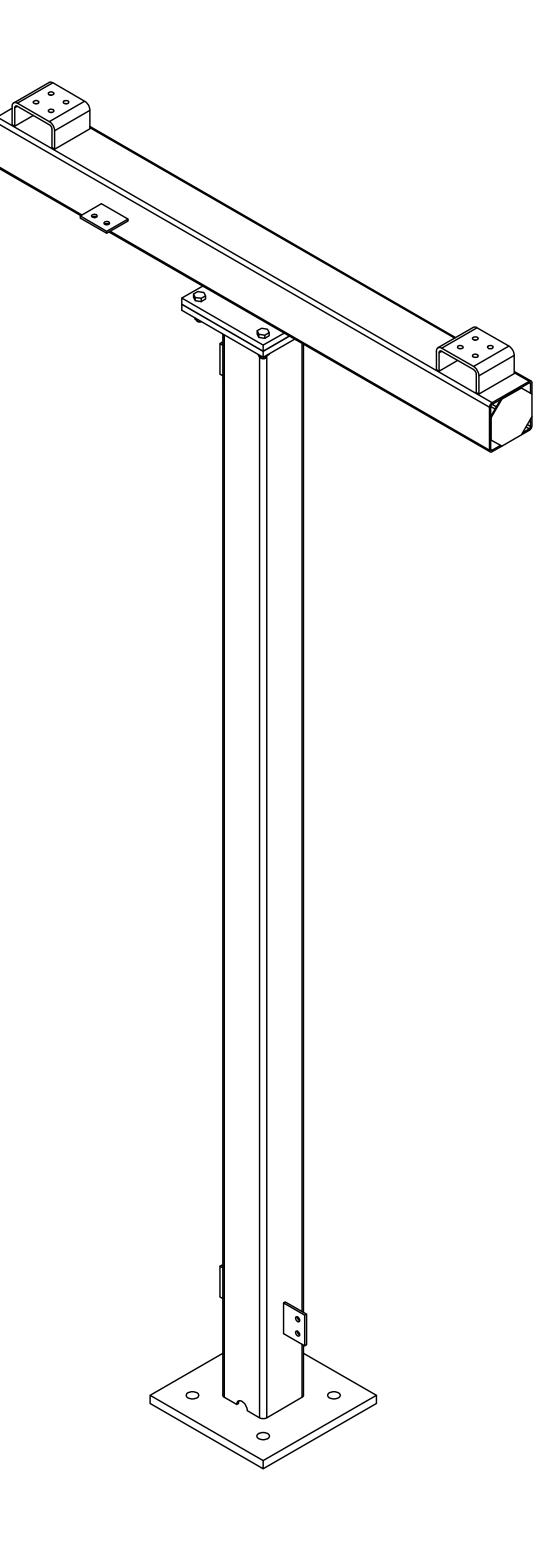

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 ASSOCIATED SUBSTATION ENGINEERING, INC.

 I


 0

 ENGINEERING SEAL


			ANCHOR BOLTS
QTY	DIA	LENGTH	DECSRIPTION
4	1"	2'-6"	GALV ANCHOR BOLTS WITH 2 HHN AND 2 FW (F1554 GRADE 55)


<u>MAKE STRUCTURE "F"</u> <u>"1" - TIME</u>


						REFE	RENC	E DRAN	WING	5
					DRAWING NUMBER			DESC	RIPTION	
					SF100	STRUCTURE "F"	' COVER SHE	EET		
					SF200	STRUCTURE "F"	' ELEVATION	١S		
					SF300	STRUCTURE "F"	' ASSEMBLIE	S & DETAILS	6 (BILL OF N	1ATERIAL)
						CUSTOMER SUBSTATION TITLE	69-12	.47 KV	VER, DE	/ER STATION SHEET
9/14/23	JRG	JKG	MR	ISSUED FOR CONSTRUCTI	ION	PROJECT NUMBER 47019 SCALE		CHECKED	APPROVED MAR	DRAWING NUMBER
9/23/21	JLF	JKG	MR	ISSUE FOR BID		NTS AUBREY SILV				SOCIATED
7/28/21	JLF	CVC	MR	ISSUED FOR APPROVAL				VISION		UBSTATION
DATE	DRN	СК	APP	DESCRIF	PTION		silvey.com/ep			www.aseng.com 770-537-0033

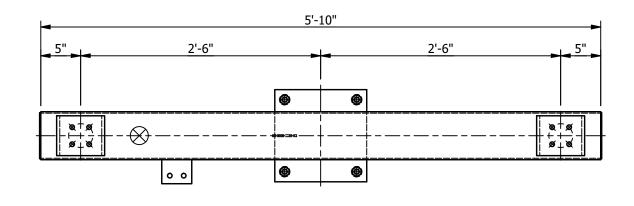

PLAN VIEW

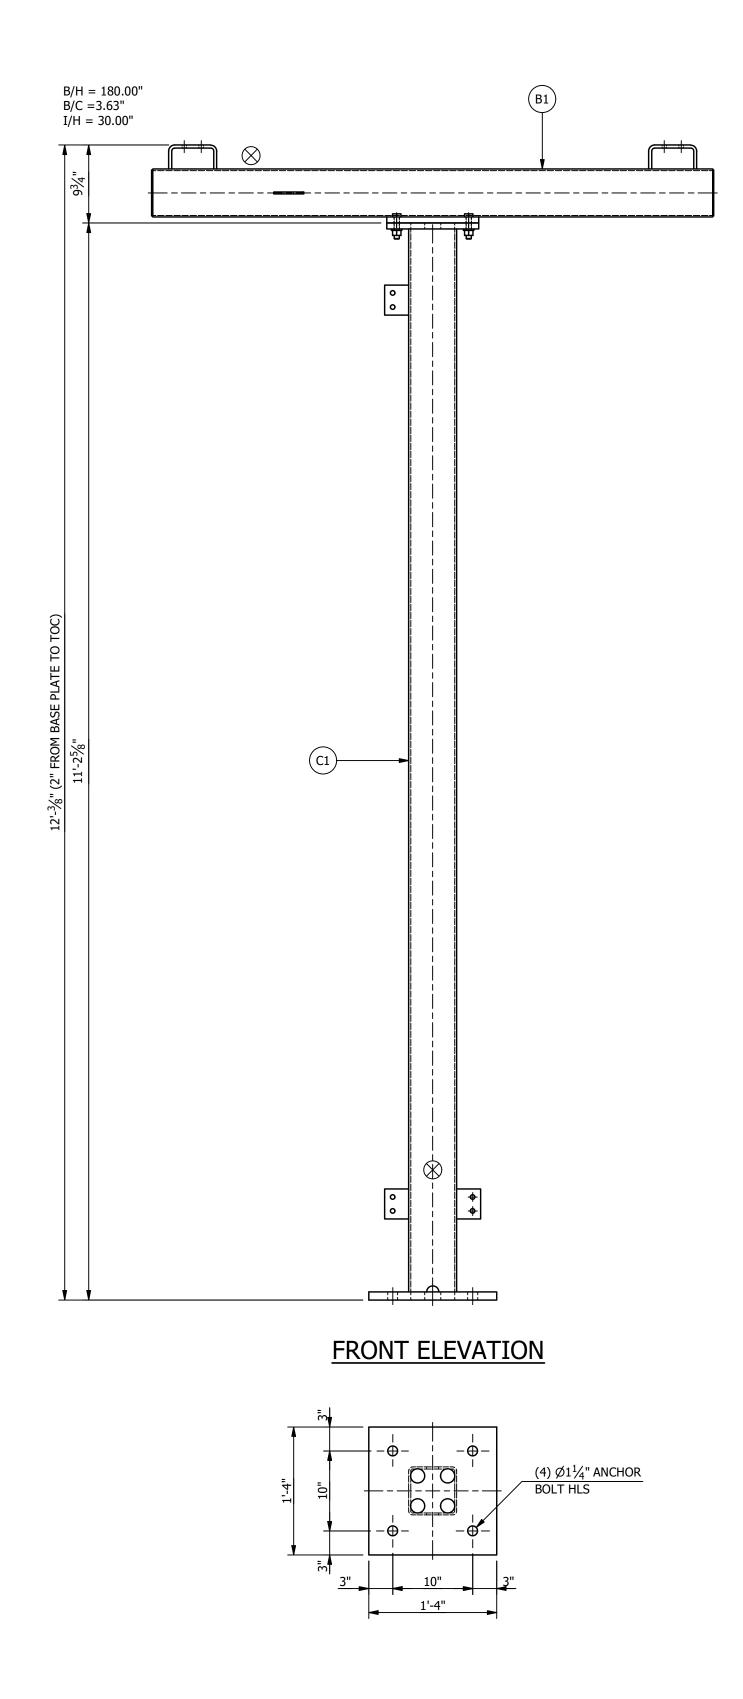

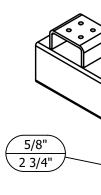

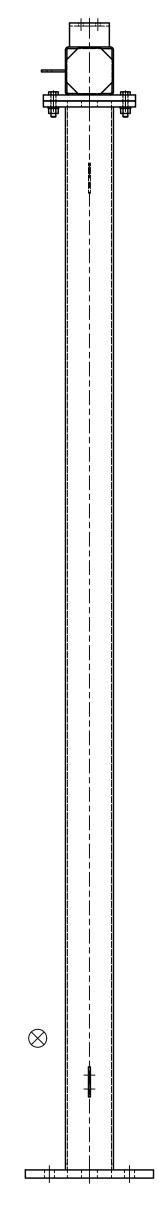

RIGHT ELEVATION

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	WITHOUT WRITTEN CONSENT OF	2
	ASSOCIATED SUBSTATION ENGINEERING, INC.	1
		-
		0
ENGINEERING SEAL		REV

ASSEMBLIES

- DESCRIPTION
- B1
 1
 BEAM "B1"

 C1
 1
 COLUMN "C1"

NOTES:

MARK QTY

1. ALL ASTM A36 OR A992/A572 GRADE-50 STEEL UNLESS NOTED. ALL TUBING - ASTM A500 GRADE B. ALL STRUCTURAL PIPE - ASTM A53 GRADE-B.

2. ASTM A325 ERECTION BOLTS. USE THE SHORTEST BOLT THAT WILL ALLOW A F436 FLAT WASHER AND A A563 NUT.

3. ALL HOT DIP GALVANIZED AFTER FABRICATION (ASTM A123).


4. ALL HOLES <u>Ø11/16"</u> FOR <u>Ø5/8"</u> BOLTS UNLESS NOTED.

5. MINIMUM EDGE DISTANCE **<u>7/8"</u>** UNLESS NOTED.

6. PIECE MARK STAMPED INTO METAL WITH NOT LESS THAN 3/8" HIGH CHARACTERS BEFORE GALVANIZING.

7. ALL WELDING ELECTRODES SHALL BE E70XX.


8. \bigotimes MARK INDICATES PROPER ORIENTATION OF STRUCTURAL PIECES.

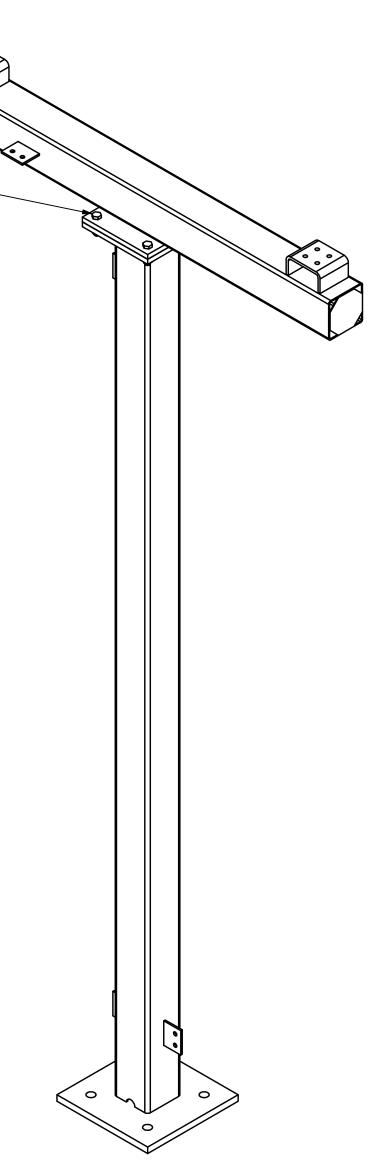


ISOMETRIC VIEW


MAKE STRUCTURE "F"
"1" - TIME

					REFERENCE DRAWINGS				
						DRAWING NUMBER	DESCRIPTION		
						SF100	STRUCTURE "F" COVER SHEET		
						SF200	STRUCTURE "F" ELEVATIONS		
						SF300	STRUCTURE "F" ASSEMBLIES & DETAILS (BILL OF MATERIAL)		
							CUSTOMER CITY OF DOVER DOVER, DE SUBSTATION 69-12.47 KV SUBSTATION		
							STR. F - ELEVATIONS		
2	9/14/23	JRG	JKG	MR	ISSUED FOR CONSTRUCTI	ION	PROJECT NUMBER 47019 SCALE JLF CVC MAR SF200		
1	9/23/21	JLF	JKG	MR	ISSUE FOR BID		AUBREY SILVEY ENTERPRISES, INC.		
0	7/28/21	JLF	CVC	MR	ISSUED FOR APPROVAL		Engineer • Procure • Construct		
EV	DATE	DRN	СК	APP	DESCRIF	PTION	www.silvey.com/epc 770-537-1144 www.aseng.com 770-537-0033		

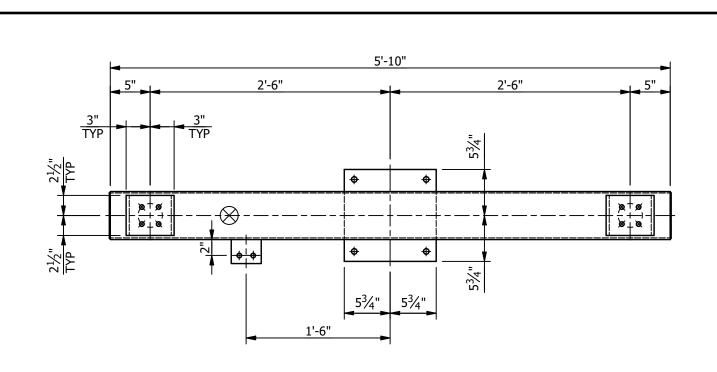

1/4

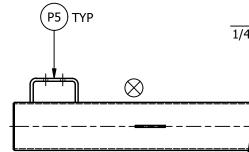

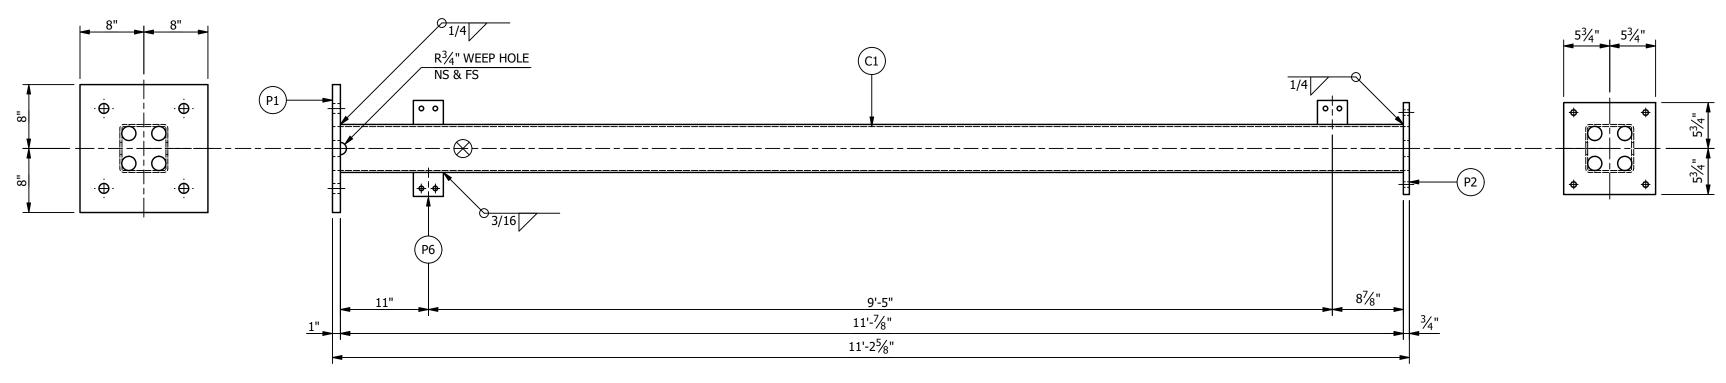

BEAM "B1" ASSEMBLY


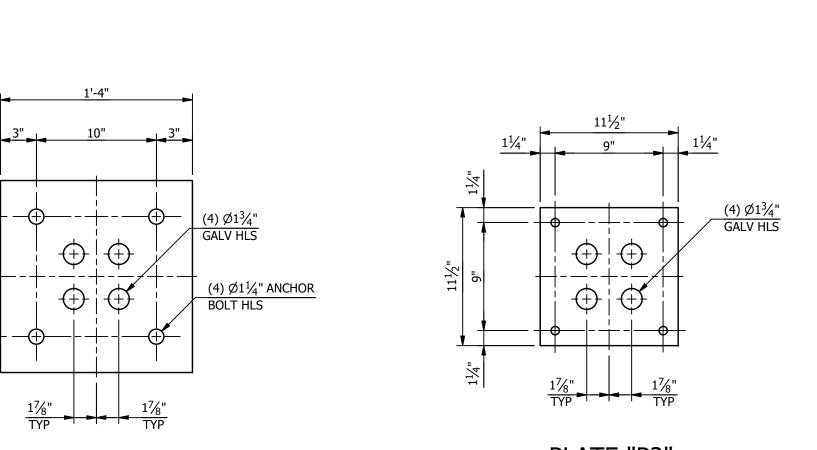


PLATE "P2" (PL3/4 X 11 1/2)

PLATE "P1" (PL1 X 16)

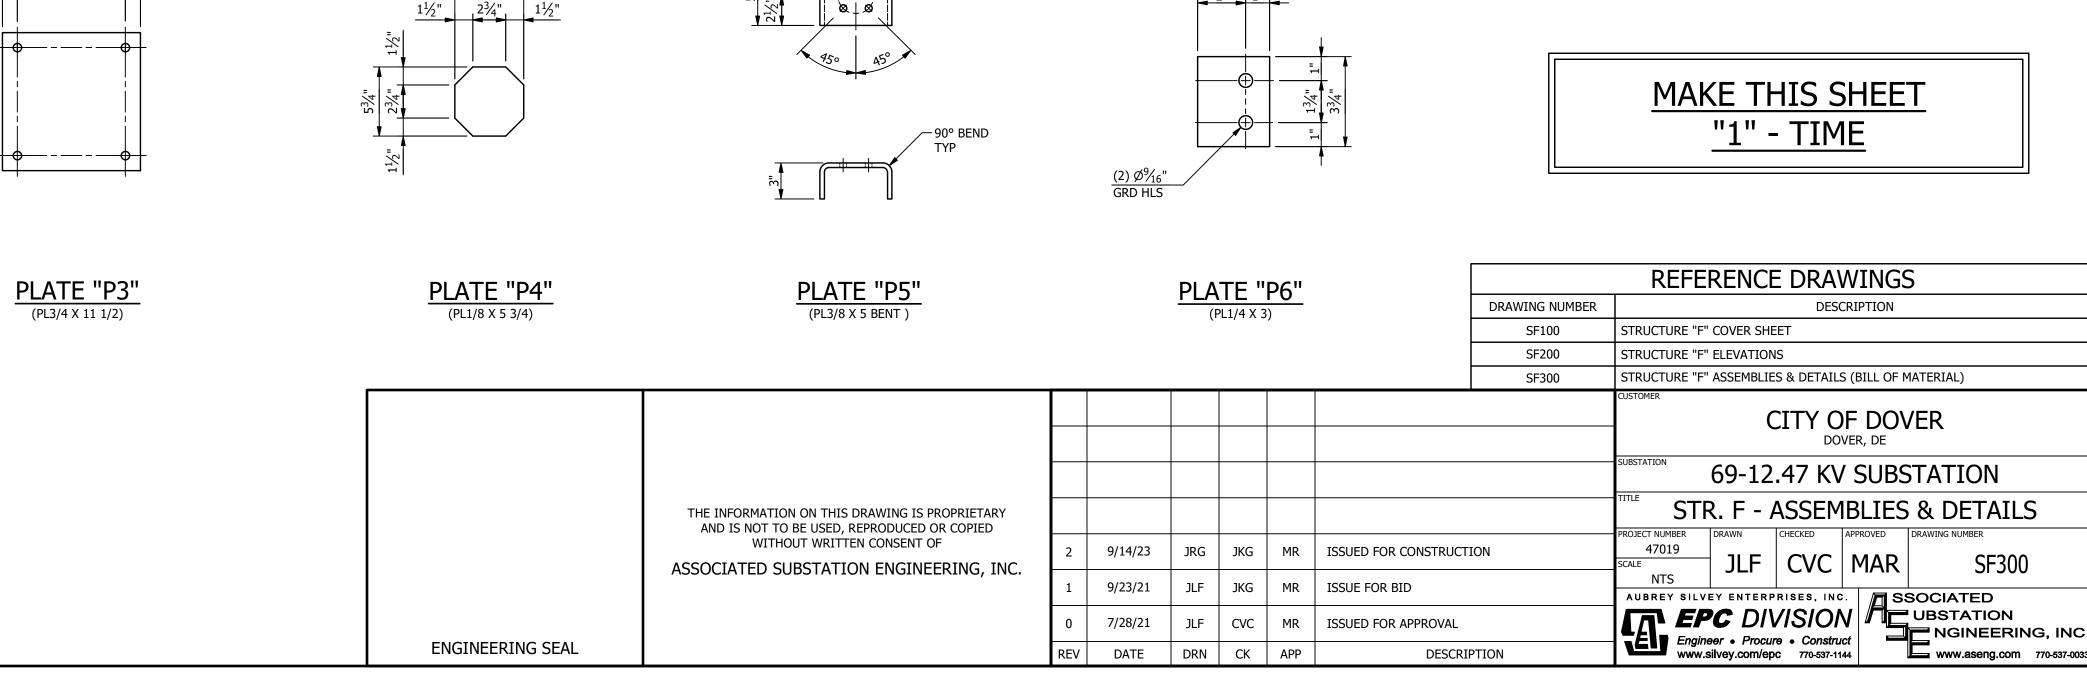


(4) Ø⁹/₁₆" HLS ON 3" BC 90° APART TYP

COLUMN "C1" ASSEMBLY

111/2"

 $1\frac{1}{4}$

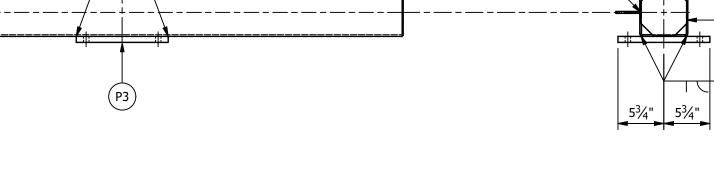

TYP

 $\mathsf{TYP} > \frac{1/4}{1/4}$

BILL OF MATERIAL								
MARK	QTY	DESCRIPTION	LENGTH	TOTAL WGT				
B1	1	HSS6 X 6 X 3/16	5'-10"	84.73				
C1	1	HSS6 X 6 X 1/4	11'-7/8"	210.59				
P1	1	PL1 X 16	1'-4"	72.59				
P2	1	PL3/4 X 11 1/2	0'-11 1/2"	28.13				
P3	1	PL3/4 X 11 1/2	0'-11 1/2"	28.13				
P4	2	PL1/8 X 5 3/4	0'-5 3/4"	2.34				
P5	2	PL3/8 X 5 BENT	0'-10 11/16"	11.36				
P6	4	PL1/4 X 3	0'-3 3/4"	3.19				
			TOTAL BLK WG TOTAL GALV WG	T = 441.07 LBS. T = 456.51 LBS.				

STRUCTURE BOLT ASSEMBLIES						
QTY	DIA	LENGTH	DESCRIPTION			
5	5/8"	2 3/4"	GALV A325 HHB W/ GALV F436 HARDENED FW & GALV A563-DH HHN			

SUFFIX ALL PIECE MARKS WITH "STRUCTURE DESIGNATION" THUS PIECE MARK XX BECOMES XXF

NOTES:

1. ALL ASTM A36 OR A992/A572 GRADE-50 STEEL UNLESS NOTED. ALL TUBING - ASTM A500 GRADE B. ALL STRUCTURAL PIPE - ASTM A53 GRADE-B.

2. ASTM A325 ERECTION BOLTS. USE THE SHORTEST BOLT THAT WILL ALLOW A F436 FLAT WASHER AND A A563 NUT.

3. ALL HOT DIP GALVANIZED AFTER FABRICATION (ASTM A123).


4. ALL HOLES <u>Ø11/16"</u> FOR <u>Ø5/8"</u> BOLTS UNLESS NOTED.

5. MINIMUM EDGE DISTANCE **<u>7/8</u>"** UNLESS NOTED.

6. PIECE MARK STAMPED INTO METAL WITH NOT LESS THAN 3/8" HIGH CHARACTERS BEFORE GALVANIZING.

7. ALL WELDING ELECTRODES SHALL BE E70XX.

PLATE "P6"									
	-	PL1/4 X 3			DRAWING NUMBER	DESCRIPTION			
					SF100	STRUCTURE "F" COVER SHEET			
					SF200	STRUCTURE "F" ELEVATIONS			
					SF300	STRUCTURE "F" ASSEMBLIES & DETAILS (BILL OF MATERIAL)			
						CUSTOMER CITY OF DOVER DOVER, DE SUBSTATION 69-12.47 KV SUBSTATION TITLE STR. F - ASSEMBLIES & DETAILS			
9/14/23	JRG	JKG	MR	ISSUED FOR CONSTRUCT	ION	PROJECT NUMBER 47019 SCALE JLF CVC MAR SF300			
9/23/21	JLF	JKG	MR	ISSUE FOR BID		AUBREY SILVEY ENTERPRISES, INC.			
7/28/21	JLF	CVC	MR	ISSUED FOR APPROVAL		AUBREY SILVEY ENTERPRISES, INC. Engineer • Procure • Construct www.silvey.com/epc 770-537-1144			
DATE	DRN	СК	APP	DESCRI	PTION	www.silvey.com/epc 770-537-1144			

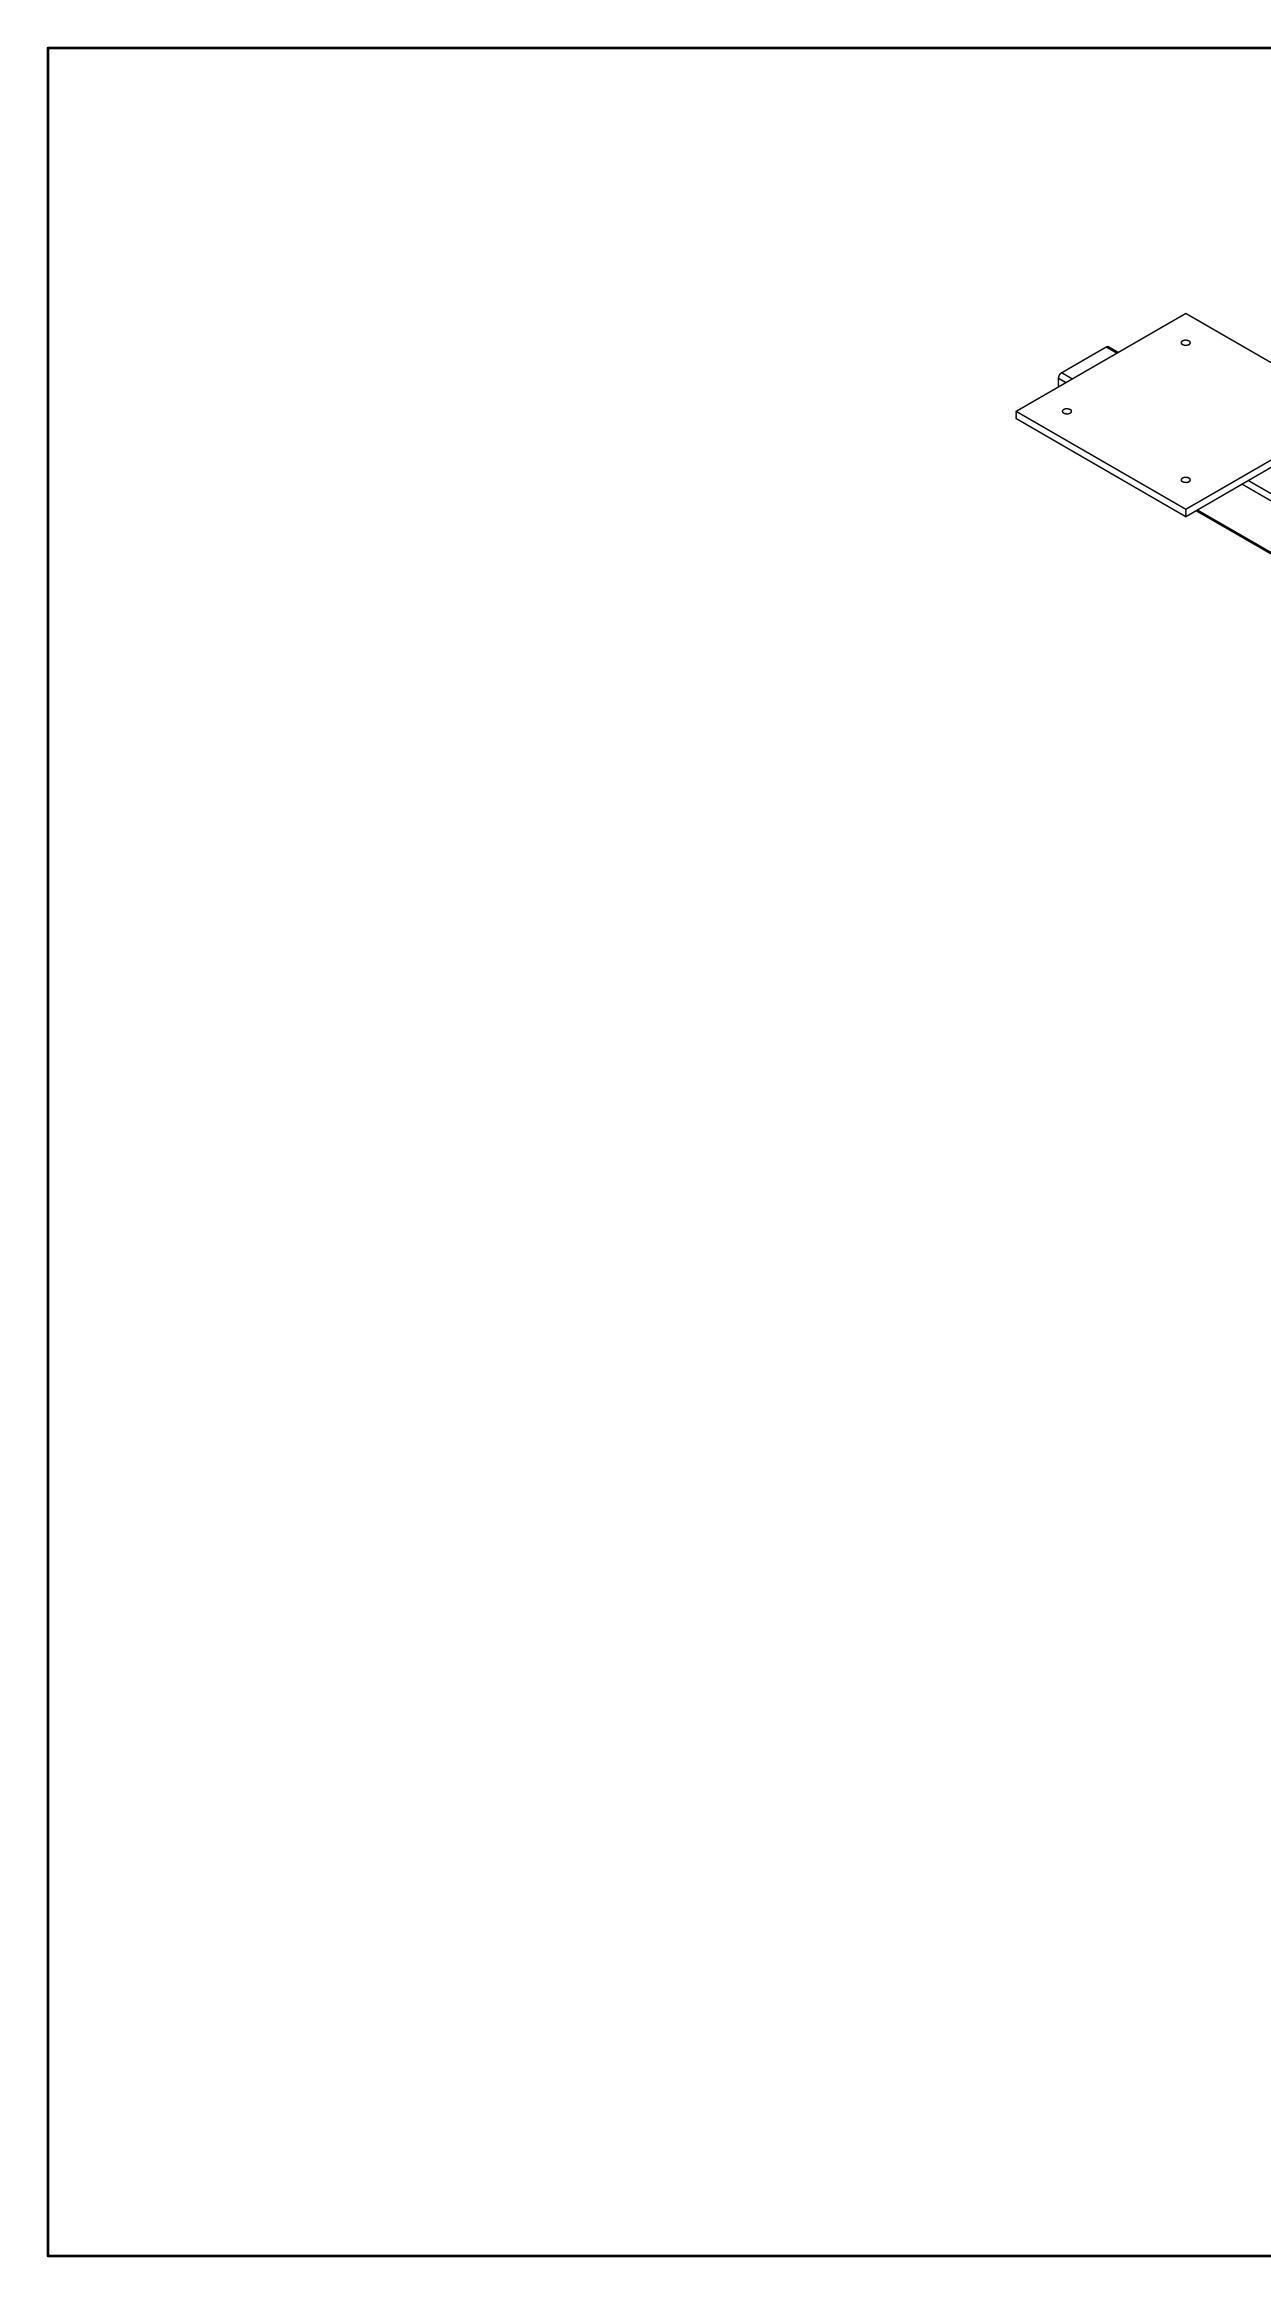

STRUCTURE "G" "69KV 1-COLUMN METERING STAND"


TOTAL STRUCTURE WEIGHT = 756.72 LBS.


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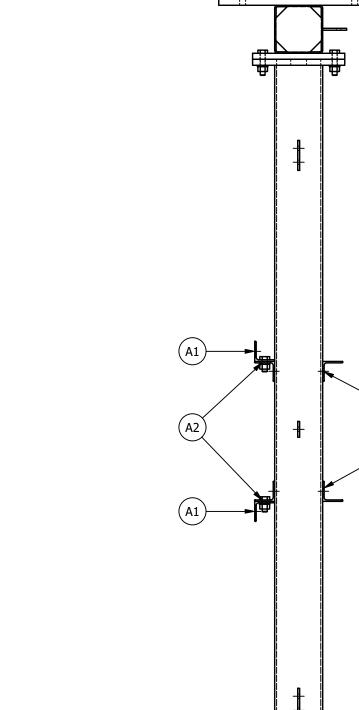
			ANCHOR BOLTS
QTY	DIA	LENGTH	DECSRIPTION
4	1"	2'-6"	GALV ANCHOR BOLTS WITH 2 HHN AND 2 FW (F1554 GRADE 55)

<u>MAKE STRUCTURE "G"</u> <u>"1" - TIME</u>

					REFERENCE DRAWINGS			
					DRAWING NUMBER	DESCRIPTION		
					SG100	STRUCTURE "G" COVER SHEET		
					SG200	STRUCTURE "G" ELEVATIONS		
					SG300	STRUCTURE "G" ASSEMBLIES & DETAILS (BILL OF MATERIAL)		
						CUSTOMER CITY OF DOVER DOVER, DE SUBSTATION 69-12.47KV SUBSTATION TITLE STR. G - COVER SHEET		
9/14/23	JRG	JKG	MR	ISSUED FOR CONSTRUCT	ION	PROJECT NUMBER 47019 SCALE JLF CVC MAR SG100		
9/23/21	JLF	JKG	MR	ISSUE FOR BID		AUBREY SILVEY ENTERPRISES, INC. I SSOCIATED		
7/28/21	JLF	CVC	MR	ISSUED FOR APPROVAL		Engineer • Procure • Construct		
DATE	DRN	СК	APP	DESCRIF	PTION	www.silvey.com/epc 770-537-1144 www.aseng.com 770-537-0033		



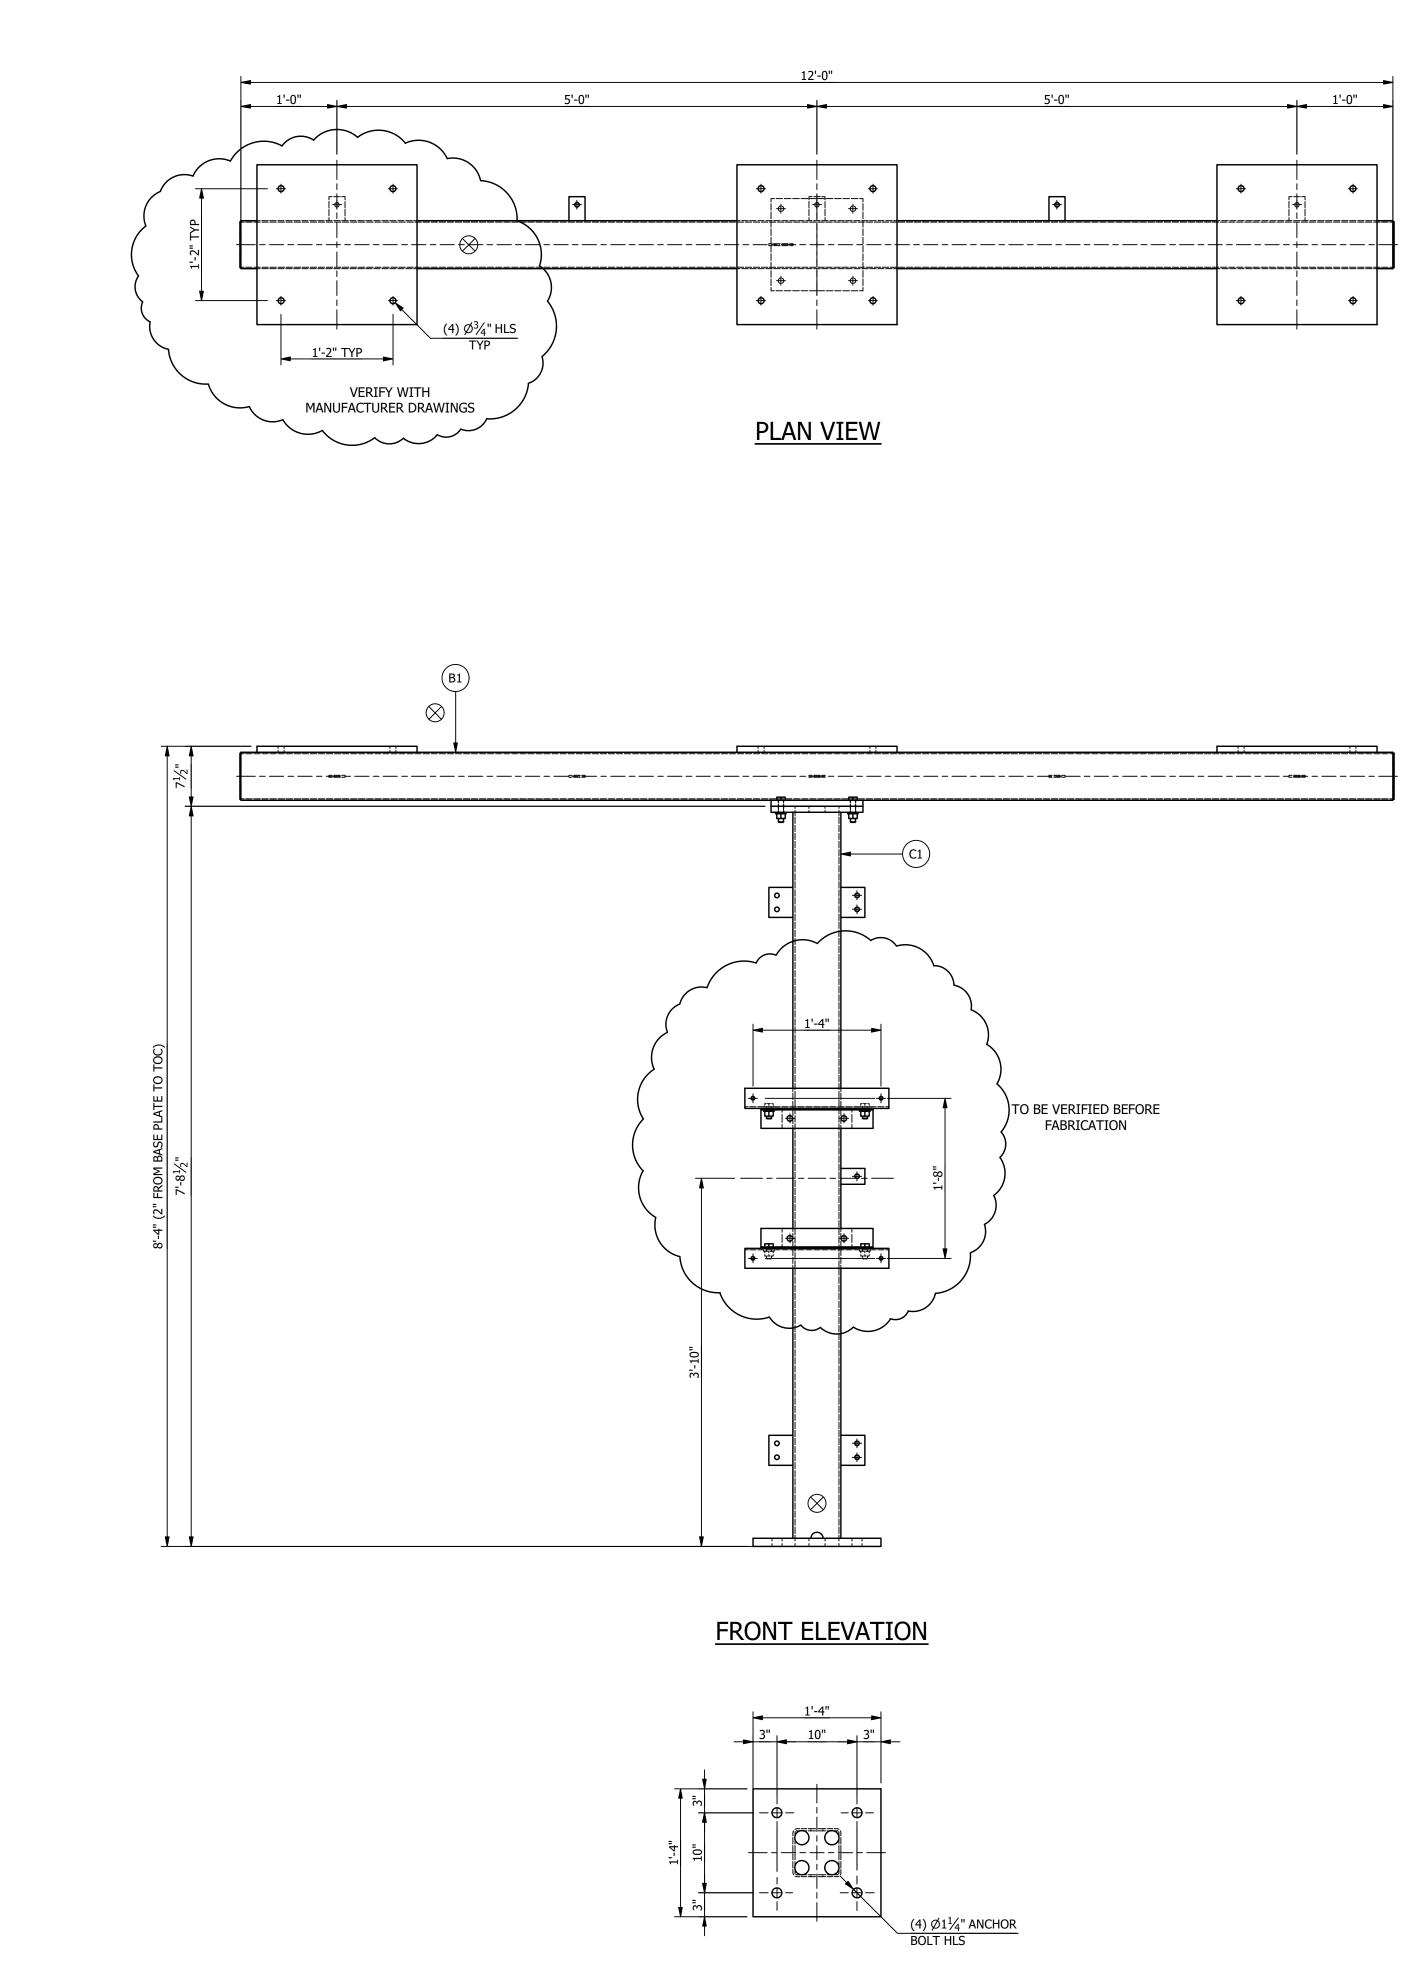

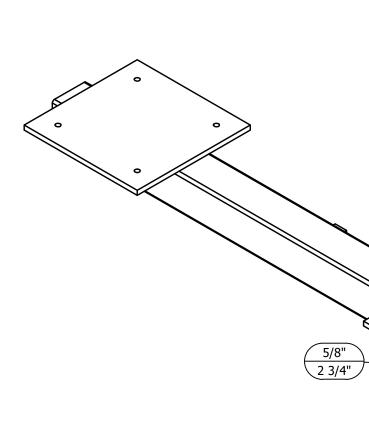



RIGHT ELEVATION

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	ASSOCIATED SUBSTATION ENGINEERING, INC.	1
		0
ENGINEERING SEAL		REV

ASSEMBLIES

MARK QTY DESCRIPTION B1 1 BEAM "B1"

C1 1 COLUMN "C1"

	MISCELLANEOUS						
MARK	QTY	DESCRIPTION					
A1	2	L2 1/2 X 2 1/2 X 3/16					
A2	2	L2 1/2 X 2 1/2 X 3/16					
A3	2	L2 1/2 X 2 1/2 X 3/16					

NOTES:

1. ALL ASTM A36 OR A992/A572 GRADE-50 STEEL UNLESS NOTED. ALL TUBING - ASTM A500 GRADE B. ALL STRUCTURAL PIPE - ASTM A53 GRADE-B.

2. ASTM A325 ERECTION BOLTS. USE THE SHORTEST BOLT THAT WILL ALLOW A F436 FLAT WASHER AND A A563 NUT.


3. ALL HOT DIP GALVANIZED AFTER FABRICATION (ASTM A123).

4. ALL HOLES <u>Ø11/16"</u> FOR <u>Ø5/8"</u> BOLTS UNLESS NOTED.

5. MINIMUM EDGE DISTANCE 7/8" UNLESS NOTED. 6. PIECE MARK STAMPED INTO METAL WITH NOT LESS THAN 3/8" HIGH CHARACTERS BEFORE GALVANIZING.

7. ALL WELDING ELECTRODES SHALL BE E70XX.


8. \bigotimes MARK INDICATES PROPER ORIENTATION OF STRUCTURAL PIECES.

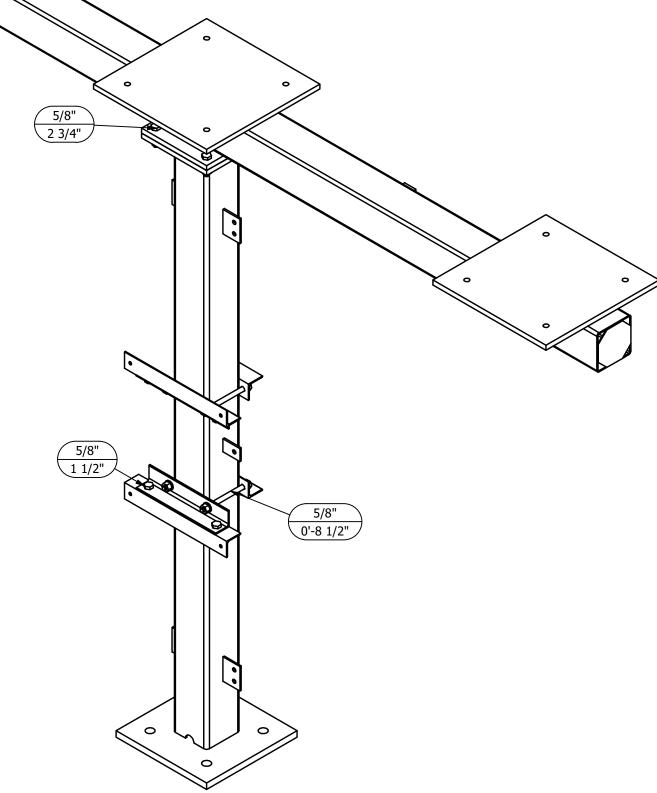


ISOMETRIC VIEW




							REFERENCE DRAWINGS
						DRAWING NUMBER	DESCRIPTION
						SG100	STRUCTURE "G" COVER SHEET
						SG200	STRUCTURE "G" ELEVATIONS
						SG300	STRUCTURE "G" ASSEMBLIES & DETAILS (BILL OF MATERIAL)
							CITY OF DOVER, DE
							69-12.47KV SUBSTATION
		ľ		ľ			STR. G - ELEVATIONS
	9/14/23	JRG	JKG	MR	ISSUED FOR CONSTRUCT	ION	PROJECT NUMBER 47019 SCALE JLF CVC MAR SG200
	9/23/21	JLF	JKG	MR	ISSUE FOR BID		NTS AUBREY SILVEY ENTERPRISES, INC. AUBREY SILVEY ENTERPRISES, INC.
	7/28/21	JLF	CVC	MR	ISSUED FOR APPROVAL		Engineer • Procure • Construct
'	DATE	DRN	СК	APP	DESCRIF	PTION	www.silvey.com/epc 770-537-1144 www.aseng.com 770-537-0033

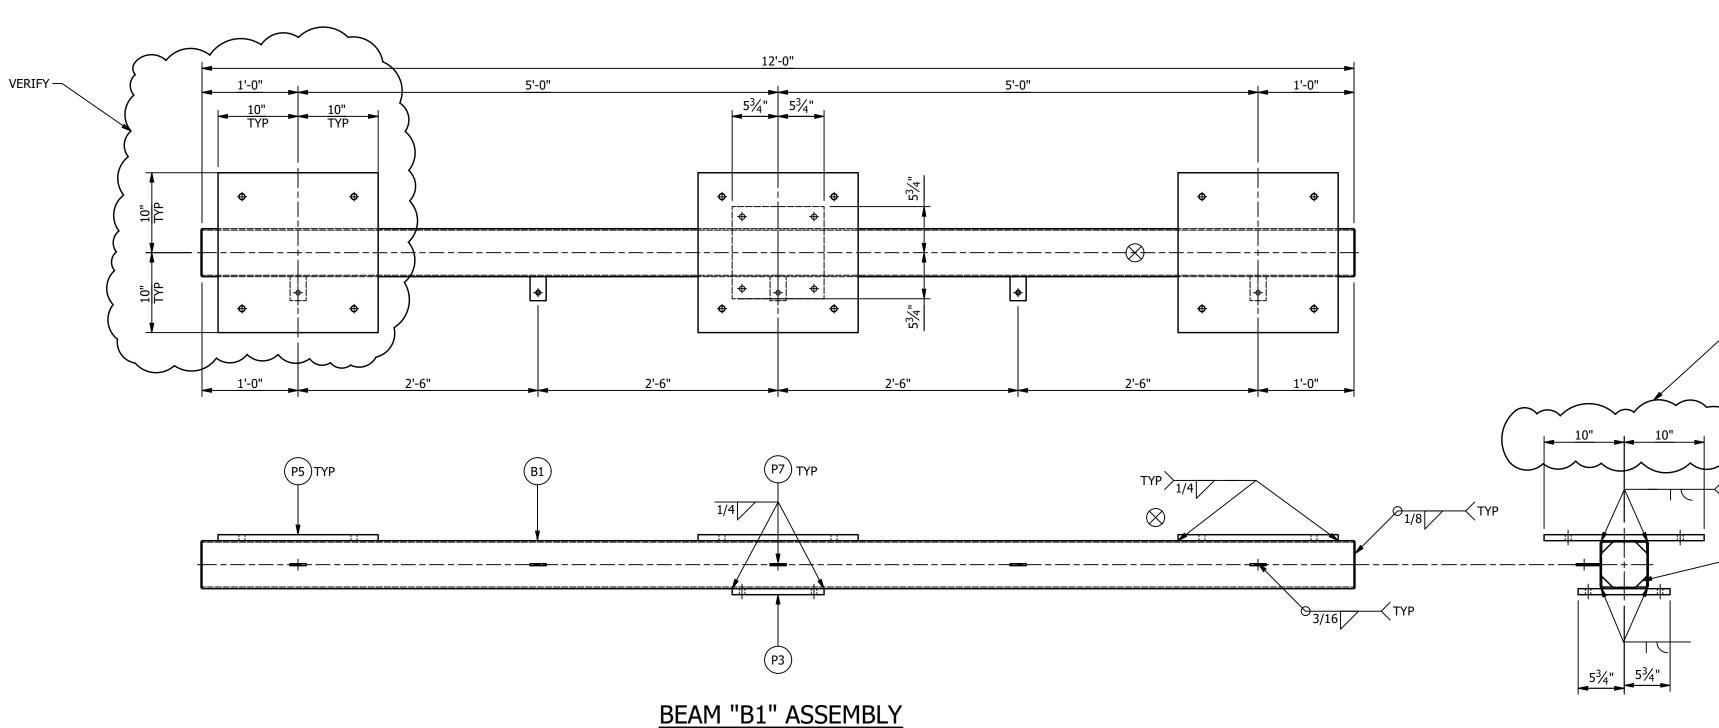

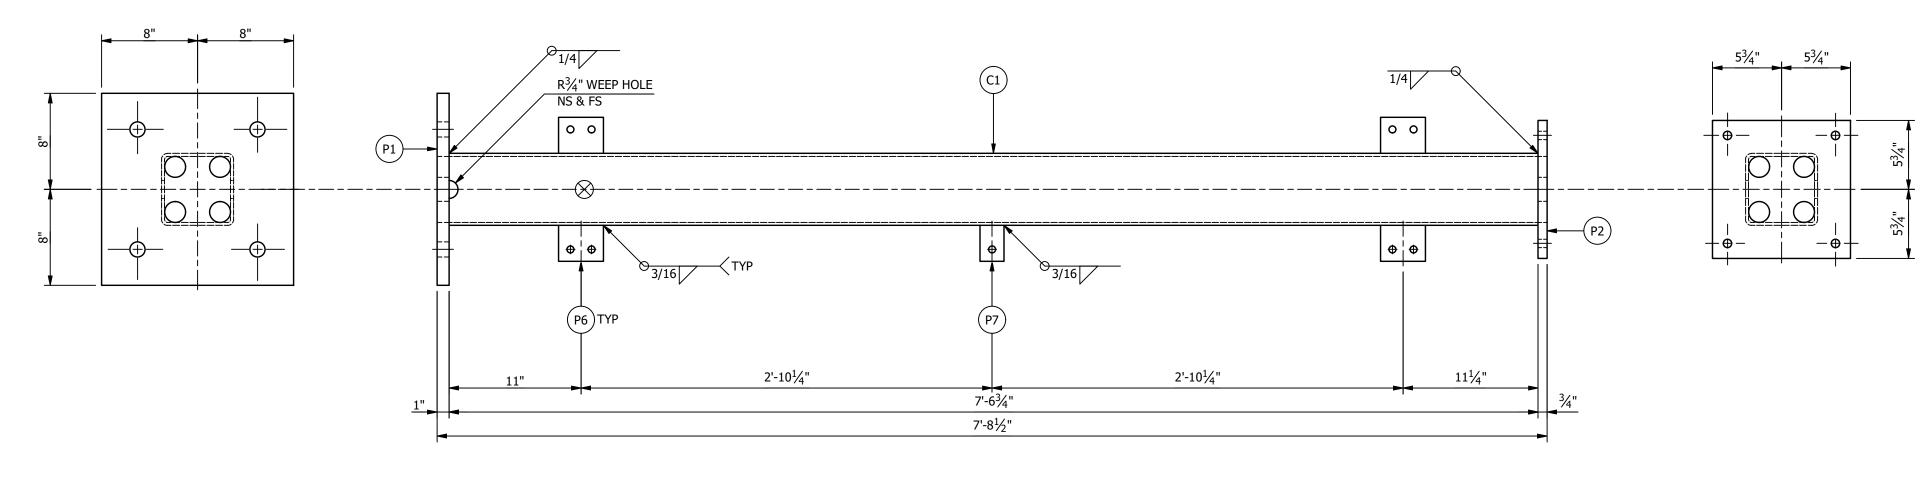



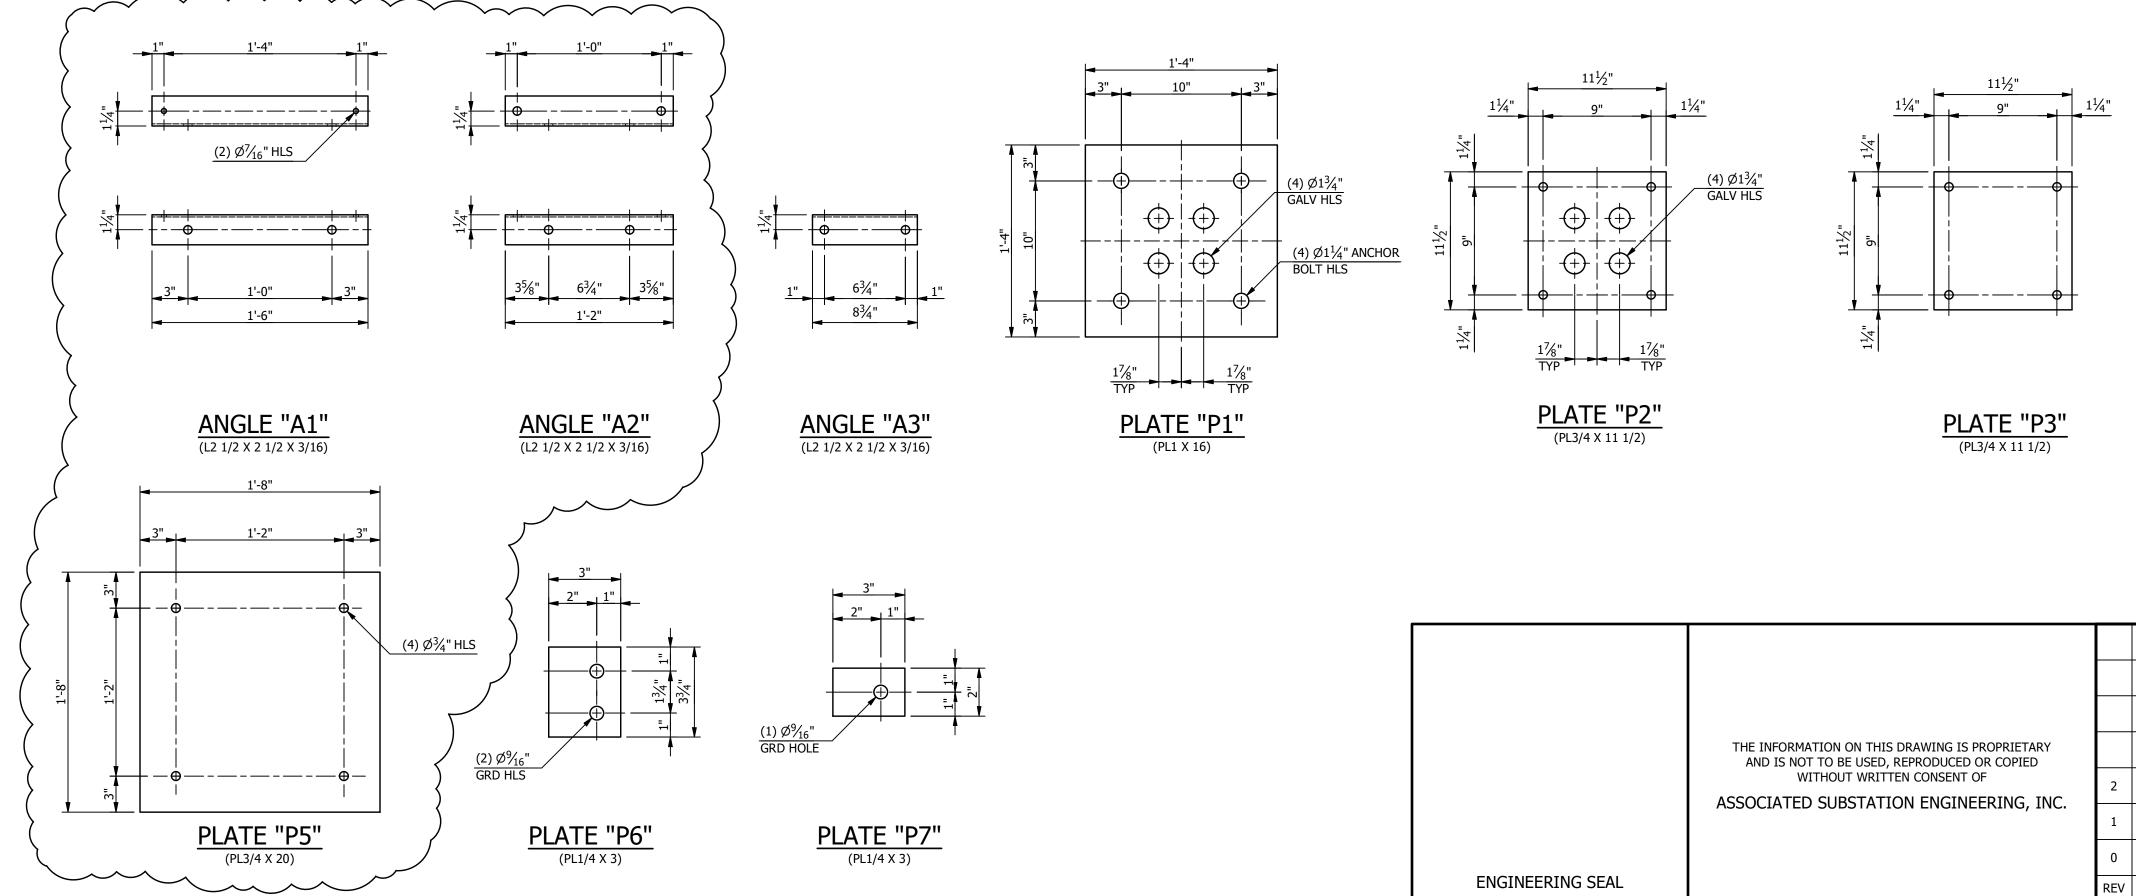

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COLUMN "C1" ASSEMBLY

	BILL OF MATERIAL								
	MARK	QTY	DESCRIPTION	LENGTH	TOTAL WGT				
/ERIFY ——►	A1	2	L2 1/2 X 2 1/2 X 3/16	1'-6"	9.2				
VERIFY	A2	2	L2 1/2 X 2 1/2 X 3/16	1'-2"	7.1				
VERIFY	A3	2	L2 1/2 X 2 1/2 X 3/16	0'-8 3/4"	4.48				
	B1	1	HSS6 X 6 X 3/16	12'-0"	174.31				
	C1	1	HSS6 X 6 X 1/4	7'-6 3/4"	143.83				
	P1	1	PL1 X 16	1'-4"	72.59				
	P2	1	PL3/4 X 11 1/2	0'-11 1/2"	28.13				
	P3	1	PL3/4 X 11 1/2	0'-11 1/2"	28.13				
	P4	2	PL1/8 X 5 3/4	0'-5 3/4"	2.34				
VERIFY	P5	3	PL3/4 X 20	1'-8"	255.21				
	P6	4	PL1/4 X 3	0'-3 3/4"	3.19				
	P7	6	PL1/4 X 3	0'-2"	2.55				
				TOTAL BLK WGT TOTAL GALV WGT					

- VFRIFY



+ ≺ TYP

(P4) TYP

STRUCTURE BOLT ASSEMBLIES QTY DIA LENGTH DESCRIPTION 5/8" 0'-8 1/2" 5/8 GALV THREADED ROD W/ 2HHN, 2FW 5 5 5/8" 2 3/4" GALV A325 HHB W/ GALV F436 HARDENED FW & GALV A563-DH HHN 1 1/2" GALV A325 HHB W/ GALV F436 HARDENED FW & GALV A563-DH HHN 5/8" 5

> SUFFIX ALL PIECE MARKS WITH "STRUCTURE DESIGNATION" THUS PIECE MARK XX BECOMES XXG

NOTES:

1. ALL ASTM A36 OR A992/A572 GRADE-50 STEEL UNLESS NOTED. ALL TUBING - ASTM A500 GRADE B. ALL STRUCTURAL PIPE - ASTM A53 GRADE-B.

2. ASTM A325 ERECTION BOLTS. USE THE SHORTEST BOLT THAT WILL ALLOW A F436 FLAT WASHER AND A A563 NUT.

3. ALL HOT DIP GALVANIZED AFTER FABRICATION (ASTM A123).

4. ALL HOLES <u>Ø11/16"</u> FOR <u>Ø5/8"</u> BOLTS UNLESS NOTED.

5. MINIMUM EDGE DISTANCE **<u>7/8</u>**" UNLESS NOTED.

6. PIECE MARK STAMPED INTO METAL WITH NOT LESS THAN 3/8" HIGH CHARACTERS BEFORE GALVANIZING.

7. ALL WELDING ELECTRODES SHALL BE E70XX.

8. \bigotimes MARK INDICATES PROPER ORIENTATION OF STRUCTURAL PIECES.


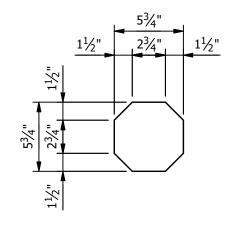


PLATE "P4" (PL1/8 X 5 3/4)

MAKE THIS SHEET <u>"1" - TIME</u>

						REFERENCE DRAWINGS
					DRAWING NUMBER	DESCRIPTION
					SG100	STRUCTURE "G" COVER SHEET
					SG200	STRUCTURE "G" ELEVATIONS
					SG300	STRUCTURE "G" ASSEMBLIES & DETAILS (BILL OF MATERIAL)
						CUSTOMER CITY OF DOVER, DE SUBSTATION 69-12.47KV SUBSTATION TITLE STR. G - ASSEMBLIES & DETAILS PROJECT NUMBER
9/14/23	JRG	JKG	MR	ISSUED FOR CONSTRUCT	ION	47019 SCALE JLF CVC MAR SG300
9/23/21	JLF	JKG	MR	ISSUE FOR BID		
7/28/21	JLF	CVC	MR	ISSUED FOR APPROVAL		EPC DIVISION
DATE	DRN	СК	APP	DESCRIF	PTION	www.silvey.com/epc 770-537-1144 www.aseng.com 770-537-0033

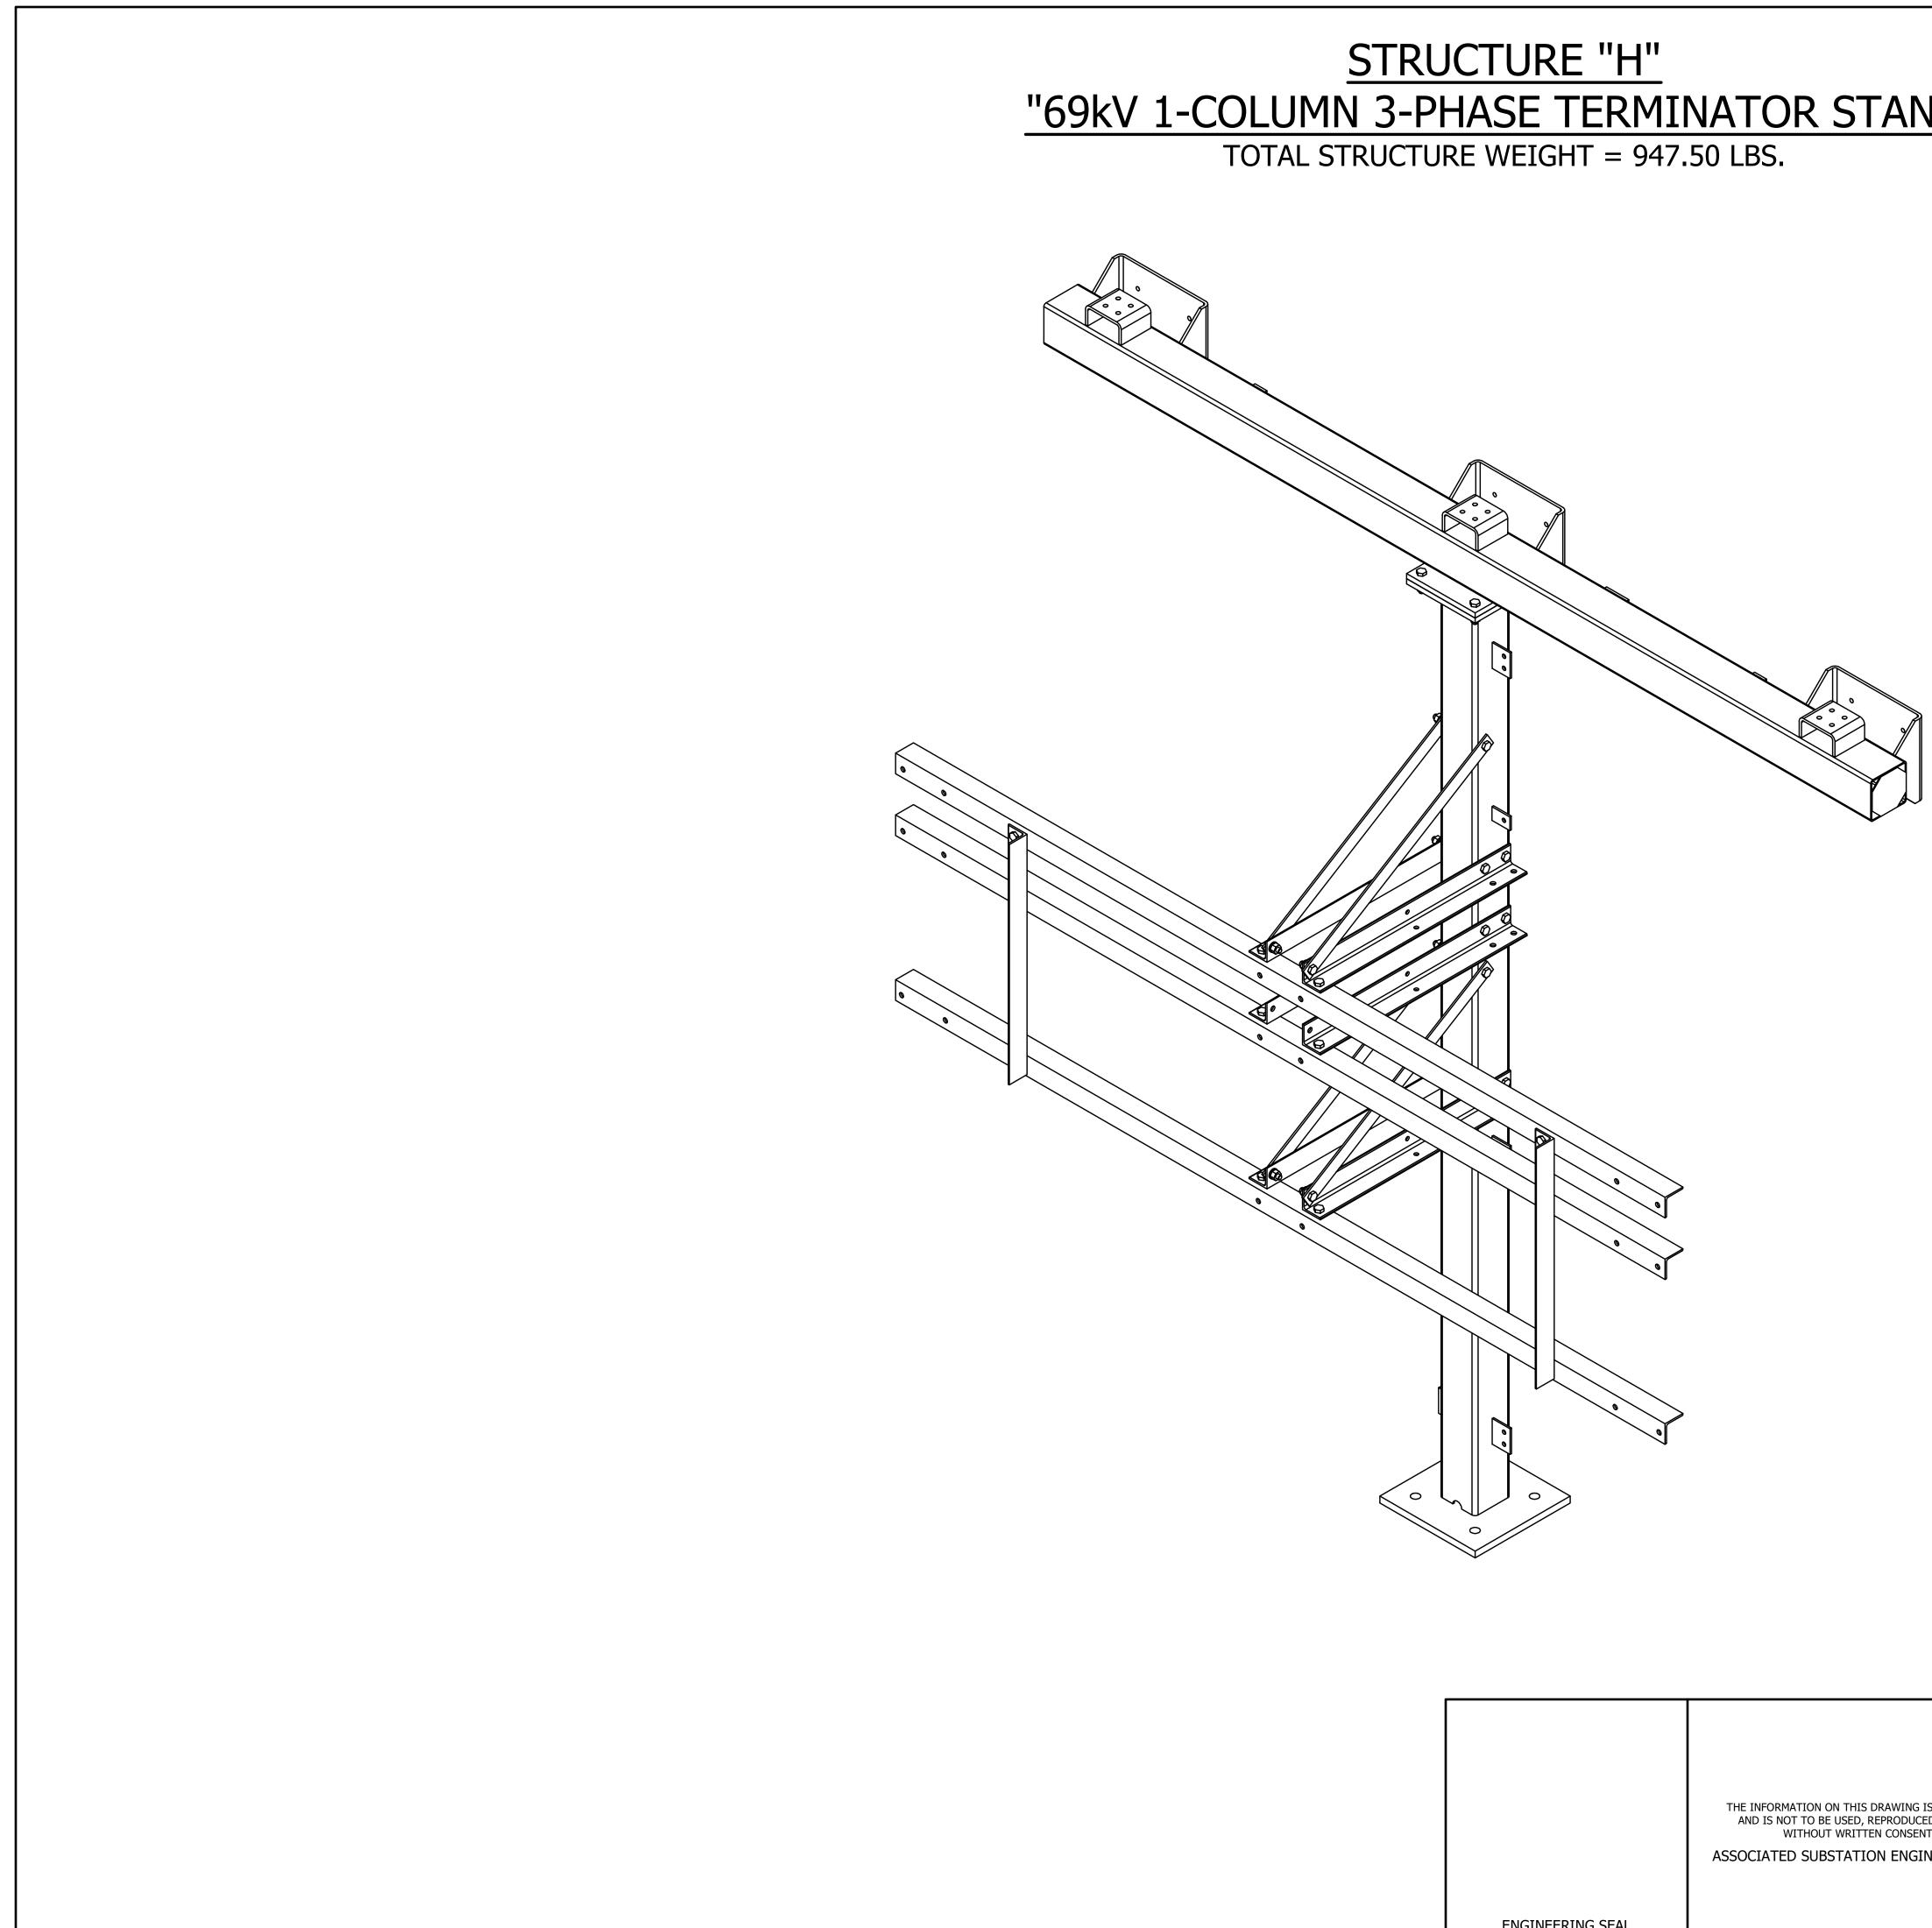


"69kV 1-COLUMN 3-PHASE TERMINATOR STAND"


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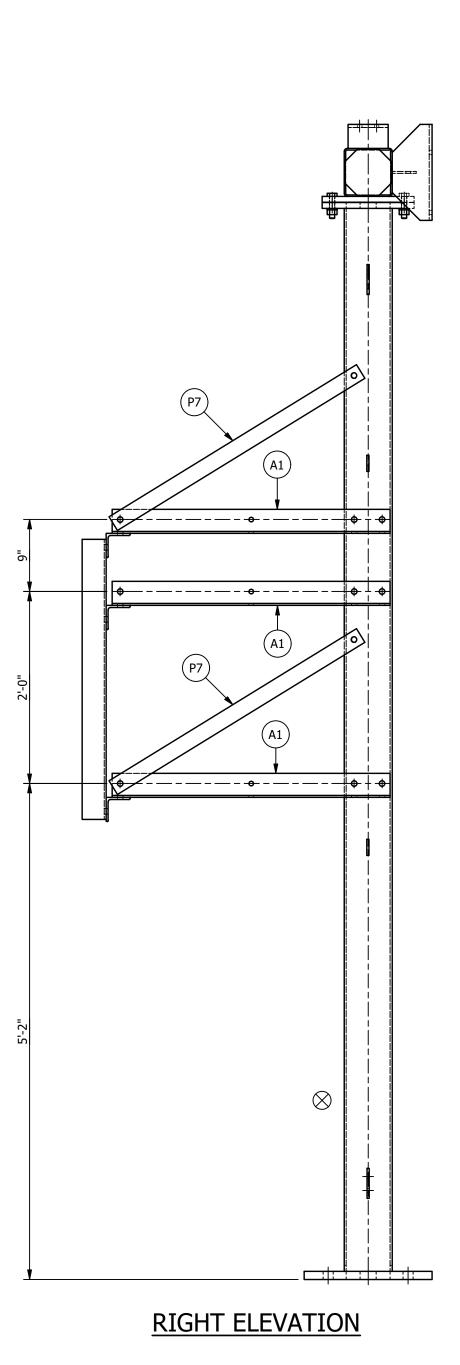
			ANCHOR BOLTS
QTY	DIA	LENGTH	DECSRIPTION
4	1"	2'-6"	GALV ANCHOR BOLTS WITH 2 HHN AND 2 FW (F1554 GRADE 55)


MAKE STRUCTURE "H" <u>"1" - TIME</u>

							REFERENCE DRAWINGS			
					DRAWING NUMBER			DESC	RIPTION	
					SH100	STRUCTURE "H"	' COVER SHE	ET		
					SH200	STRUCTURE "H"	' ELEVATION	IS		
					SH300	STRUCTURE "H"	' ASSEMBLIE	S & DETAILS	S (BILL OF N	MATERIAL)
						CUSTOMER SUBSTATION TITLE	69-12	.47 KV	VER, DE	/ER STATION SHEET
9/14/23	JRG	JKG	MR	ISSUED FOR CONSTRUCTI	ON	PROJECT NUMBER 47019 SCALE NTS	JLF	CHECKED	APPROVED MAR	DRAWING NUMBER SH100
9/23/21	JLF	JKG	MR	ISSUE FOR BID		AUBREY SILVI	EY ENTERP	RISES, INC		SOCIATED
7/28/21	JLF	CVC	MR	ISSUED FOR APPROVAL			-	/ISION		UBSTATION
DATE	DRN	СК	APP	DESCRIF	PTION		silvey.com/ep			www.aseng.com 770-537-0033



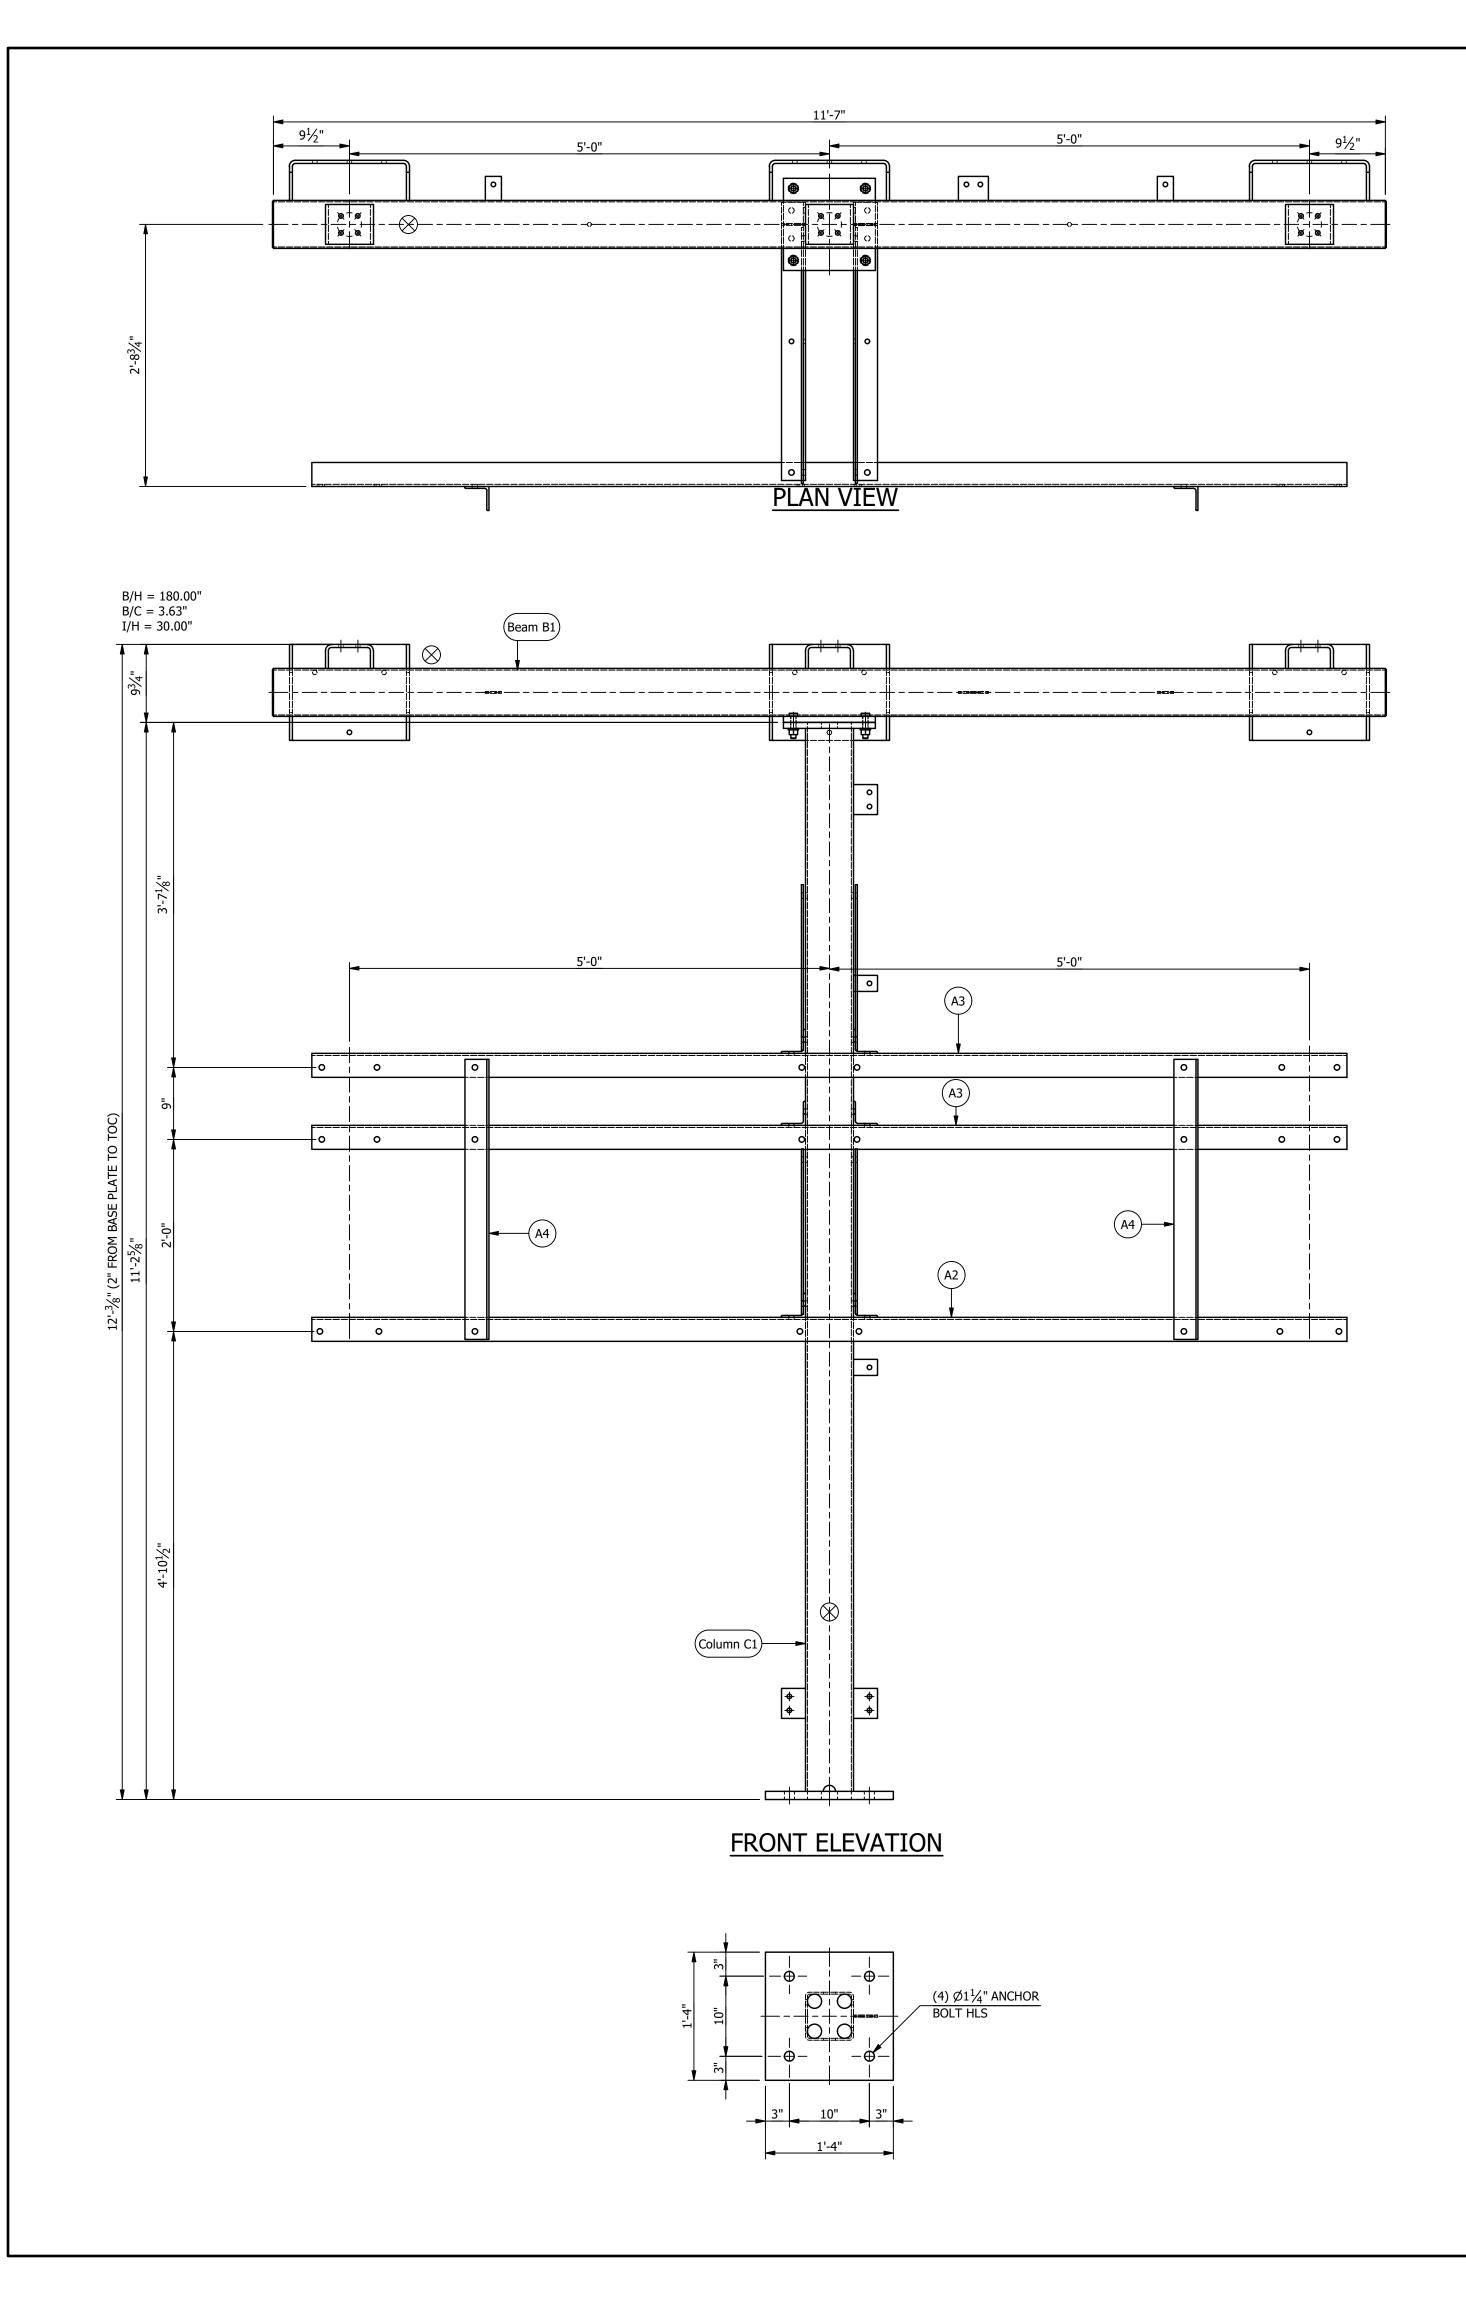

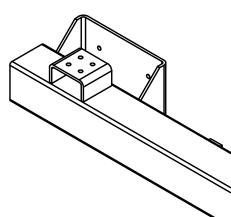

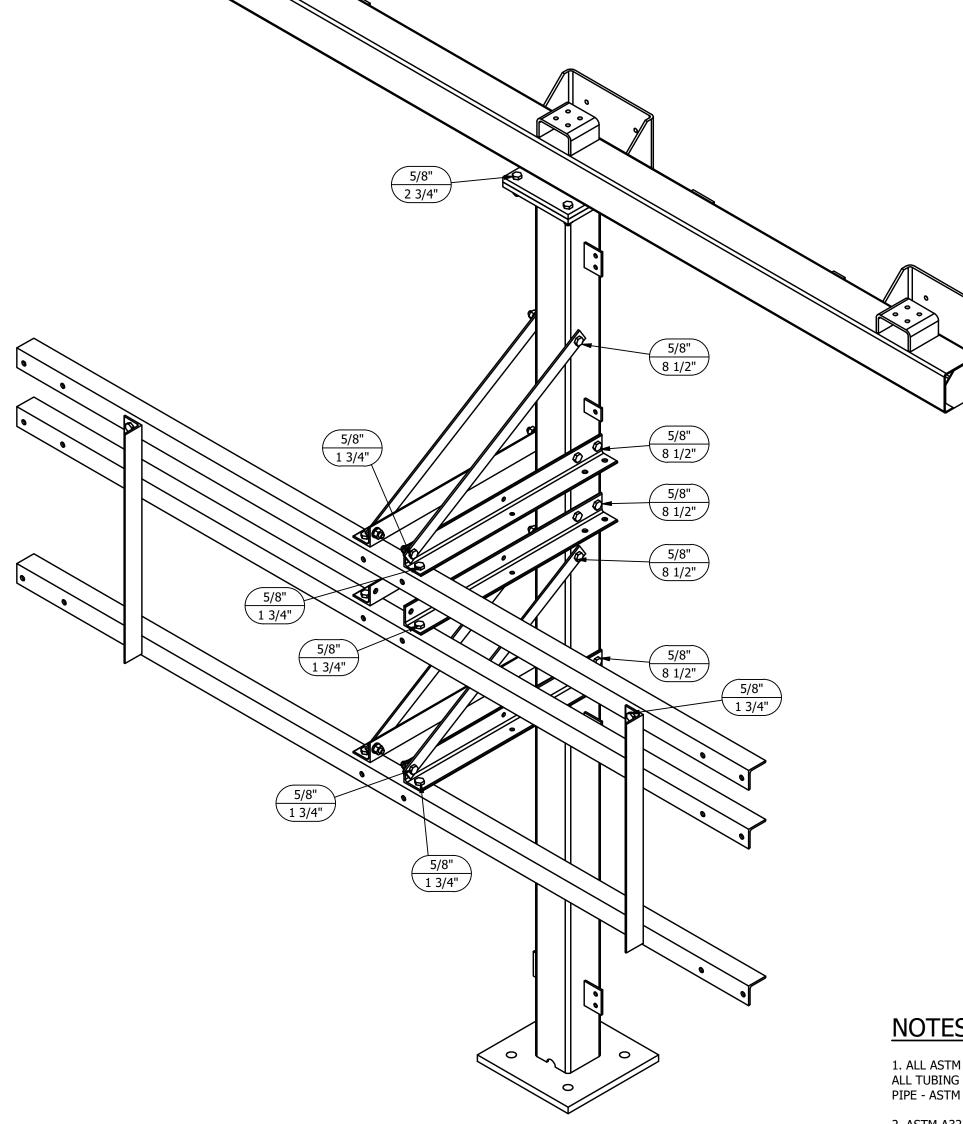

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	ASSOCIATED SUBSTATION ENGINEERING, INC.		+
		1	
		0	
ENGINEERING SEAL		REV	

ASSEMBLIES LIST

QTY

1

1

MARK Beam B1 Column C1

MISC. STEEL

MARK	QTY
A1	6
A2	1
A3	2
A4	2
P7	4

ISOMETRIC VIEW

NOTES:

1. ALL ASTM A36 OR A992/A572 GRADE-50 STEEL UNLESS NOTED. ALL TUBING - ASTM A500 GRADE B. ALL STRUCTURAL PIPE - ASTM A53 GRADE-B.

2. ASTM A325 ERECTION BOLTS. USE THE SHORTEST BOLT THAT WILL ALLOW A F436 FLAT WASHER AND A A563 NUT.

3. ALL HOT DIP GALVANIZED AFTER FABRICATION (ASTM A123).

4. ALL HOLES <u>Ø11/16"</u> FOR <u>Ø5/8"</u> BOLTS UNLESS NOTED.


5. MINIMUM EDGE DISTANCE 7/8" UNLESS NOTED.


6. PIECE MARK STAMPED INTO METAL WITH NOT LESS THAN 3/8" HIGH CHARACTERS BEFORE GALVANIZING.

7. ALL WELDING ELECTRODES SHALL BE E70XX.

MAKE STRUCTURE "H" "1" - TIME

						REFERENCE DRAWINGS
					DRAWING NUMBER	DESCRIPTION
					SH100	STRUCTURE "H" COVER SHEET
					SH200	STRUCTURE "H" ELEVATIONS
					SH300	STRUCTURE "H" ASSEMBLIES & DETAILS (BILL OF MATERIAL)
						CUSTOMER CITY OF DOVER DOVER, DE SUBSTATION 69-12.47 KV SUBSTATION TITLE STR. H - ELEVATIONS
9/14/23	JRG	JKG	MR	ISSUED FOR CONSTRUCT	ION	PROJECT NUMBER DRAWN CHECKED APPROVED DRAWING NUMBER 47019 JLF CVC MAR SH200 SCALE NTS SH200
9/23/21	JLF	JKG	MR	ISSUE FOR BID		AUBREY SILVEY ENTERPRISES, INC. I SSOCIATED
7/28/21	JLF	CVC	MR	ISSUED FOR APPROVAL		Engineer • Procure • Construct
DATE	DRN	СК	APP	DESCRI	PTION	www.silvey.com/epc 770-537-1144 www.aseng.com 770-537-0033

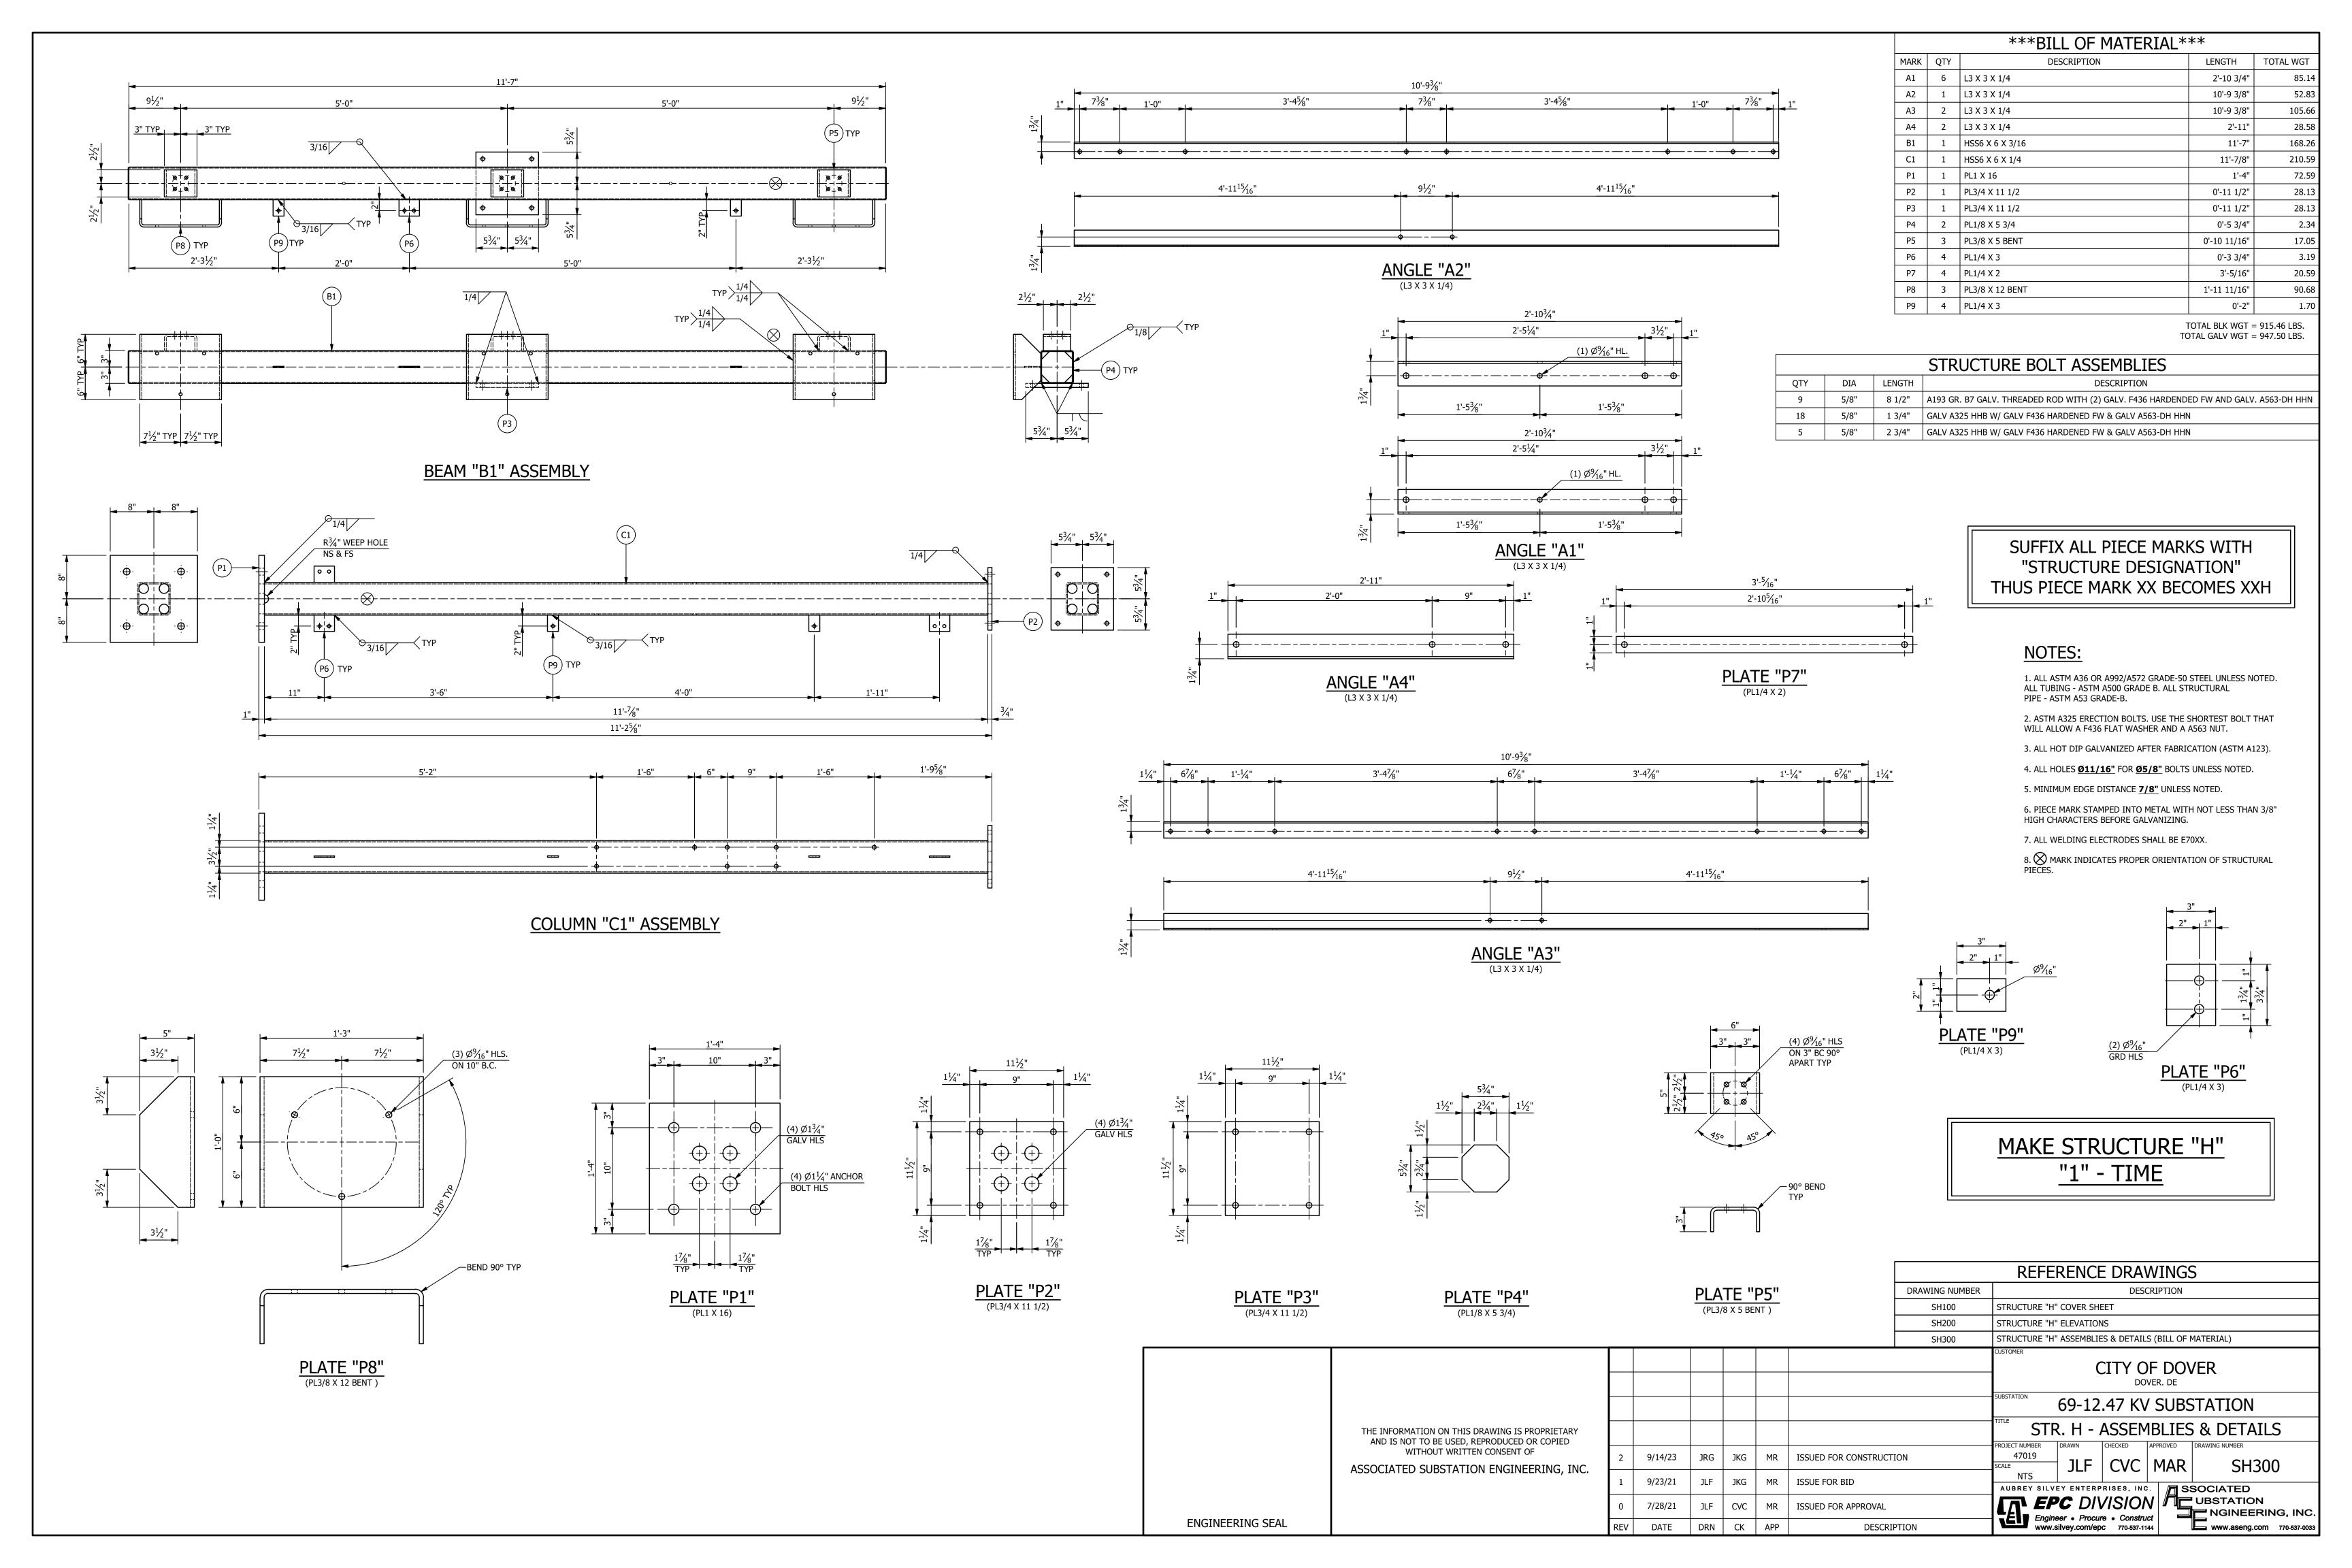

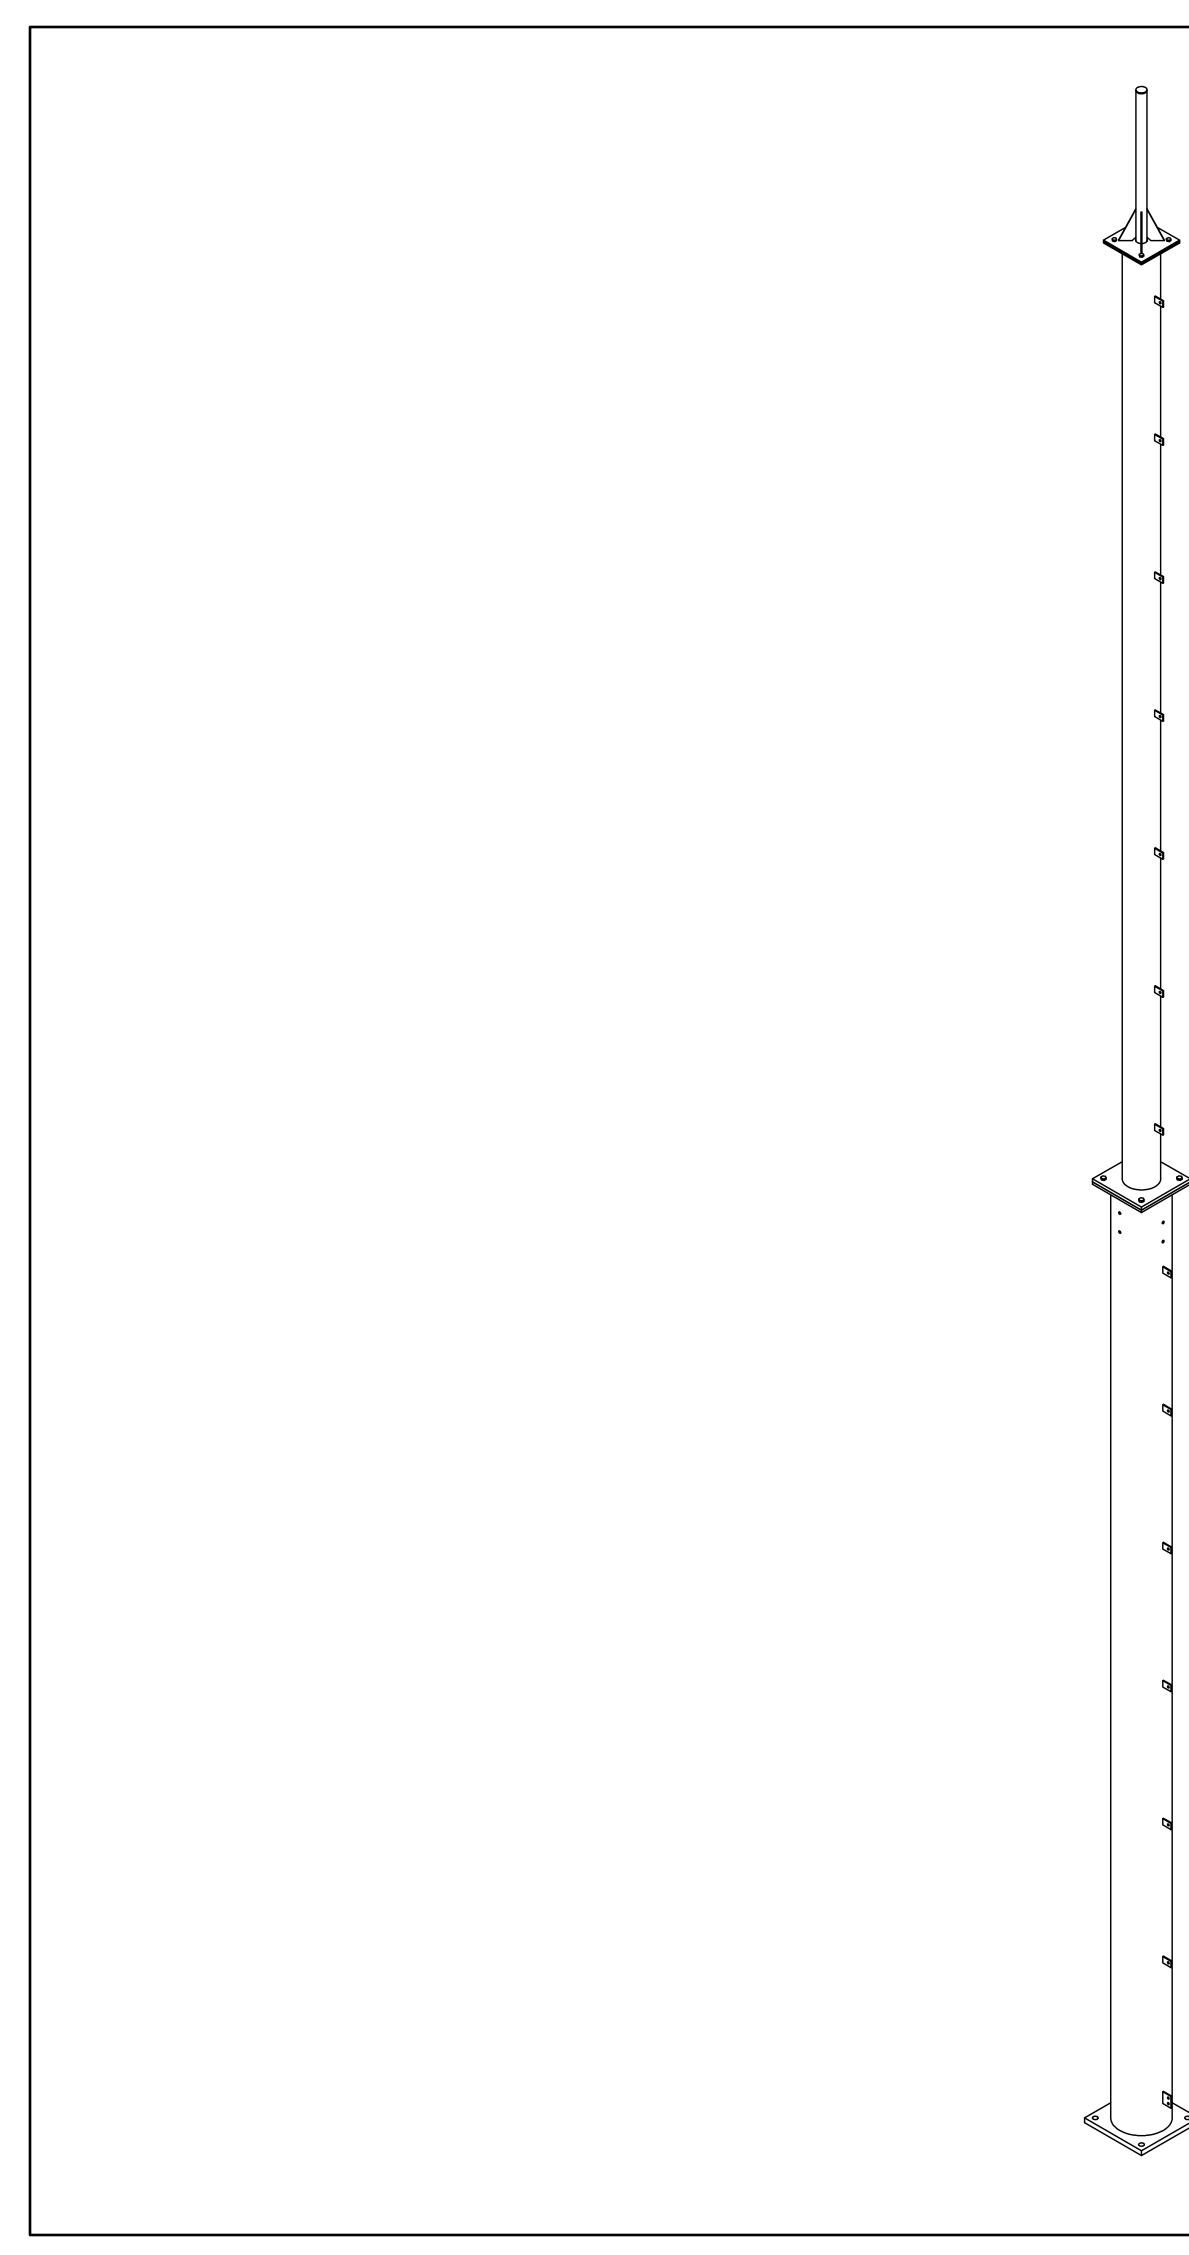

STRUCTURE "K" "LIGHTNING MAST" TOTAL STRUCTURE WEIGHT = 2,736.71 LBS.

THE INFORMATION ON THIS DRAWING IS PROPRIETARY AND IS NOT TO BE USED, REPRODUCED OR COPIED WITHOUT WRITTEN CONSENT OF

ASSOCIATED SUBSTATION ENGINEERING, INC.


REV

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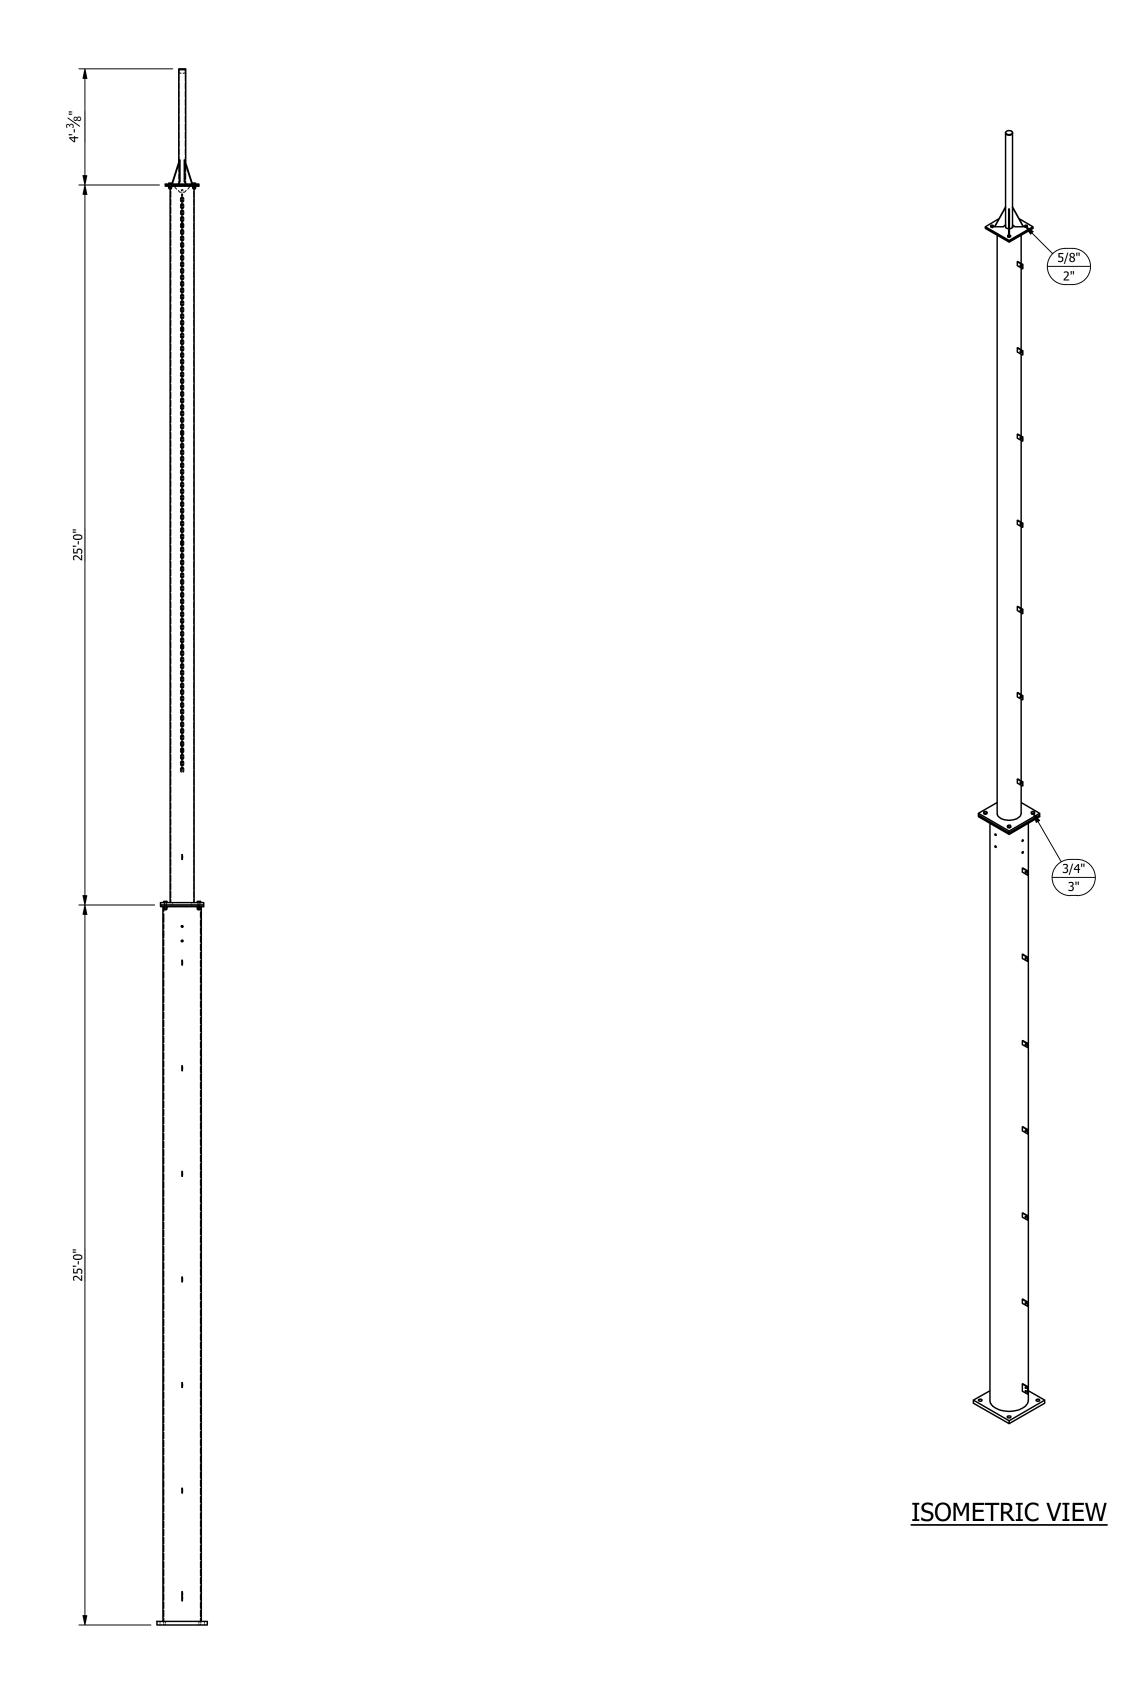
			ANCHOR BOLTS
QTY	DIA	LENGTH	DECSRIPTION
4	1 1/4"	3'-0"	GALV ANCHOR BOLTS WITH 2 HHN AND 2 FW (F1554 GRADE 55)

<u>MAKE STRUCTURE "K"</u> <u>"3" - TIMES</u>

					REFERENCE DRAWINGS			
					DRAWING NUMBER	DESCRIPTION		
					SK100	STRUCTURE "K" COVER SHEET		
					SK200	STRUCTURE "K" ELEVATIONS		
					SK300	STRUCTURE "K" ASSEMBLIES & DETAILS (BILL OF MATERIAL)		
						CUSTOMER CITY OF DOVER DOVER, DELEWARE TITLE STR. K - COVER SHEET SUBSTATION 69-12.47 KV SUBSTATION PROJECT NUMBER 47019 SCALE BSA JKG MAR SK100		
9/14/23	JRG	JKG	MR	ISSUED FOR CONSTRUCTI	ON	AUBREY SILVEY ENTERPRISES, INC.		
9/23/21	KDC	JKG	MR	ISSUE FOR BID		Engineer • Procure • Construct		
DATE	DRN	СК	APP	DESCRIF	PTION	www.silvey.com/epc 770-537-1144 www.aseng.com 770-537-0033		



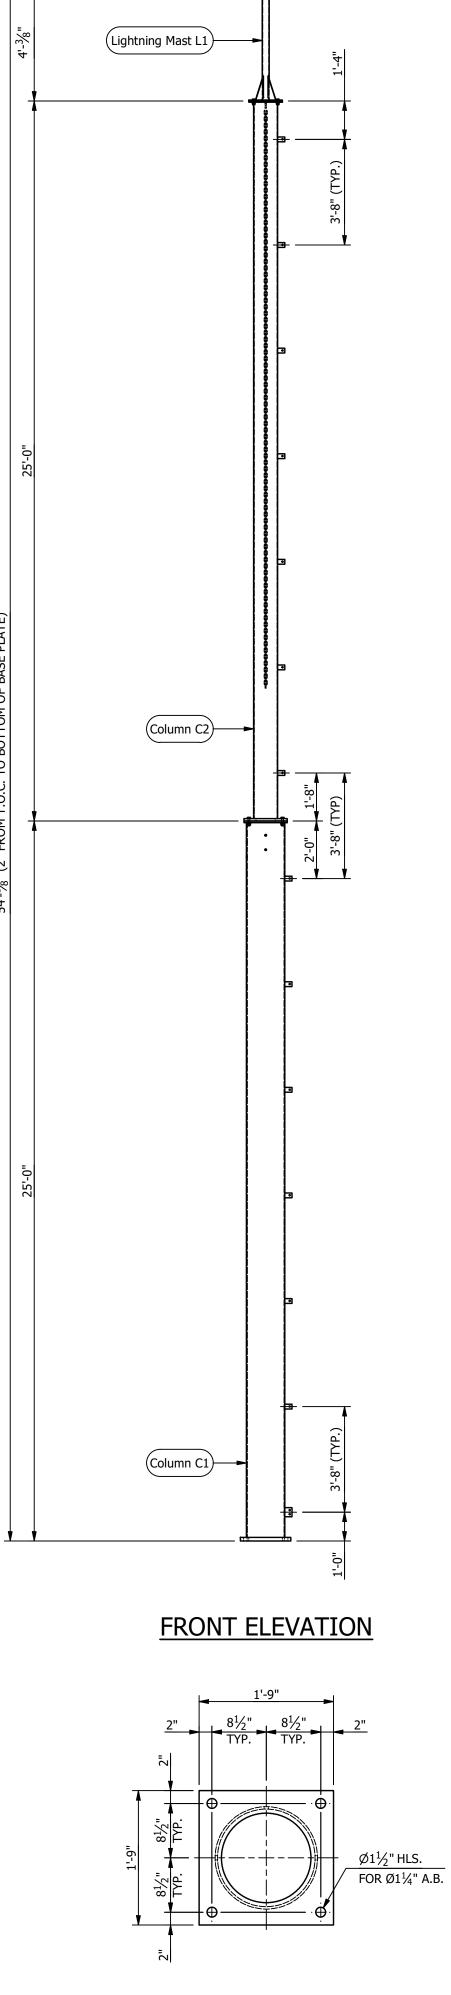



RIGHT ELEVATION

THE INFORMATION ON THIS DRAWING IS PROPRIETARY AND IS NOT TO BE USED, REPRODUCED OR COPIED WITHOUT WRITTEN CONSENT OF

REV

ASSOCIATED SUBSTATION ENGINEERING, INC.

ASSEMBLIES						
MARK	QTY					
Column C1	1					
Column C2	1					
Lightning Mast L1	1					

NOTES:

1. ALL ASTM A36 OR A992/A572 GRADE-50 STEEL UNLESS NOTED. ALL TUBING - ASTM A500 GRADE B. ALL STRUCTURAL PIPE - ASTM A53 GRADE-B.

2. ASTM A325 ERECTION BOLTS. USE THE SHORTEST BOLT THAT WILL ALLOW A F436 FLAT WASHER AND A A563 NUT.

3. ALL HOT DIP GALVANIZED AFTER FABRICATION (ASTM A123).

4. ALL HOLES <u>Ø11/16"</u> FOR <u>Ø5/8"</u> BOLTS UNLESS NOTED.

5. MINIMUM EDGE DISTANCE **<u>7/8"</u>** UNLESS NOTED.


6. PIECE MARK STAMPED INTO METAL WITH NOT LESS THAN 3/8" HIGH CHARACTERS BEFORE GALVANIZING.

7. ALL WELDING ELECTRODES SHALL BE E70XX.

8. \bigotimes MARK INDICATES PROPER ORIENTATION OF STRUCTURAL PIECES.


MAKE STRUCTURE "K" <u>"3" - TIMES</u>

						REFERENCE DRAWINGS	
					DRAWING NUMBER	DESCRIPTION	
					SK100	STRUCTURE "K" COVER SHEET	
					SK200	STRUCTURE "K" ELEVATIONS	
					SK300	STRUCTURE "K" ASSEMBLIES & DETAILS (BILL OF MATERIAL)	
						CUSTOMER CUSTOMER CITY OF DOVER DOVER, DELEWARE TITLE SUBSTATION SUBSTATION 69-12.47 KV SUBSTATION PROJECT NUMBER 47019 SCALE BSA JKG MAR SK20)0
9/14/23	JRG	JKG	MR	ISSUED FOR CONSTRUCT	ION	NTS	
9/23/21	KDC	JKG	MR	ISSUE FOR BID			NG, INC.
DATE	DRN	CK	APP	DESCRI	PTION	www.silvey.com/epc 770-537-1144 www.aseng.com	1 770-537-0033

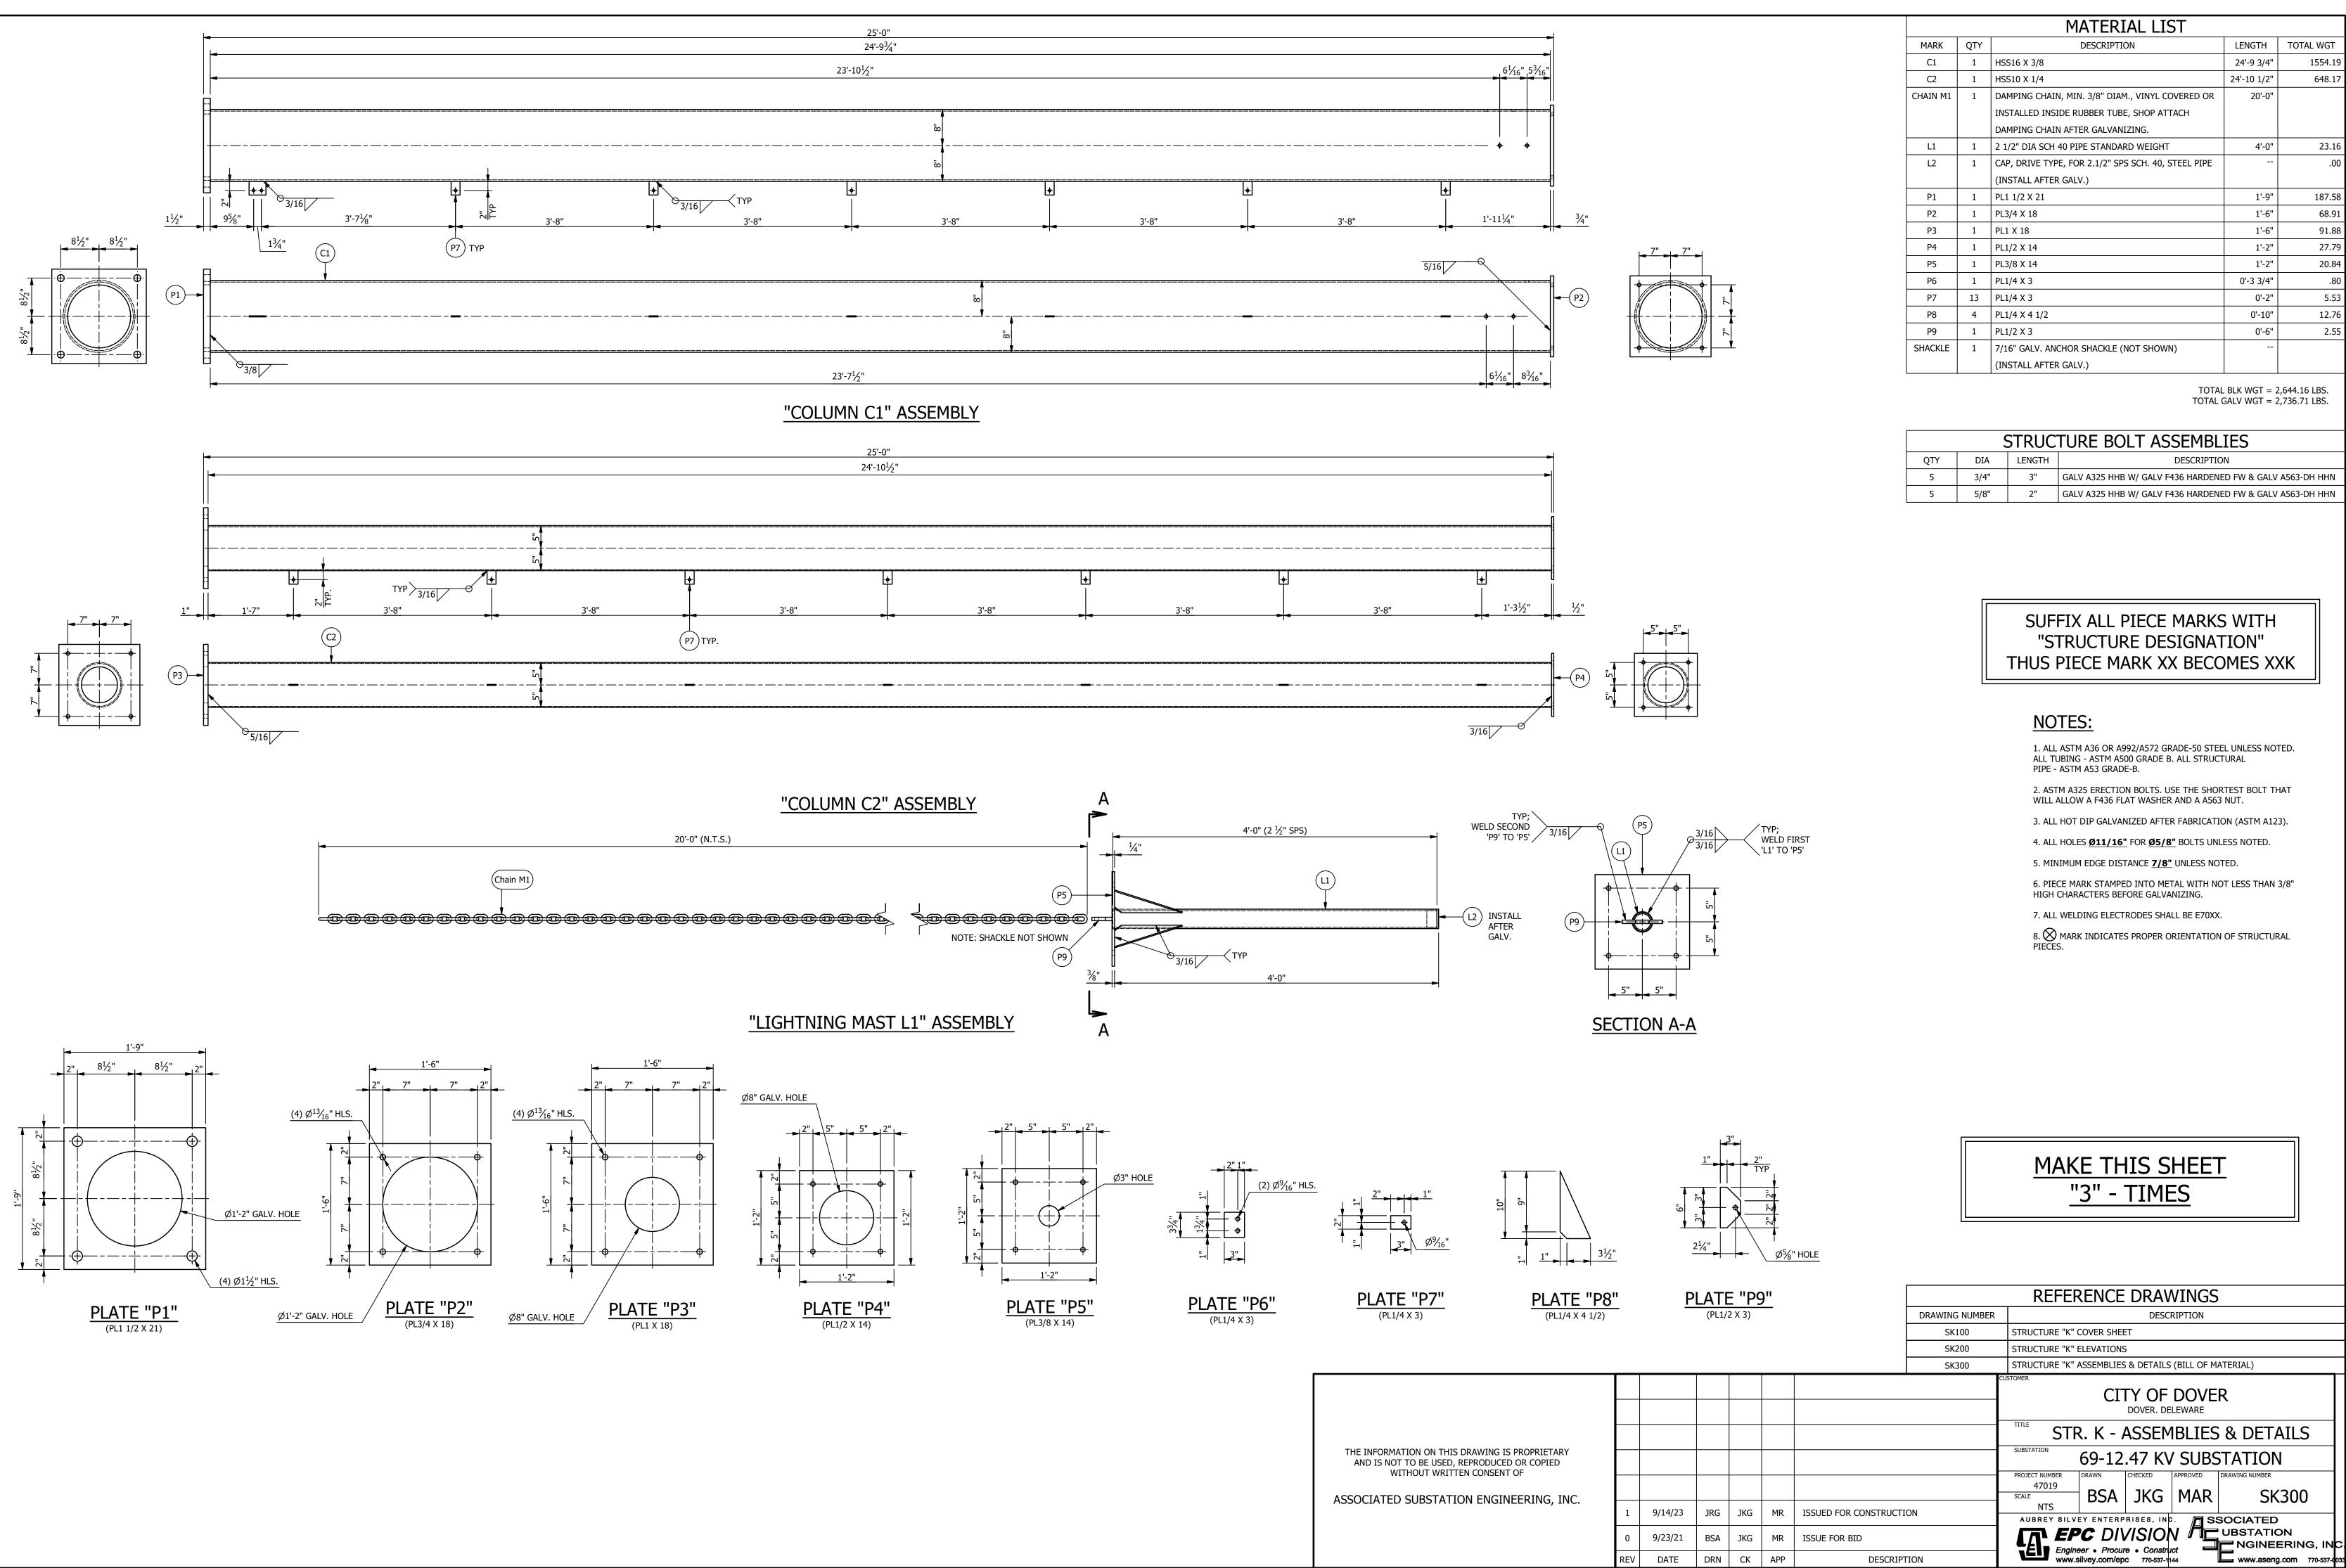


		MATERIAL LIST		
MARK	QTY	DESCRIPTION	LENGTH	TOTAL WGT
C1	1	HSS16 X 3/8	24'-9 3/4"	1554.19
C2	1	HSS10 X 1/4	24'-10 1/2"	648.17
CHAIN M1	1	DAMPING CHAIN, MIN. 3/8" DIAM., VINYL COVERED OR	20'-0"	
	INSTALLED INSIDE RUBBER TUBE, SHOP ATTACH			
		DAMPING CHAIN AFTER GALVANIZING.		
L1	1	2 1/2" DIA SCH 40 PIPE STANDARD WEIGHT	4'-0"	23.16
L2	1	CAP, DRIVE TYPE, FOR 2.1/2" SPS SCH. 40, STEEL PIPE		.00
		(INSTALL AFTER GALV.)		
P1	1	PL1 1/2 X 21	1'-9"	187.58
P2	1	PL3/4 X 18	1'-6"	68.91
P3	1	PL1 X 18	1'-6"	91.88
P4	1	PL1/2 X 14	1'-2"	27.79
P5	1	PL3/8 X 14	1'-2"	20.84
P6	1	PL1/4 X 3	0'-3 3/4"	.80
P7	13	PL1/4 X 3	0'-2"	5.53
P8	4	PL1/4 X 4 1/2	0'-10"	12.76
P9	1	PL1/2 X 3	0'-6"	2.55
SHACKLE	1	7/16" GALV. ANCHOR SHACKLE (NOT SHOWN)		
		(INSTALL AFTER GALV.)		

STRUCTURE BOLT ASSEMBLIES							
QTY	DIA	LENGTH	DESCRIPTION				
5	3/4"	3"	GALV A325 HHB W/ GALV F436 HARDENED FW & GALV A563-DH HHN				
5	5/8"	2"	GALV A325 HHB W/ GALV F436 HARDENED FW & GALV A563-DH HHN				

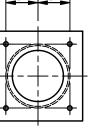




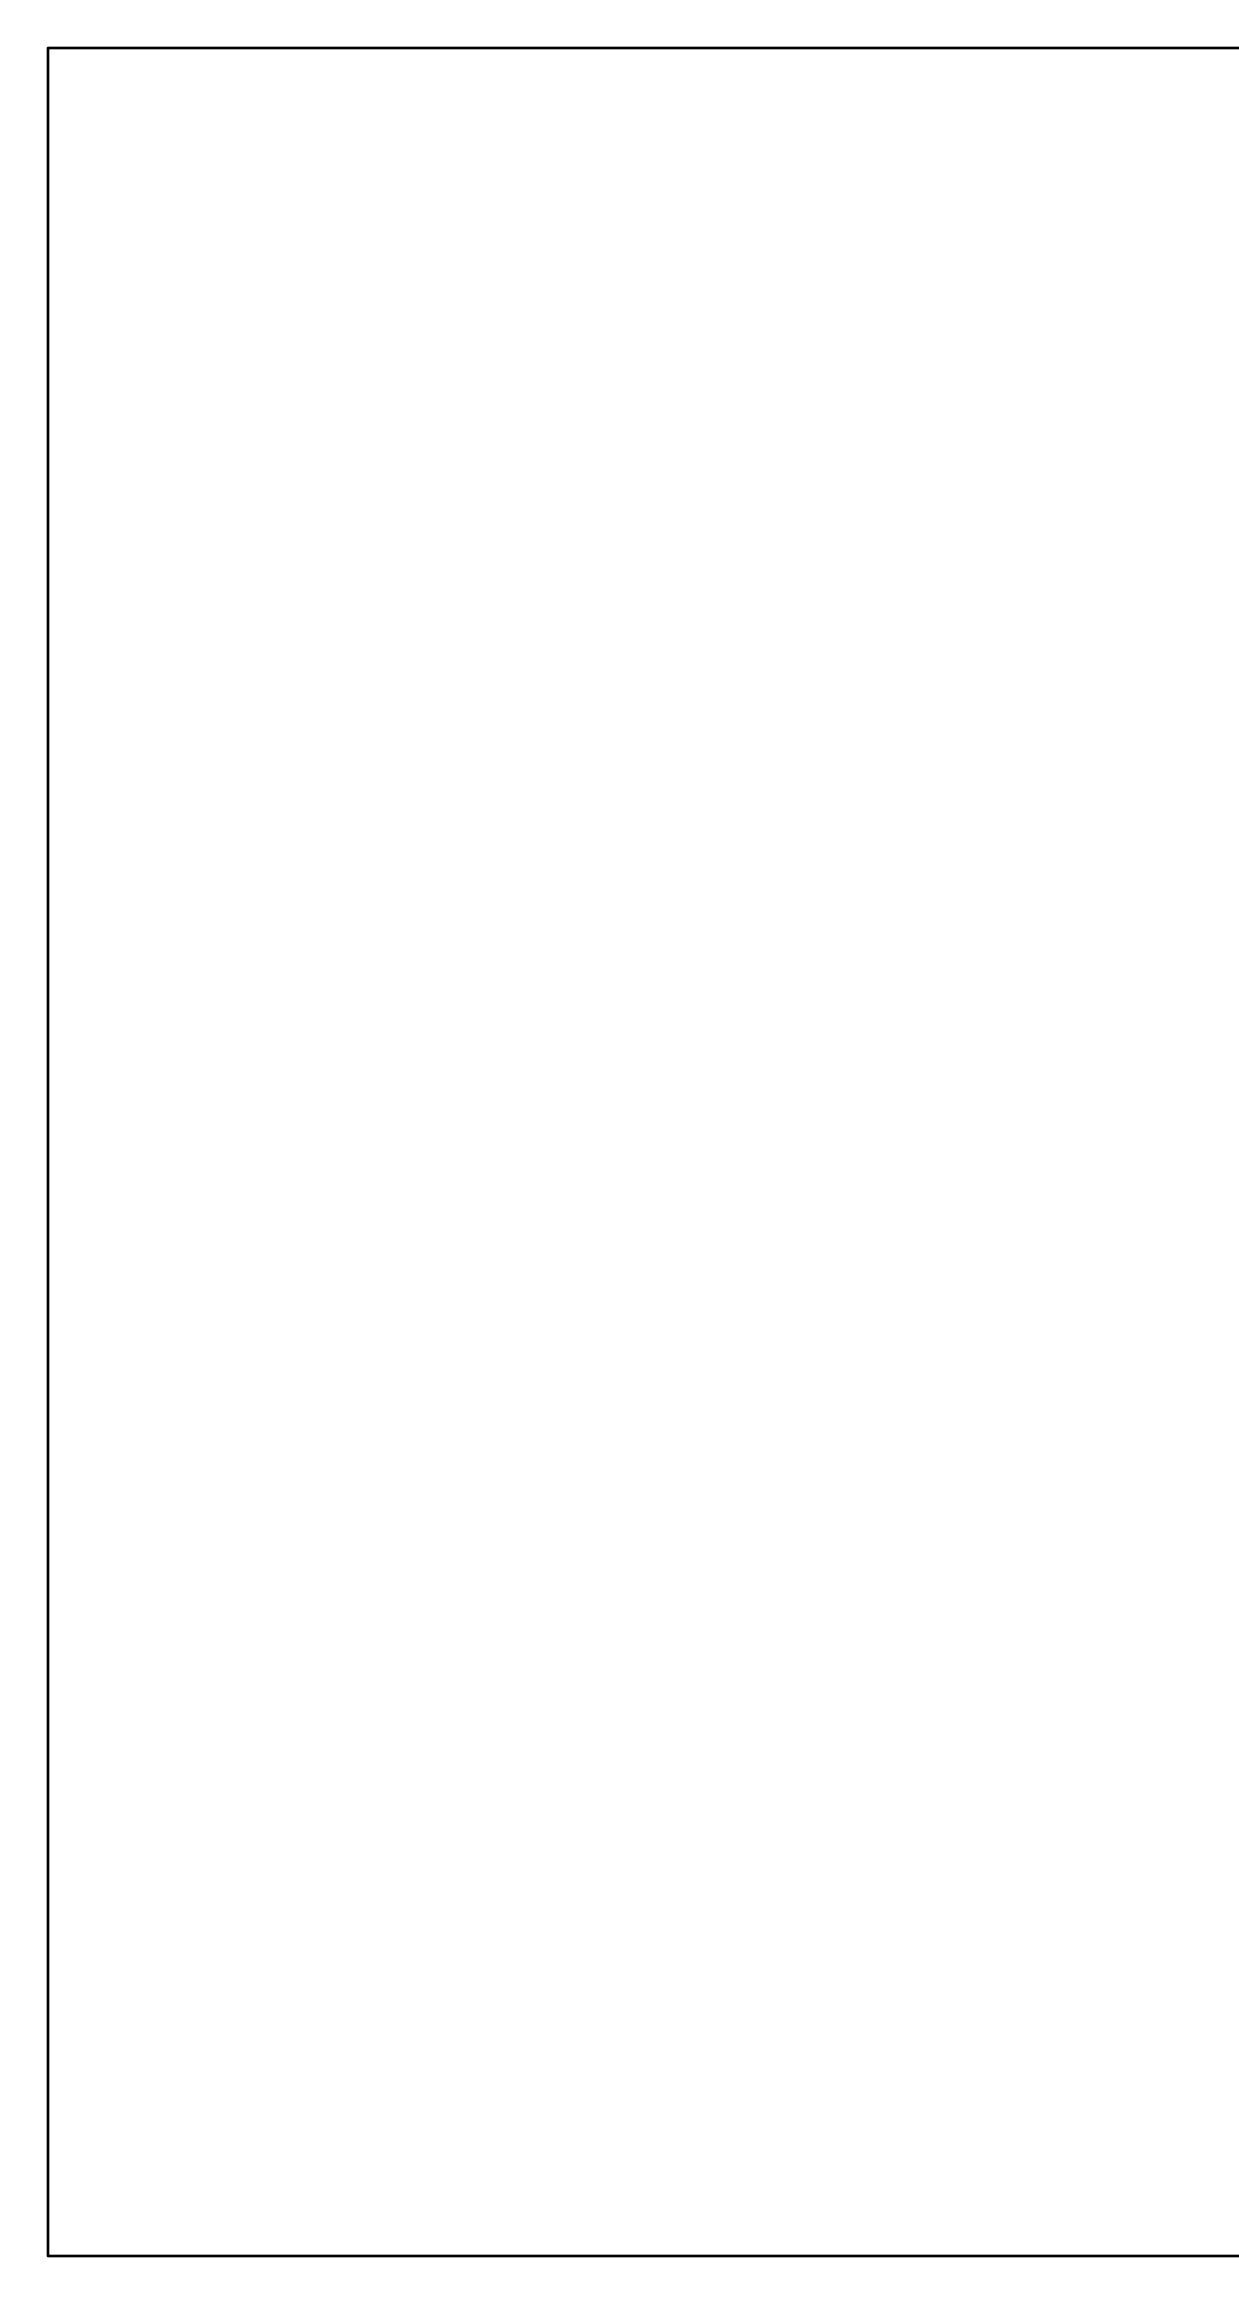

STRUCTURE "L" "69KV 1-COLUMN METERING STAND"

TOTAL STRUCTURE WEIGHT = 366.08 LBS.

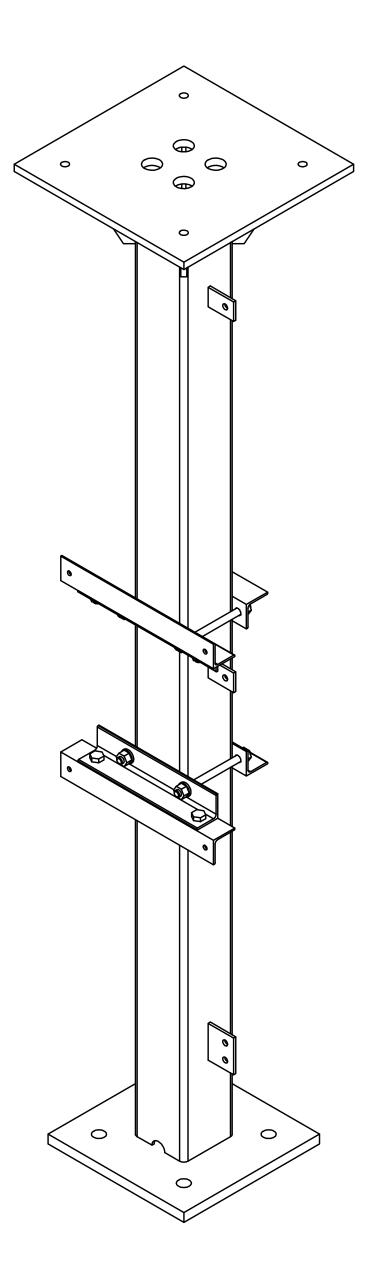



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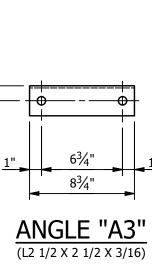
			ANCHOR BOLTS
QTY	DIA	LENGTH	DECSRIPTION
4	1"	2'-6"	GALV ANCHOR BOLTS WITH 2 HHN AND 2 FW (F1554 GRADE 55)


<u>MAKE STRUCTURE "L"</u> <u>"1" - TIME</u>


				REFERENCE DRAWINGS			
					DRAWING NUMBER	DESCRIPTION	
					SL100	STRUCTURE "L" COVER SHEET	
					SL200	STRUCTURE "L" ELEVATIONS	
					SL300	STRUCTURE "L" ASSEMBLIES & DETAILS (BILL OF MATERIAL)	
						CUSTOMER CITY OF DOVER, DE SUBSTATION 69-12.47KV SUBSTATION TITLE STR. L - COVER SHEET PROJECT NUMBER 47019 SCALE NTS AUBREY SILVEY ENTERPRISES, INC.	
9/14/23	JRG	JKG	MR	ISSUDE FOR CONSTRUCTI	ION	EPC DIVISION Engineer • Procure • Construct	
DATE	DRN	CK	APP	DESCRIF	PTION	www.silvey.com/epc 770-537-1144 www.aseng.com 770-537-0033	



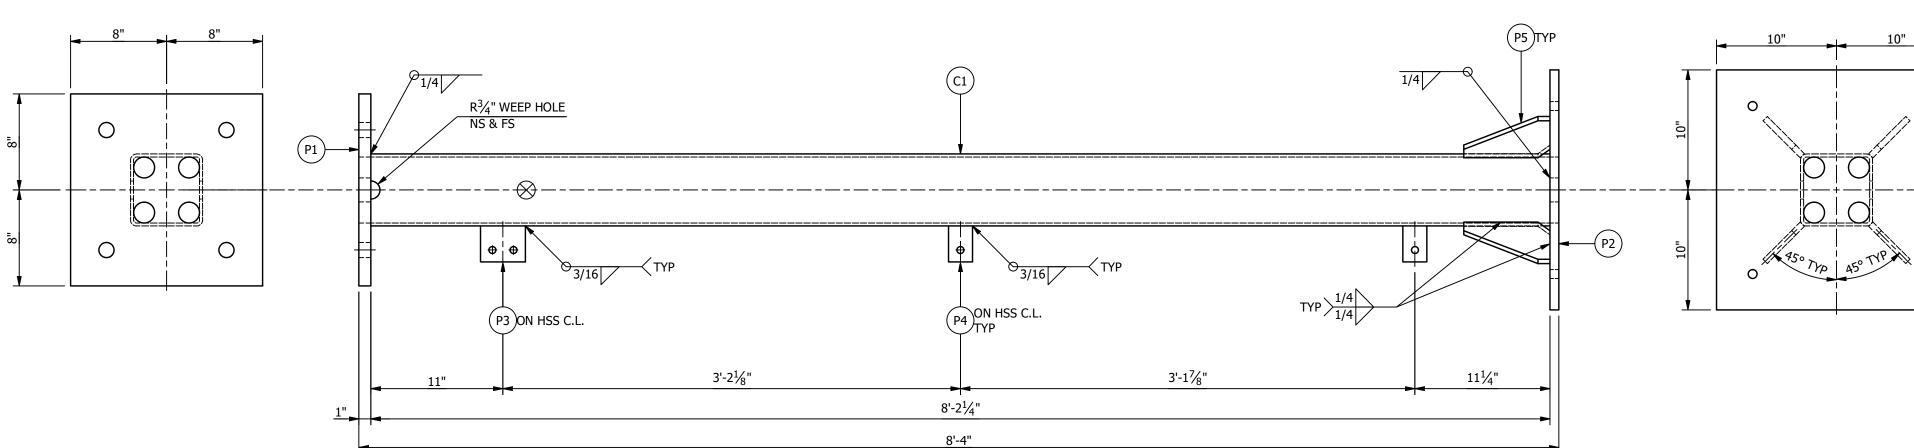

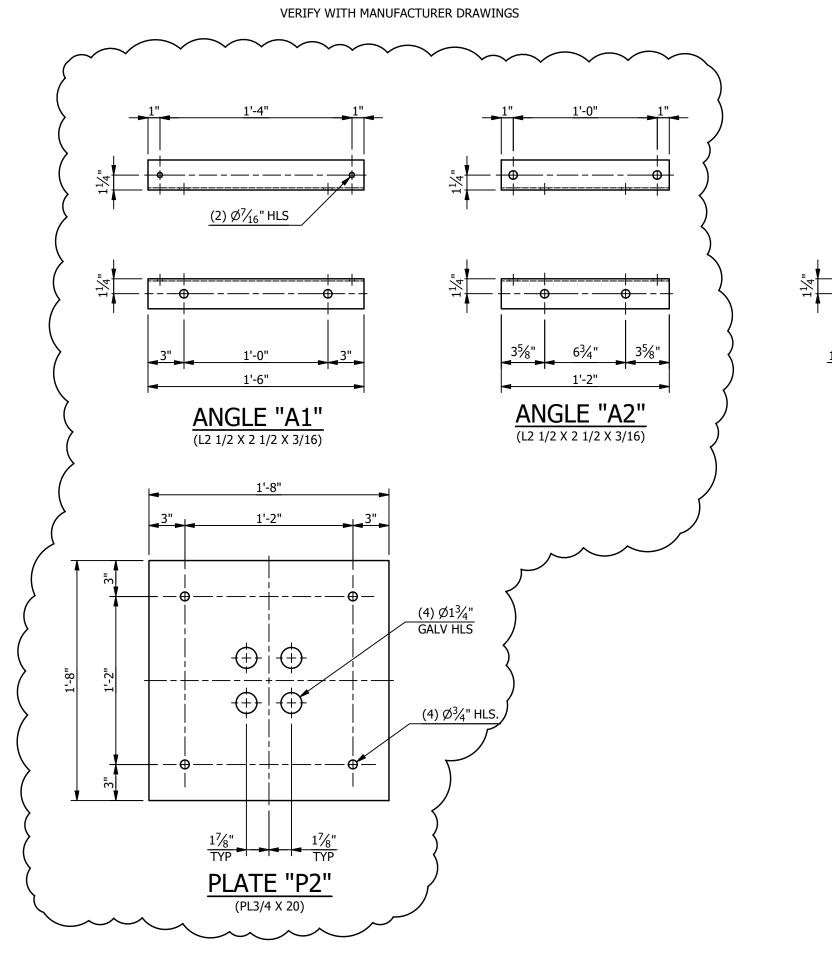

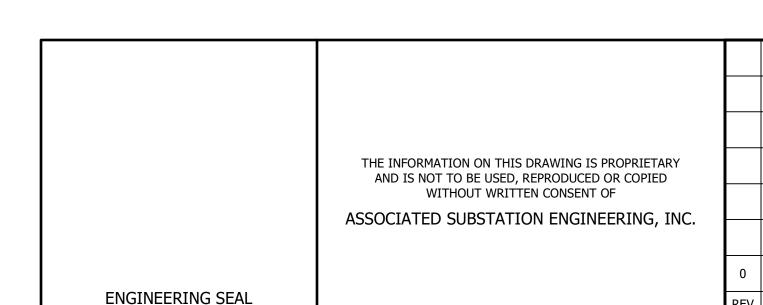

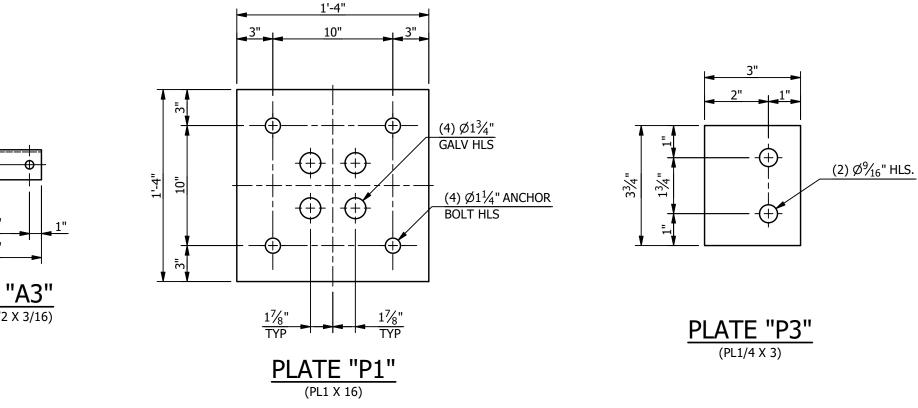


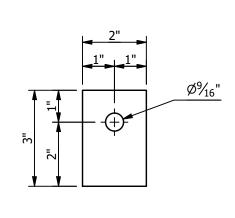


PLATE "P4" (PL1/4 X 3)

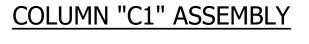

BILL OF MATERIAL

	MARK	QTY	DESCRIPTION	LENGTH	TOTAL WGT	
VERIFY	A1	2	L2 1/2 X 2 1/2 X 3/16	1'-6"	9.21	
VERIFY	A2	2	L2 1/2 X 2 1/2 X 3/16		7.16	
VERIFY	A3	2	L2 1/2 X 2 1/2 X 3/16	0'-8 3/4"	4.48	
	C1	1	HSS6 X 6 X 1/4	8'-2 1/4"	155.71	
	P3	1	PL1/4 X 3	0'-3 3/4"	.80	
VERIFY	P2	1	PL3/4 X 20	1'-8"	85.07	
	P1	1	PL1 X 16	1'-4"	72.59	
	P4	2	PL1/4 X 3	0'-2"	.85	
	P5	4	PL1/2 X 7 3/16	0'-4 3/8"	17.83	
-					T - 252 70 LPC	

TOTAL BLK WGT = 353.70 LBS. TOTAL GALV WGT = 366.08 LBS.

> > > > >

STRUCTURE BOLT ASSEMBLIES

QTY	DIA	LENGTH	DESCRIPTION
5	5/8"	0'-8 1/2"	5/8 GALV THREADED ROD W/ 2HHN, 2FW
4	5/8"	1 1/2"	GALV A325 HHB W/ GALV F436 HARDENED FW & GALV A563-DH HHN

SUFFIX ALL PIECE MARKS WITH "STRUCTURE DESIGNATION" THUS PIECE MARK XX BECOMES XXL

NOTES:

1. ALL ASTM A36 OR A992/A572 GRADE-50 STEEL UNLESS NOTED. ALL TUBING - ASTM A500 GRADE C. ALL STRUCTURAL PIPE - ASTM A53 GRADE-B.

2. ASTM A325 ERECTION BOLTS. USE THE SHORTEST BOLT THAT WILL ALLOW A F436 FLAT WASHER AND A A563 NUT.

3. ALL HOT DIP GALVANIZED AFTER FABRICATION (ASTM A123).

4. ALL HOLES **Ø11/16**" FOR **Ø5/8**" BOLTS UNLESS NOTED.

5. MINIMUM EDGE DISTANCE **7/8**" UNLESS NOTED.

6. PIECE MARK STAMPED INTO METAL WITH NOT LESS THAN 3/8" HIGH CHARACTERS BEFORE GALVANIZING.

7. ALL WELDING ELECTRODES SHALL BE E70XX.

8. \bigotimes MARK INDICATES PROPER ORIENTATION OF STRUCTURAL PIECES.

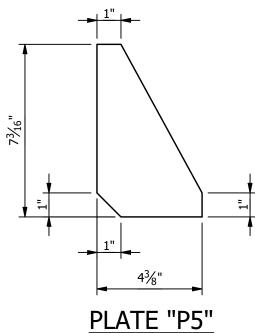


PLATE "P5" (PL1/2 X 7 3/16)

MAKE THIS SHEET

<u>"1" - TIME</u>

REFERENCE DRAWINGS DRAWING NUMBER DESCRIPTION STRUCTURE "L" COVER SHEET SL100 STRUCTURE "L" ELEVATIONS SL200 STRUCTURE "L" ASSEMBLIES & DETAILS (BILL OF MATERIAL) SL300 CITY OF DOVER BSTATION 69-12.47KV SUBSTATION STR. L - ASSEMBLIES & DETAILS DRAWING NUMBER JECT NUMBER APPROVED 47019 JKG WCB JKG SL300 NTS AUBREY SILVEY ENTERPRISES, INC. AUBREY SILVEY ENTERPRISES, INC. Engineer • Procure • Construct www.silvey.com/epc 770-537-1144 Www.aseng.com 770-537-0033 9/14/23 JRG JKG MR ISSUED FOR CONSTRUCTION REV DATE DRN CK APP DESCRIPTION